

August 24, 2015

MEMORANDUM

TO: District Board of Trustees

FROM: Jim Murdaugh, President

SUBJECT: Phase III Document Approval for the Gadsden Center project.

Item Description

This item requests Board of Trustees approval of the Phase III Construction Documents for the Gadsden Center project.

Overview and Background

Florida Statutes state that a Florida College System institution's board must approve the Phase III construction documents. In the case of the Gadsden Center, it was necessary to revise the construction documents after the preparation of the Guaranteed Maximum Price.

The project team revised the building structure from masonry bearing walls to a preengineered metal building frame in order to reduce cost. Although the building plans and elevations previously presented to the Board did not change, numerous other details in the construction documents were revised.

The construction documents have been reviewed by the College's technical staff for conformance with TCC standards and Building Code review is complete.

Past Actions by the Board

The Board approved the Guaranteed Maximum Price for the Gadsden Center project at the April 20, 2015 meeting.

Funding/Financial Implications

Funds for this project were provided from Fund Three - Auxiliary Services reserves.

Staff Resource

Barbara Wills

Recommended Action


Approve the Phase III construction documents for the Gadsden Center project.

100% CONSTRUCTION **DOCUMENTS**

TALLAHASSEE COMMUNITY COLLEGE

GADSDEN COUNTY CENTER

222 PAT THOMAS PKWY QUINCY, FLORIDA

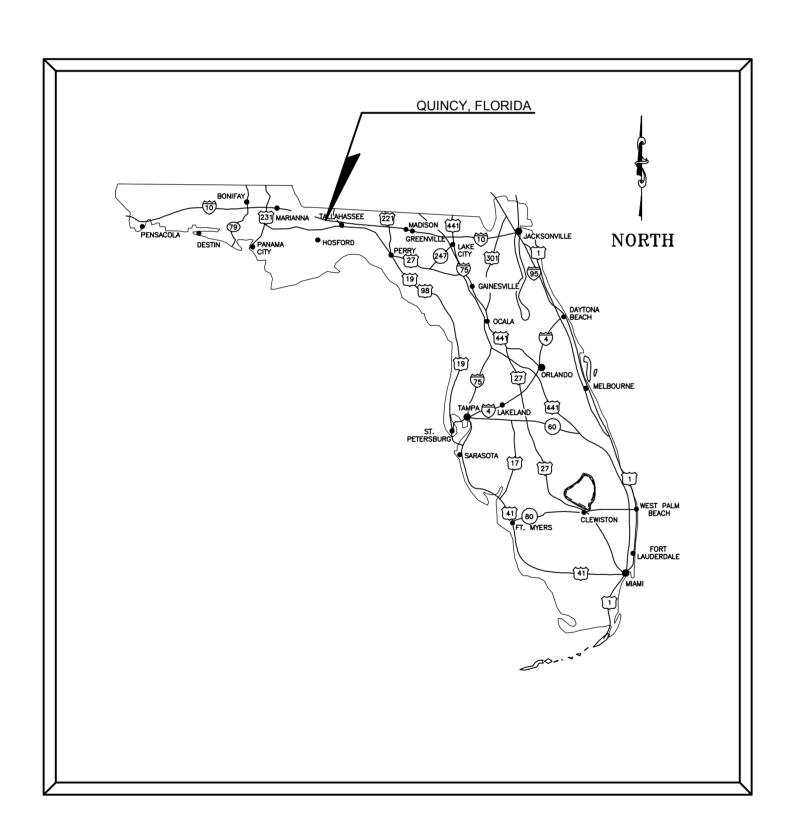


VICINITY MAP

PREPARED BY:



ROBERT D. GEORGE, P.E. DOUG J. GUTHRIE, P.E. ENGINEERING BUSINESS

1967 COMMONWEALTH LANE, SUITE 200 TALLAHASSEE, FL 32303 PHONE 850.521.0344 FAX 850.521.0345

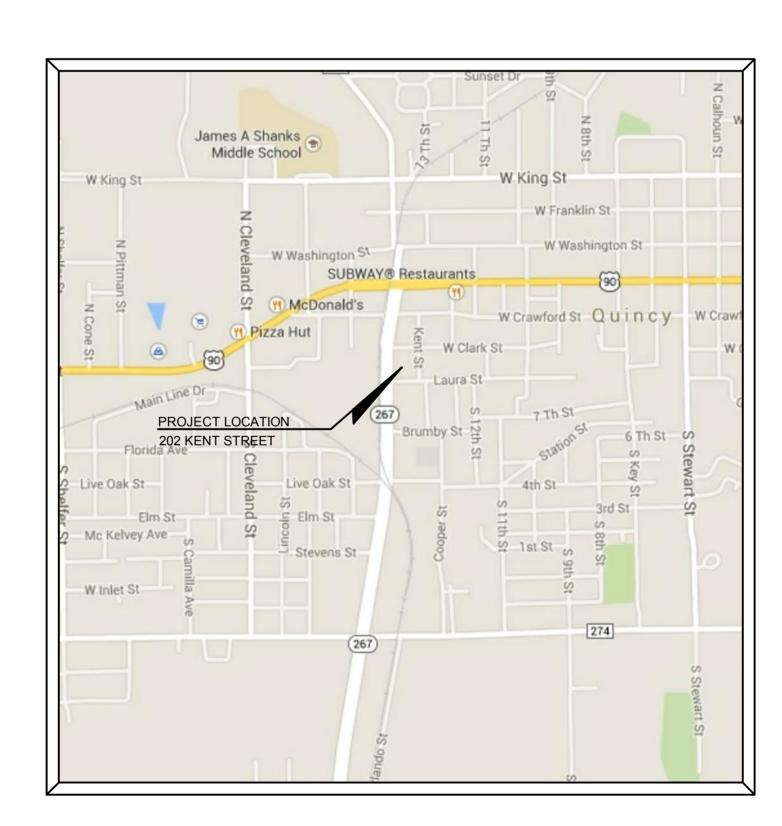

PROJECT LOCATION MAP

D	ALL REPORNOTES ATHE COMP	RTS, PLANS, SP IND OTHER DOO SULTANT AS IN OF THE CONS MON LAW, STA' INCLUDIN	POF INSTR ECIFICATIO CUMENTS A STRUMENT ULTANT. TH TUTORY AN IG THE COF CONS OCUN GEORG	UMENTS OF SE NS, COMPUTER ND INSTRUMEN S OF SERVICE: IE CONSULTAN D OTHER RESE PYRIGHT THERE TRUCTI MENTS E & Ass ng Engin TRANSPIRITATION: SO	RVICE R FILES, FIELD DA ITS PREPARED B SHALL REMAIN TH T SHALL RETAIN REVED RIGHTS, ETO. ON SOCIATES DEETS, Inc.
C	SEE COMMUNITY COLLEGE	THONE 850.		- rax 850.5	AS PKWY

JOSEPH	W. N	MLLER, P.E.			
		ida P.E. # 49889			
Revision					
Date	No.	Description:			
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Date	No.	Description:			

Checked By: JWM 10 JUNE 2015


Project No.: Drawing Title:

COVER PAGE

C 001

		TYPICAL ABBREVIATION	ONS	2		GENERAL NOTES	DRAWN	NG INDEX	
		THIONERBOREVIXII	5110			OLIVEIVE IVOI LO	Sheet Number	Sheet Title	
	A Area or Amperes AAA American Automobile Association	Fig. Figure Fin. Finish	Prog. Proj. PS & E	Program or Progression Project or Projection	CIVIL GENERAL NOTES:	GENERAL PROJECT NOTES:	C 001	Cover Sheet	▔▎▐▋▍▐▟▗▍▍
	ABC Asphalt Base Course Abd. Abandoned ABS Acrylonitrite-Butadiene-Styrene Pipe	FIR Found Iron Rod FIP Found Iron Pipe	PS & E PT PVC	Plans, Specifications And Estimates Point Of Tangency or Pressure Treated Polyvinyl Chloride	ALL WORK SHALL BE PERFORMED IN A SAFE MANNER. ALL SAFETY RULES AND GUIDELINES OF O.S.H.A. SHALL BE PERFORMED. THE CONTRACTOR SHALL BE WHOLLY RESPONSIBLE FOR ANY DAMAGE TO BRIGHT DEPORT OR PERSONS DURING THE	 UNLESS OTHERWISE INDICATED OR MODIFIED ON THE PLANS OR IN THE SPECIFICATIONS, THE FLORIDA DEPARTMENT OF TRANSPORTATION STANDARD SPECIFICATIONS FOR ROAD AND BRIDGE CONSTRUCTION, LATEST EDITION, SHALL BE THE GOVERNING SPECIFICATIONS FOR 	C 002	General Notes	
	AC, Ac. Acre Asph. Conc. Asphaltic Concrete Accel. Acceleration Act. Actuated	Flex. Flexible FNC Found Nail & Cap FNL Found Nail FOC Fiber Optics Cable	Prost. Prest. Proi	Point Of Reverse Curvature Precast Prestressed Project or Projection	INJURIES OF HIS EMPLOYEES, AND ANY DAMAGE TO PRIVATE PROPERTY OR PERSONS DURING THE COURSE OF THIS PROJECT. ALL COSTS ASSOCIATED WITH COMPLYING WITH O.S.H.A. REGULATIONS AND THE FLORIDA TRENCH SAFETY ACT (SEE NOTE 16) MUST BE INCLUDED IN THE CONTRACTOR'S PRICE FOR PERFORMING THE WORK.	CONSTRUCTION MATERIAL AND SITE WORK. 2) WHERE REFERENCE IS MADE TO A STANDARD INDEX OR DETAIL, THE FLORIDA DEPARTMENT OF	C 101 C 201	Exisitng Conditions Erosion Control	- uuy
	ADA The Americans With Disabilities Act Adh. Adhesive Adi. Adjust	FPM or fpm Feet Per Minute FRP Fiber Reinforced Pipe FPS or fps Feet Per Second	Q QPL	Peak Discharge or Flow Volume Qualified Products List	2) THE CONTRACTOR SHALL BE RESPONSIBLE FOR VISITING THE JOB SITE PRIOR TO PREPARING THE BID FOR THE PURPOSE OF FAMILIARIZING HIMSELF WITH WITH THE NATURE AND THE EXTENT OF	TRANSPORTATION ROADWAY AND TRAFFIC DESIGN STANDARDS, LATEST EDITION, SHALL BE USED AS IF A PART OF THIS PLAN.	C 301	Site Plan	
	ADT Average Daily Traffic AADT Annual Average Daily Traffic Agg. Aggregate	FR or Fr. Frame Frang. Frangible Freq. Frequency	R R or Rad.	Right Radius	THE WORK AND LOCAL CONDITIONS, EITHER SURFACE OR SUBSURFACE, WHICH MAY AFFECT THE WORK TO BE PERFORMED, AND THE EQUIPMENT, LABOR AND MATERIALS REQUIRED. FAILURE TO DO SO WILL NOT RELIEVE THE CONTRACTOR OF COMPLETE PERFORMANCE UNDER THIS CONTRACT.	3) THE CONTRACTOR SHALL COMPLY WITH ALL LOCAL, STATE AND FEDERAL REGULATIONS.4) CONTRACTOR SHALL PROVIDE GEORGE & ASSOCIATES CONSULTING ENGINEERS, INC. AS BUILT	C 401	Grading Plan	DAG ARCHITECTS INC. 1223 AIRPORT ROAD DESTIN, FLORIDA 32541
	AISC American Institute Of Steel Construction Alt. Alternate Al. Aluminum	FS, F.S. Far Side, Florida Statutes Ft. Foot or Feet FTB Floating Turbidity Barrier	R or Rng. RC RCP	Range Reverse Crown Reinforced Concrete Pipe	THE CONTRACTOR IS URGED TO TAKE COLOR PHOTOGRAPHS ALONG THE ROUTE OF THIS PROJECT TO RECORD EXISTING CONDITIONS PRIOR TO CONSTRUCTION, AND TO AID IN RESOLVING POSSIBLE FUTURE COMPLAINTS THAT MAY OCCUR DUE TO CONSTRUCTION OF THE PROJECT.	DRAWINGS OF FINISHED IMPROVEMENTS. 5) ALL UNDERGROUND UTILITIES SHALL BE FIELD LOCATED PRIOR TO THE BEGINNING OF	C 501	Drainage Plan	TELEPHONE: 850-837-8152 FAX 850-654-4276
D	ANSI American National Standards Institute AOS Apparent Opening Size Appl. Applied, Application	Fut. Future Galv. Galvanized	RCPA Rd. Rdsd.	Reinforced Concrete Pipe Arch Road or Round Roadside	3) ALL IMPROVEMENTS SHOWN ARE TO BE WARRANTED BY THE CONTRACTOR TO THE OWNER FOR A PERIOD OF ONE YEAR FROM DATE OF ACCEPTANCE BY THE OWNER.	CONSTRUCTION. CALL "ONE CALL" (1-800-432-4770) 6) CONTRACTOR SHALL MAINTAIN SUITABLE SEDIMENTATION AND EROSION STRUCTURES DURING ALL	C 601 C 701	Utility Plan Site Details	D FL# AA-C000745
	Approx. Approximate Artf. Artificial Asph. Asphalt Assem. Assembly	Ga. Gauge or Gage Ga. / Gal. Gallon GD Gutter Drain	Rdwy. Rect. Ref.	Roadway Reticuline or Rectangular Reference	THE CONTRACTOR SHALL COORDINATE THEIR CONSTRUCTION WITH ALL OTHER CONTRACTORS. IN THE EVENT OF ANY CONFLICT WHATSOEVER, THE CONTRACTOR SHALL NOTIFY THE ENGINEER AND	PHASES OF CONSTRUCTION. 7) CONTRACTOR SHALL PROVIDE ADEQUATE SIGNAGE TO DIRECT TRAFFIC AROUND CONSTRUCTION	C 801	Drainage Details	OWNERSHIP OF INSTRUMENTS OF SERVICE ALL REPORTS, PLANS, SPECIFICATIONS, COMPUTER FILES, FIELD DATA
	Assem. Assembly Assn. Association Assoc. Associate, Association ASTM American Society For Testing Materials	GP Galvanized Iron Pipe GM Gas Main GP Grade Point Gr. Grade, Guardrail or Grate	Reinf. Reloc. Reg	Region, Regular, Registered or Regulation Reinforced or Reinforcing Relocated Required	OWNER PRIOR TO PROCEEDING WITH CONSTRUCTION. 5) "AS-BUILT" DRAWINGS - AS-BUILT DRAWINGS ARE REQUIRED TO BE PROVIDED AND SIGNED AND	AREAS. ADEQUACY OF SIGNAGE SHALL BE APPROVED PRIOR TO CONSTRUCTION START. CONTRACTOR SHALL BE RESPONSIBLE FOR REMOVAL OF UNFORESEEN MATERIALS	LS 101	Landscape Plan	NOTES AND OTHER DOCUMENTS AND INSTRUMENTS PREPARED BY THE CONSULTANT AS INSTRUMENTS OF SERVICE SHALL REMAIN THE
	ATPB Asphalt Treated Permeable Base Attn. Attenuator Attnuatr. Attenuator	Gr. or Gro. Gross GRC Galvanized Rigid Steel Conduit Grd. Ground	RPM r/s RR	Raised Reflective Pavement Markers Revolution Per Second Railroad	SEALED BY A FLORIDA REGISTERED LAND SURVEYOR. THEREFORE, IT SHALL BE THE CONTRACTOR'S RESPONSIBILITY TO CONTRACT WITH A LAND SURVEYOR REGISTERED IN THE STATE OF FLORIDA FOR THE PREPARATION, FIELD LOCATIONS, CERTIFICATION, AND SUBMITTAL OF "AS-BUILT"	8) CONTRACTOR SHALL BE RESPONSIBLE FOR ALL ASPECTS OF JOB SITE SAFETY INCLUDING, BUT NOT LIMITED TO TEMPORARY FENCING, UTILIZATION OF MACHINERY WITH BRAKES, WARNING SIGNAGE ETCETERA.			PROPERTY OF THE CONSULTANT. THE CONSULTANT SHALL RETAIN ALL COMMON LAW, STATUTORY AND OTHER RESERVED RIGHTS,
	Aux. Auxiliary Ave. Avenue AWG American Wire Gauge	gross km Gross Kilometer Gr. Wt. Gross Weight Gttr. Gutter	Rt. R/W, ROW	Right Right Of Way	DRAWINGS. 6) "AS-BUILT" RECORD DATA AND INFORMATION SHALL BE MAINTAINED BY THE CONTRACTOR. RECORD	 CONTRACTOR IS RESPONSIBLE TO COMPLETELY REMOVE ALL DEMOLISHED MATERIALS NOT BEING SALVAGED FROM SITE AND DISPOSE OF PROPERLY. 			INCLUDING THE COPYRIGHT THERETO.
	AWS American Welding Society Az. Azimuth	Gy Gray HAR Highway Advisory Radio	S or s SAN or San. Sch.	Speed, South, Seimens, Or Second Sanitary Schedule	DRAWINGS SHALL BE SUPPLIED TO GEORGE & ASSOCIATES CONSULTING ENGINEERS, INC 7) THE CONTRACTOR IS RESPONSIBLE FOR PROTECTION OF ALL SURVEY AND PROPERTY MONUMENTS.	10) CONTRACTOR SHALL MAINTAIN A MINIMUM SLOPE OF 1.00% ON ALL IMPROVEMENTS. IF PROPOSED SLOPE IS LESS THAN 1.00% CONTRACTOR SHALL NOTIFY ENGINEER OF RECORD IMMEDIATELY.			100% CONSTRUCTION DOCUMENTS
	B to B Back to Back Bd. or Bnd. Bond or Bonded BE Burled Electric	HB Hay Bales HC Horizontal Clearance HD High Density or Heavy Duty	SCST SD SE	Sand—Clay Surface Treatment Side Drain, Storm Drain Southeast	IF A MONUMENT IS DISTURBED, THE CONTRACTOR SHALL CONTRACT WITH THE SURVEYOR OF RECORD FOR REINSTALLATION OF THE MONUMENT. 8) ALL DEBRIS RESULTING FROM ALL ACTIVITIES SHALL BE DISPOSED OF OFF-SITE BY CONTRACTOR	11) ALL DAMAGED DRIVEWAYS AND PAVING SHALL BE RESTORED TO ORIGINAL CONDITION PER FDOT STANDARDS.			George & Associates
	Bit. Bituminous Bk. Back BL. BLC Base Line Control	HD or Hd. Head Hdwl. Headwall Hndrl Handraïl Horiz. Horizontal	Seq. Serv. SF Sht	Sequential Service Silt Fence Sheet	ON A WEEKLY BASIS. 9) ALL EXCESS UNSUITABLE MATERIAL SHALL BE REMOVED FROM THE SITE BY THE CONTRACTOR	12) ALL RESTORATION OF UNPAVED AREAS SHALL BE WITH SOD.			Consulting Engineers, Inc.
_	Bldg. Building Blkhd. Bulkhead Blvd. Boulevard	HP High Pressure or Horsepower Hr. Hour HS High Strength	Shidr. SHW Spec.	Shoulder Seasonal High Water Specification	UNLESS DIRECTED OTHERWISE. 10) ALL EXISTING TREES TO REMAIN SHALL BE PRESERVED AND PROTECTED, EXCEPT FOR REMOVAL	13) MAINTENANCE OF TRAFFIC SHALL CONFORM TO FLORIDA DEPARTMENT OF TRANSPORTATION ROADWAY AND TRAFFIC DESIGN STANDARDS AS SPECIFIED IN STANDARD INDEX 600 THRU 666.			ENGINEERING BUSINESS NO. 7879 1967 Commonwealth Lane, Suite 200, Tallahassee, FL 32303
	BM Bench Mark Bndry. Boundary Bdr. Border	HSHV High Strength Horizontal Vertical Ht. Height HW or H.W. High Water or Hot Water	Sq. Ft.,/S.F. Sq. In. Sq. Yd.,/S.Y.	Square Foot Square Inch Square Yard	AS REQUIRED FOR CONSTRUCTION. 11) THE LOCATION OF ALL EXISTING UTILITIES, STRUCTURES, AND IMPROVEMENTS SHOWN ON THE	14) CONTRACTOR SHALL POST SIGN THAT STATES THE FOLLOWING: "THIS AREA IS A DESIGNATED CONSTRUCTION SITE, AND ANYONE WHO TRESPASSES ON THIS PROPERTY COMMITS A FELONY".			PHONE 850.521.0344 - FAX 850.521.0345
	Bot. Bottom BO Basin Outlet BOS Beginning Of Survey	Hwy. Highway Hyd. Hydrant or Hydraulic	SR or S.R. SRD SS	State Road State Road Department Sanitary Sewer	DRAWINGS IS BASED ON LIMITED INFORMATION AND MAY NOT HAVE BEEN FIELD VERIFIED. THE LOCATIONS ARE APPROXIMATE. THE CONTRACTOR SHALL NOTIFY RESPECTIVE UTILITY OWNERS AND FIELD VERIFY LOCATIONS OF EXISTING UTILITIES AND OTHER IMPROVEMENTS PRIOR TO	15) ADDITIONAL FILTER FENCES OR HAY BALES SHALL BE CONSTRUCTED AS NECESSARY, IN ADDITION TO THOSE SHOWN, TO PROTECT ADJACENT PROPERTY FROM SEDIMENTATION DURING CONSTRUCTION. ALL STOCKPILE AREAS SHALL BE SURROUNDED BY SILT FENCE. TEMPORARY			ш
	Br. Briage Brg. Bearing Brkwy. Breakaway BT Buried Telephone Cable or Duct	ID Inside Diameter or Identification IMC Intermediate Metal Conduit Inc. Incorporated or Including	St. or ST. Sta. Std.	Street Station Standard	COMMENCING ANY CONSTRUCTION. IF THE LOCATIONS SHOWN ARE CONTRARY TO THE ACTUAL FIELD LOCATIONS, THE CONTRACTOR SHALL NOTIFY THE OWNER AND ENGINEER OF THE DISCREPANCY. THE DISCREPANCY SHOULD BE RESOLVED PRIOR TO COMMENCING CONSTRUCTION.	BERMS SHALL BE CONSTRUCTED OR GRADING CONSTRUCTED AS NECESSARY TO DIRECT RUNOFF TO THE S.W.M.F. PRIOR TO INSTALLATION OF DRAINAGE PIPES.			
	BW Barbed Wire, Bottom Width or Both Ways C/G Curb And Gutter	Incl. or Inc. Included Ind. Industry or Industrial INV. or Inv. Invert IP Iron Pipe	Stl. Sub. or Subst. Subgr. SUR or Sur.	Subgrade	THE CONTRACTOR SHALL EXERCISE EXTREME CAUTION WHEN WORKING IN AREAS NEAR EXISTING UTILITIES AND IMPROVEMENTS AND SHALL BE RESPONSIBLE FOR AND SHALL REPAIR OR PAY FOR ALL DAMAGE MADE TO EXISTING UTILITIES OR OTHER IMPROVEMENTS. PRIOR TO COMMENCEMENT OF ANY CONTRACTOR SUBJECT OF THE PROPERTY AND	16) IT'S THE CONTRACTOR'S RESPONSIBILITY TO ENSURE THAT THE HANDICAP RAMPS AND ACCESSIBLE WALKWAYS BE CONSTRUCTED IN ACCORDANCE WITH THE DESIGNATED DETAILS AND USE THE CURRENT FOOT INDEX THAT IS REFERENCED ON THE CONSTRUCTION PLANS. UPON			<u> </u>
	C/G Curb And Gotter CA Coarse Aggregate Cap. Capacity CAP Corrugated Aluminum Pipe	Install. Installed Isect. Intersection Isl. Island	SUR or Sur. Surf.	Survey Surface	OF ANY CONSTRUCTION, THE CONTRACTOR SHALL VERIFY ALL GRADES, INVERTS, AND TYPE OF MATERIAL OF EXISTING UTILITIES TO WHICH HE SHALL CONNECT. 12) THE CONTRACTOR SHALL SUBMIT SHOP DRAWINGS IF REQUIRED ON ALL MATERIALS. FOR REVIEW	LAYOUT OF PROPOSED RAMPS OR ACCESSIBLE WALKWAY IF THE CONTRACTOR IDENTIFIES A CONFLICT WITH THE REQUIRED STANDARDS IT WILL BE THE CONTRACTOR' RESPONSIBILITY NOTIFY THE ENGINEER PRIOR TO CONSTRUCTION SO APPROPRIATE FIELD ADJUSTMENTS CAN BE PROVIDED. IF THE CONTRACTOR DOES NOT NOTIFY THE ENGINEER THEN IT WILL BE THE			
	Caps. Capital Letters CASP Corrugated Aluminized Steel Pipe CATV Cable Television	IR Iron Rod ITE Institute Of Transportation Engineers J Joule	T TBM TC	Tangent, Length Of Curve, Temporary Bench Mark Tangent To Curve	12) THE CONTRACTOR SHALL SUBMIT SHOP DRAWINGS IF REQUIRED ON ALL MATERIALS, FOR REVIEW AND APPROVAL, PRIOR TO PURCHASE OR CONSTRUCTION OF ANY UTILITY PIPE OR STRUCTURE. 13) UNSUITABLE MATERIALS BENEATH WATER AND SEWER PIPE AND/OR STRUCTURES SHALL BE	PROVIDED. IF THE CONTRACTOR DOES NOT NOTIFY THE ENGINEER THEN IT WILL BE THE CONTRACTOR'S RESPONSIBILITY TO RECONSTRUCT THE RAMPS OR ACCESSIBLE WALKWAY AT THE CONTRACTOR'S EXPENSE IN ACCORDANCE WITH THE STANDARD DETAILS.			
	CB Catch Basin CBC Concrete Box Culvert CBS Concrete Box Structure	JB Junction Box Jct. Junction Jt. Joint	TCB TCE TCP	Temporary Concrete Barrier Temporary Construction Easement Terra Cotta Pipe	REMOVED AND REPLACED WITH SELECTED BACK FILL PROPERLY COMPACTED IN ACCORDANCE WITH SPECIFICATIONS.	CONSTRUCTION SEQUENCE:			
С	CC, C/C, Center to Center, Crash Cushion CCEW Center to Center Each Way CD Cross Drain, Cross Direction (Geotextiles)	K Design Hour Factor or Kelvin kg/m Kilogram Per Meter	TCZ TDLC Tel.	Traffic Control Zone Transportation Design For Livable Communities Telephone	14) ALL WATER & SEWER CONSTRUCTION SHALL BE ACCOMPLISHED BY AN UNDERGROUND UTILITY CONTRACTOR LICENSED UNDER THE PROVISIONS OF CHAPTER 489 FLORIDA STATUTES.	THE CONTRACTOR SHALL REQUEST AN ON-SITE PRE-CONSTRUCTION CONFERENCE WITH THE			
	Cern. Cemetery CFS Cubic Feet Per Second CI Cast Iron CIP Cast Iron Pipe	kg/m2 Kilogram Per Square Meter kg/m3 Kilogram Per Cubic Meter Kilo One Thousand Kip 1000 Pounds	Temp. Thick. Tn. Trans	Temperature or Temporary Thickness Ton Transition, Transverse,	15) CONTRACTOR SHALL PROVIDE SEDIMENT AND EROSION CONTROL DURING THE ENTIRE DURATION OF THE PROJECT. ALL JURISDICTIONAL WETLANDS SHALL BE PROTECTED FROM SEDIMENTATION AND EROSION AS WELL AS ENCROACHMENT OF ANY KIND. ANY WETLAND JURISDICTIONAL LINES ARE	ENGINEER OF RECORD AND THE GADSDEN COUNTY ENVIRONMENTAL COMPLIANCE INSPECTOR 72 HOURS PRIOR TO ANY COMMENCEMENT OF CONSTRUCTION ACTIVITIES. 2) POST ALL APPLICABLE PERMIT PLACARDS. THE PERMIT PLACARDS SHALL NOT BE NAILED TO			
	CIPL Cast In Place cir. or circ. Circle or Circular circ. Circumference	kn Knot L Length, Length Of Curve, Liter, Left	TS TSC TTC	Tangent To Spiral Length Of Tangent (Spiral Curve) Temporary Traffic Control	SHOWN ON THE PLANS FOR REFERENCE. CONTRACTOR SHALL MEET THE REQUIREMENTS SET FORTH BY THE FLORIDA DEPARTMENT OF ENVIRONMENTAL PROTECTION AND THE U.S. ARMY CORPS OF ENGINEERS AS RELATED TO JURISDICTIONAL WETLANDS.	TREES. 3) FLAG OR STAKE THE PROPOSED LIMITS OF CLEARING.			
	Cl. or Clear Clearance CL, Center Line CM Concrete Monument	Lat. Lateral or Latitude Lb. Pound Ib/sy Pounds Per Square Yard	Typ. Upass.	Typical Underpass	16) CONTRACTOR SHALL COMPLY WITH THE CURRENT FLORIDA TRENCH SAFETY ACT (90 96, LAWS OF FLORIDA) AND THE OSHA EXCAVATION SAFETY STANDARDS 29, CFR PART 1926.650 SUBPART P.	4) CONSTRUCT TREE BARRICADES OR FENCES AROUND PROTECTED TREES IN THE VICINITY OF ANY VEHICULAR TRAFFIC.			
	CMB Concrete Median Barrier CMP Corrugated Metal Pipe CMPA Corrugated Metal Pipe Arch	LBR Limerock Bearing Ratio LC Long Chord Lin. Linear	UG UL Ultd.	Underground Underwriters Laboratories Unlimited	WHERE TRENCH EXCAVATION EXCEEDS 5 FT IN DEPTH, SEE LAWS OF FLORIDA, CHAPTER 90-96. A) THE CONTRACTOR SHALL PROVIDE WRITTEN ASSURANCE OF COMPLIANCE WITH THIS LAW.	5) CONSTRUCT SEDIMENTATION CONTROL DEVICES PER EROSION CONTROL PLAN.			≥
	CO Clean Out Col. Column Conc. Concrete Const. Construct or Construction	Im Lumen Lmrk. Limerock LOS Limit Of Clear Sight	Unddr. Undrdwy. USC & GS	Underdrains Underroadway US Coast and Geodetic Survey	B) A SEPARATE COST ITEM IDENTIFYING THE COST OF COMPLIANCE. C) A TRENCH SAFETY SYSTEM SHALL BE DESIGNED BY THE CONTRACTOR.	6) THE GADSDEN COUNTY ENVIRONMENTAL COMPLIANCE INSPECTOR MUST APPROVE THE INSTALLATION OF EROSION CONTROLS AND STAKED LIMITS OF CONSTRUCTION PRIOR TO DISTURBANCE ACTIVITIES.			
	Cont. Continuation Contr. Contractor Coord. Coordinate	Loc., LO Location Long. Longitude LS Length Of Spiral LT Left Turn	USGS USPS	US Geological Survey United States Postal Service Utilities	17) CONTRACTOR SHALL COMPLY WITH STORM WATER POLLUTION PREVENTION PLAN. A COPY OF THIS PLAN AND FORMS ARE INCLUDED IN THE SPECIFICATIONS.	7) DESIGNATE VEHICULAR PATHWAYS WITHIN THE LIMITS OF THE SITE.			
	Corr. Corrugated CP Concrete Pipe CPE Corrugated Polyethylene Pipe	Lt. Left Ltd. Lighted or Limited Lum. Luminaire	V Var.	Volt, Velocity, Volume or Hourly Volume Varies, Variable or Variance		8) DESIGNATE EMPLOYEE PARKING AREAS, MATERIALS STORAGE AREAS, AND TOPSOIL STORAGE AREAS.			
_	Crs. or Cse. Course CS Curve To Spiral CSP Corrugated Steel Pipe	L/W Lightweight Maint. Maintenance	VC VCP Vert.	Vertical Curve Vitrified Clay Pipe Vertical	S & E CONTROL NOTES	 CONSTRUCT ALL IMPROVEMENTS AS INDICATED IN THE PLANS AND SPECIFICATIONS. REMOVE ALL STOCKPILE FROM SITE, INSTALL LANDSCAPING. SOD ALL DISTURBED AREAS. 			上EE O A A A
	CT Clear Trunk CTPB Cement Treated Permeable Base Ctr. Center Culv. Culvert	Matl. Material Max. Maximum Med. Median	Vh Vol. VP	Verified Horizontal Location Volume Vertical Panel	additional measures will be added if determined to be needed by on-site inspections. LIMITS OF CLEARING SHALL NOT EXTEND BEYOND PROPERTY LINES.	11) CONTRACTOR SHALL PROVIDE GADSDEN COUNTY PLANNING DEPARTMENT, ARCHITECT AND GEORGE & ASSOCIATES AS—BUILT DRAWINGS OF ALL FINISHED IMPROVEMENTS INCLUDING			
	CY Cubic Yard D Degree Of Curvature, Depth,	MES Mitered End Section Mfg. Manufactured or Manufacturer MH, M.H. Manhole, Mounting Height	VPD or Vpd. VPH or Vph. VPHPL or Vphp VPMS	Vehicles Per Day Vehicles Per Hour ol. Vehicles Per Hour Per Lane Volts Root Mean Sauare	3) SEDIMENT BARRIER (Sd1) SHALL CONSIST OF STAKED STRAW BALES AND OR FILTER FENCE.	STORMWATER AND LANDSCAPE IMPROVEMENTS. AS-BUILT DRAWINGS WILL BE SUBMITTED PRIOR TO FINAL CLOSEOUT. 12) FIELD INSPECTION AND CLEAN UP.			
	Density, Distance, Diameter or Directional Distribution	MHW Mean High Water Mi. Mile Mid. Middle Min. Minimum or Minute	VV VW	Verified Vertical Elevation Variable Width	4) SOIL EROSION WILL BE MONITORED DAILY AND GIVEN PARTICULAR ATTENTION AFTER RAINFALL. 5) THE ESCAPE OF SEDIMENT FROM THE SITE SHALL BE PREVENTED BY THE INSTALLATION OF EDOCION CONTROL MESSIBLES AND PRACTICES PRIOR TO OR CONCURRENT WITH	12) FIELD INSPECTION AND CLEAN OF.			
	DA Deflection Angle DBH Diameter At Breast Height DbI. Double	Misc. Miscellaneous MLW Mean Low Water Mobl. Mobilization	W WB Wb.	Width, Wide, West or Watt Westbound Weber	EROSION CONTROL MEASURES AND PRACTICES PRIOR TO, OR CONCURRENT WITH, LAND-DISTURBING ACTIVITIES 6) EROSION CONTROL MEASURES WILL BE MAINTAINED AT ALL TIMES. IF FULL IMPLEMENTATION OF	ADA COMPLIANCE NOTES:			│ │ ┌ │
	DCS Degree Of Curvature (Spiral) DD Dry Density / Design Document Deg. Degree	Mod. Modify or Modified Mon. Monument MOT Maintenance Of Traffic	WB40 WB50 WB60	Intermediate Semi Trailer Large Semi Trailer Tandem Semi Trailer	THE APPROVED PLAN DOES NOT PROVIDE FOR EFFECTIVE EROSION CONTROL, ADDITIONAL EROSION AND SEDIMENT CONTROL MEASURES SHALL BE IMPLEMENTED TO CONTROL OR TREAT THE SEDIMENT SOURCE.	 CONTRACTOR AND OWNER WILL BE HELD ACCOUNTABLE DURING CONSTRUCTION FOR COMPLIANCE WITH THE 2010 FLORIDA ACCESSIBILITY CODE (WITH 2012 SUPPLEMENTS) FOR ALL SITE IMPROVEMENTS. IF INCORRECT AT THE FINAL INSPECTION, CONTRACTOR WILL BE 			
	Dept. Department Det. Detour, Detection, Detectable DGN or Dgn. Design DHV Design Hourly Volume	MSL Mean Sea Level Mtd. Mounted MUTCD Manual On Uniform Traffic Control Device	WM WT WWF	Water Main Water Table Or Weight Welded Wire Fabric	7) ANY DISTURBED AREA LEFT EXPOSED FOR A PERIOD GREATER THAN 14 DAYS SHALL BE STABILIZED WITH MULCH OR TEMPORARY SEEDING.	REQUIRED TO MODIFY CONSTRUCTION TO COMPLY WITH THE FOLLOWING: 2) PARKING SPACE(S) SHALL BE 12' WIDE WITH WHITE STRIPING OUTER LINE, BLUE STRIPING			
	DHW Design High Water Dia, or D Diameter Dim. Dimension	MUTS Manual On Uniform Traffic Studies N North or Newton NA or N/A Not Available or Not Applicable	X X Rd. Xing.	Coordinate Value (East-West Direction) or Ext Cross Road Crossing	8) 24 HOUR CONTACT FOR EROSION CONTROL: THE SITE CONTRACTOR SHALL BE THE CONTACT FOR	INNER LINES.			
В	Dist. Distance Disp. Disposal DOT Department Of Transportation	NAVD National American Vertical Datum NC National Coarse or Normal Crown NEMA National Electrical Manufacturers Association	Xsec. Y	Cross Section Coordinate Value (North-South Direction)	24 HOUR EROSION CONTROL. 9) CONTRACTOR SHALL FILE AND RECEIVE A NOTICE OF INTENT (NOI) PERMIT AS PART OF THE	 ACCESSIBLE PARKING SPACES SERVING A BUILDING SHALL BE LOCATED ON THE SHORTEST SAFELY ACCESSIBLE ROUTE OF TRAVEL FROM ADJACENT PARKING TO AN ACCESSIBLE ENTRANCE. 			D 849
В	DR Design Review Driv. Driven Drwy. Driveway	NGVD National Geodetic Vertical Datum of 1929 NGS National Geodetic Survey NHS National Highway System			NPDES (NATIONAL POLLUTANT DISCHARGE ELIMINATION SYSTEM). 10) THE NOI SHALL BE APPLIED FOR NOT LESS THAN 96 HOURS BEFORE CONSTRUCTION.	4) PARKING SPACE AND ACCESS AISLE SHALL BE LEVEL (NOT TO EXCEED 1:50 SLOPE IN ANY DIRECTION.			
	DS Design Speed DSL Design Service Life Dwg. Drawing	NHW Normal High Water NIC Not In Contract NTS Not To Scale NW Northwest			11) CONTRACTOR SHALL PROVIDE THE NOI TO OWNER AND ENGINEER UPON RECEIPT. SEE FDEP WEBSITE OR CALL 245-7522.	 ACCESS AISLE(S) SHALL BE 5' WIDE WITH REQUIRED DIAGONAL STRIPING IN APPROVED BLUE MARKING PAINT. 			
	E East or External Distance e Rate Of Superelevation E to E End to End	NW Northwest Opass Overpass O to O, Out to Out			AC DUUT / DECORD DRAWINGS.	 CURB RAMP SLOPES IN COMPLIANCE WITH CODE (NOT TO EXCEED 1:12 SLOPE IN ANY DIRECTION). 			
	EA or Ea. Each EB Eastbound EI. or Elev. Elevation	OA Overall O.B.G. Optional Base Group OC or O.C. On Center			AS BUILT / RECORD DRAWINGS: 1) CONTRACTOR SHALL PROVIDE GEORGE & ASSOCIATES CONSULTING ENGINEERS, INC. AS BUILT	7) CURB RAMPS SHALL NOT ENCROACH ACCESS AISLE.8) APPROVED H/C SIGN AT PROPER MOUNTING HEIGHT (7' FROM GRADE TO BOTTOM OF SIGN).			
	Elec. Electric Ellip. Elliptical Engr. Engineer EOS End Of Survey or Equivalent Opening Size	OD or O.D. Outside Diameter OE Overhead Electric OH, Overhead			DRAWINGS OF FINISHED IMPROVEMENTS. UPON APPROVAL BY GEORGE AND ASSOCIATES, CONTRACTOR SHALL PROVIDE AS—BUILT DRAWINGS TO THE GADSDEN PLANNING DEPARTMENT.	9) SIGN INDICATING \$250 FINE.			
	EOS End Of Survey or Equivalent Opening Size EOP Edge Of Pavement Eq. Equation or Equal Equip. Equipment	Opt. Option, Optional or Optically OT Overhead Telephone Oz. Ounce			AS BUILT DRAWINGS SHALL INCLUDE, BUT NOT BE LIMITED TO: A) FINISHED FLOOR ELEVATIONS FOR ALL BUILDINGS	10) DETECTABLE WARNINGS AT HAZARDOUS VEHICULAR AREAS. 11) IF A WALK CROSSES OR ADJOINS A VEHICULAR WAY, AND THE WALKING SURFACES ARE NOT			JOSEPH W. MILLER, P.E.
	Esmt. Easement Exist. Existing Exp. Expansion	P Passenger Car & Light Delivery Truck Part. Participation or Partition Pavt. Pavement			B) DETAIL OF THE POND CONTROL STRUCTURE INCLUDING STRUCTURE TYPE, STRUCTURE SIZE, INVERT OF ALL PIPES, ORIFICES, WEIRS AND THE INVERT CONNECTIONS AT OFF—SITE CONVEYANCE SYSTEMS, GRATES AND SKIMMERS.	SEPARATED BY CURBS, RAILINGS, OR OTHER ELEMENTS BETWEEN THE PEDESTRIAN AREAS AND VEHICULAR AREAS, THE BOUNDARY BETWEEN THE AREAS SHALL BE DEFINED BY A CONTINUOUS DETECTABLE WARNING THAT IS 36 IN. WIDE, COMPLYING WITH §11-4.29.2.			State of Florida P.E. # 49889 Revision
	F or Final Final Quantity F & I Furnish & Install	PC Point Of Curvature PE Professional Engineer Ped Pedestrian or Pedestal			C) DETAIL OF SAND FILTER CONSTRUCTION DETAILS SHOWING SIND FILTER CROSS SECTION, INVERTS AND SIZES OF UNDERDRAIN PIPES AT EACH CLEAN OUT. THE ELEVATION OF THE TOP OF EACH	0.000000 000000000000000000000000000000			Date No. Description:
_	F to F Face to Face FA Federal Aid or Fine Aggregate FAC Florida Administrative Code FAP Federal Aid Project	Pen. Penetration PG Profile Grade PGL Profile Grade Line			CLEANOUT, THICKNESS OF SAND AND GRAVEL. D) POND CONSTRUCTION DETAILS SHOWING THE POND TOPOGRAPHY, TOP OF THE POND	GADSDEN SPECIFICATION NOTES: 1) WATER DISTRIBUTION SYSTEM CONSTRUCTION SHALL COMPLY WITH THE LATEST TECHNICAL			
	FAP Federal Aid Project FC Friction Course FD French Drain Fdn. Foundation	pH Measure Of Acidity or Alkalinity PI Point Of Intersection PL or P L Property Line or Plate POB Point of Beainnina			BERM/WALL AND POND BOTTOM ELEVATIONS AND THE LOCATION OF SAND FILTERS. E) SHOW ENTIRE STORMWATER CONVEYANCE SYSTEM INCLUDING THE SIZE TYPE AND INVERT OF	PROVISIONS FOR CONSTRUCTION OF WATER DISTRIBUTION SYSTEM ISSUED BY THE SERVICE PROVIDER.			
	FFE Finish Floor Elevation Fed. Federal Fert. Fertilizer	POC Point Of Commencement POST Point On Semi-Tangent POT Point On Tangent			ALL PIPES, CHANNELS, ROOF DRAIN SYSTEMS, STRUCTURES, CURBING AND SPOT SHOT ELEVATIONS IN VEHICLE USE AREAS.	 SEWER SYSTEM CONSTRUCTION SHALL COMPLY WITH THE LATEST TECHNICAL PROVISIONS FOR CONSTRUCTION OF SANITARY SEWER SYSTEM ISSUED BY THE SERVICE PROVIDER. 			
	FES Flored End Section FETS Flored End Terminal Section FH Fire Hydrant	PRC Point Of Reverse Curvature Prest. Prestressed Prob. Probability			F) SHOW ALL SIDEWALK AND VEHICLE USE AREAS. G) SHOW ALL TRAFFIC CONTROL DEVICES INCLUDING SIGNS, SIGNALS, PARKING STRIPPING AND	3) SANITARY SEWER LIFT STATTION CONSTRUCTION SHALL COMPLY WITH THE LATEST TECHNICAL PROVISIONS FOR CONSTRUCTION OF SANITARY SEWER SYSTEM LIFT STATION ISSUED BY THE			
	FHWA Federal Highway Administration	Prod. Product, Production, Producer or Produced			PAVEMENT MARKINGS. H) SITE DATA TABLE TO INCLUDE IMPERVIOUS AREAS, URBAN FOREST AREAS, GREEN SPACE AREAS,	SERVICE PROVIDER. 4) SOLID WASTE PICK-UP SHALL BE PROVIDED THROUGH THE COUNTY'S SOLID WASTE PROVIDER			
					AND NUMBER OF PARKING SPACES. I) POST CONSTRUCTION TREE SURVEY INCLUDING LOCATION, SIZE AND SPECIES OF ALL URBAN	UNLESS A SPECIFIC EXEMPTION IS GRANTED.			Drawn By: CKC
					FOREST AND REPLANT TREES. J) DELINEATE CONSERVATION AND DRAINAGE EASEMENT BOUNDARIES AND LABEL WITH THE "OR"				Checked By: JWM
					BOOK AND PAGE NUMBER.				Date : 10 JUNE 2015
Α									Project No.: 14033
									Drawing Title: GENERAL NOTES
									Drawing No.:
									1 Stawning No.: C 002

Carter Chapman 7/27/2015 P:\Projects\14-5237\Drawings\Civil\C 002 General Notes.dw

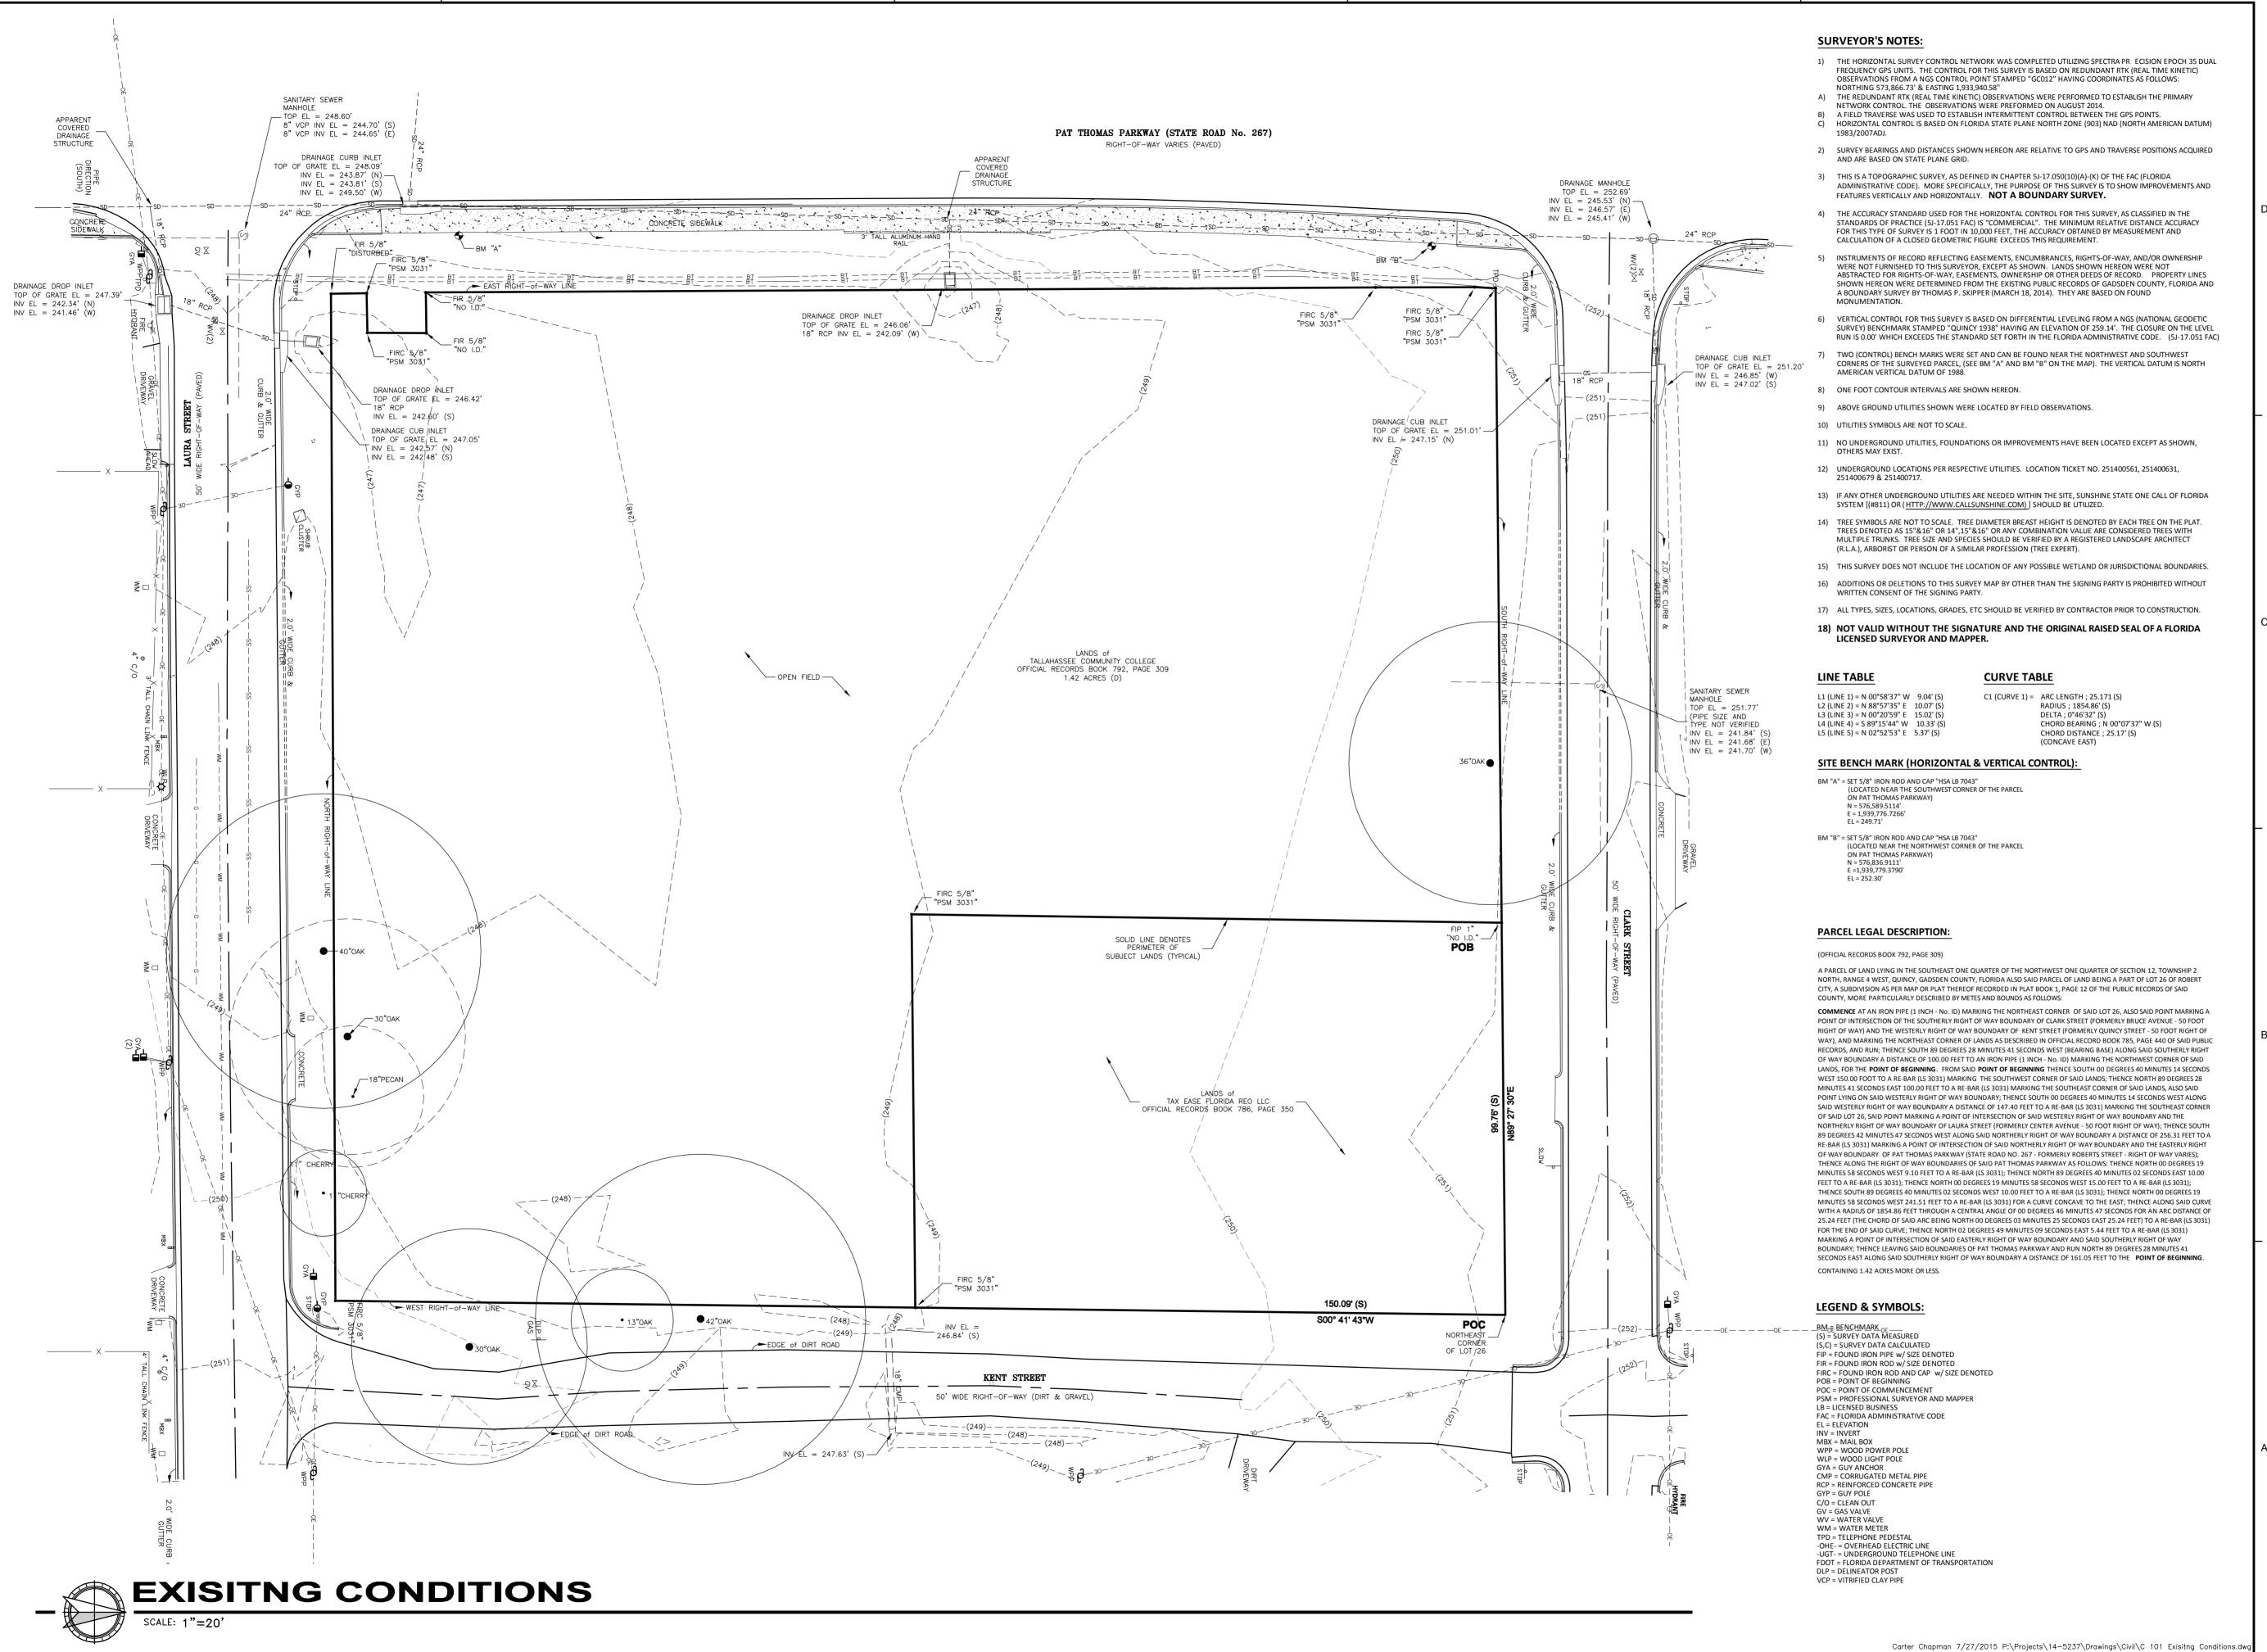

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DOCUMENTS George & Associates

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JOSEPH W. MILLER, P.E.

Date No. Description:

Revision

Drawn By:

Checked By:

Project No.:

State of Florida P.E. # 49889


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LJR

JWM

14033


10 JUNE 2015



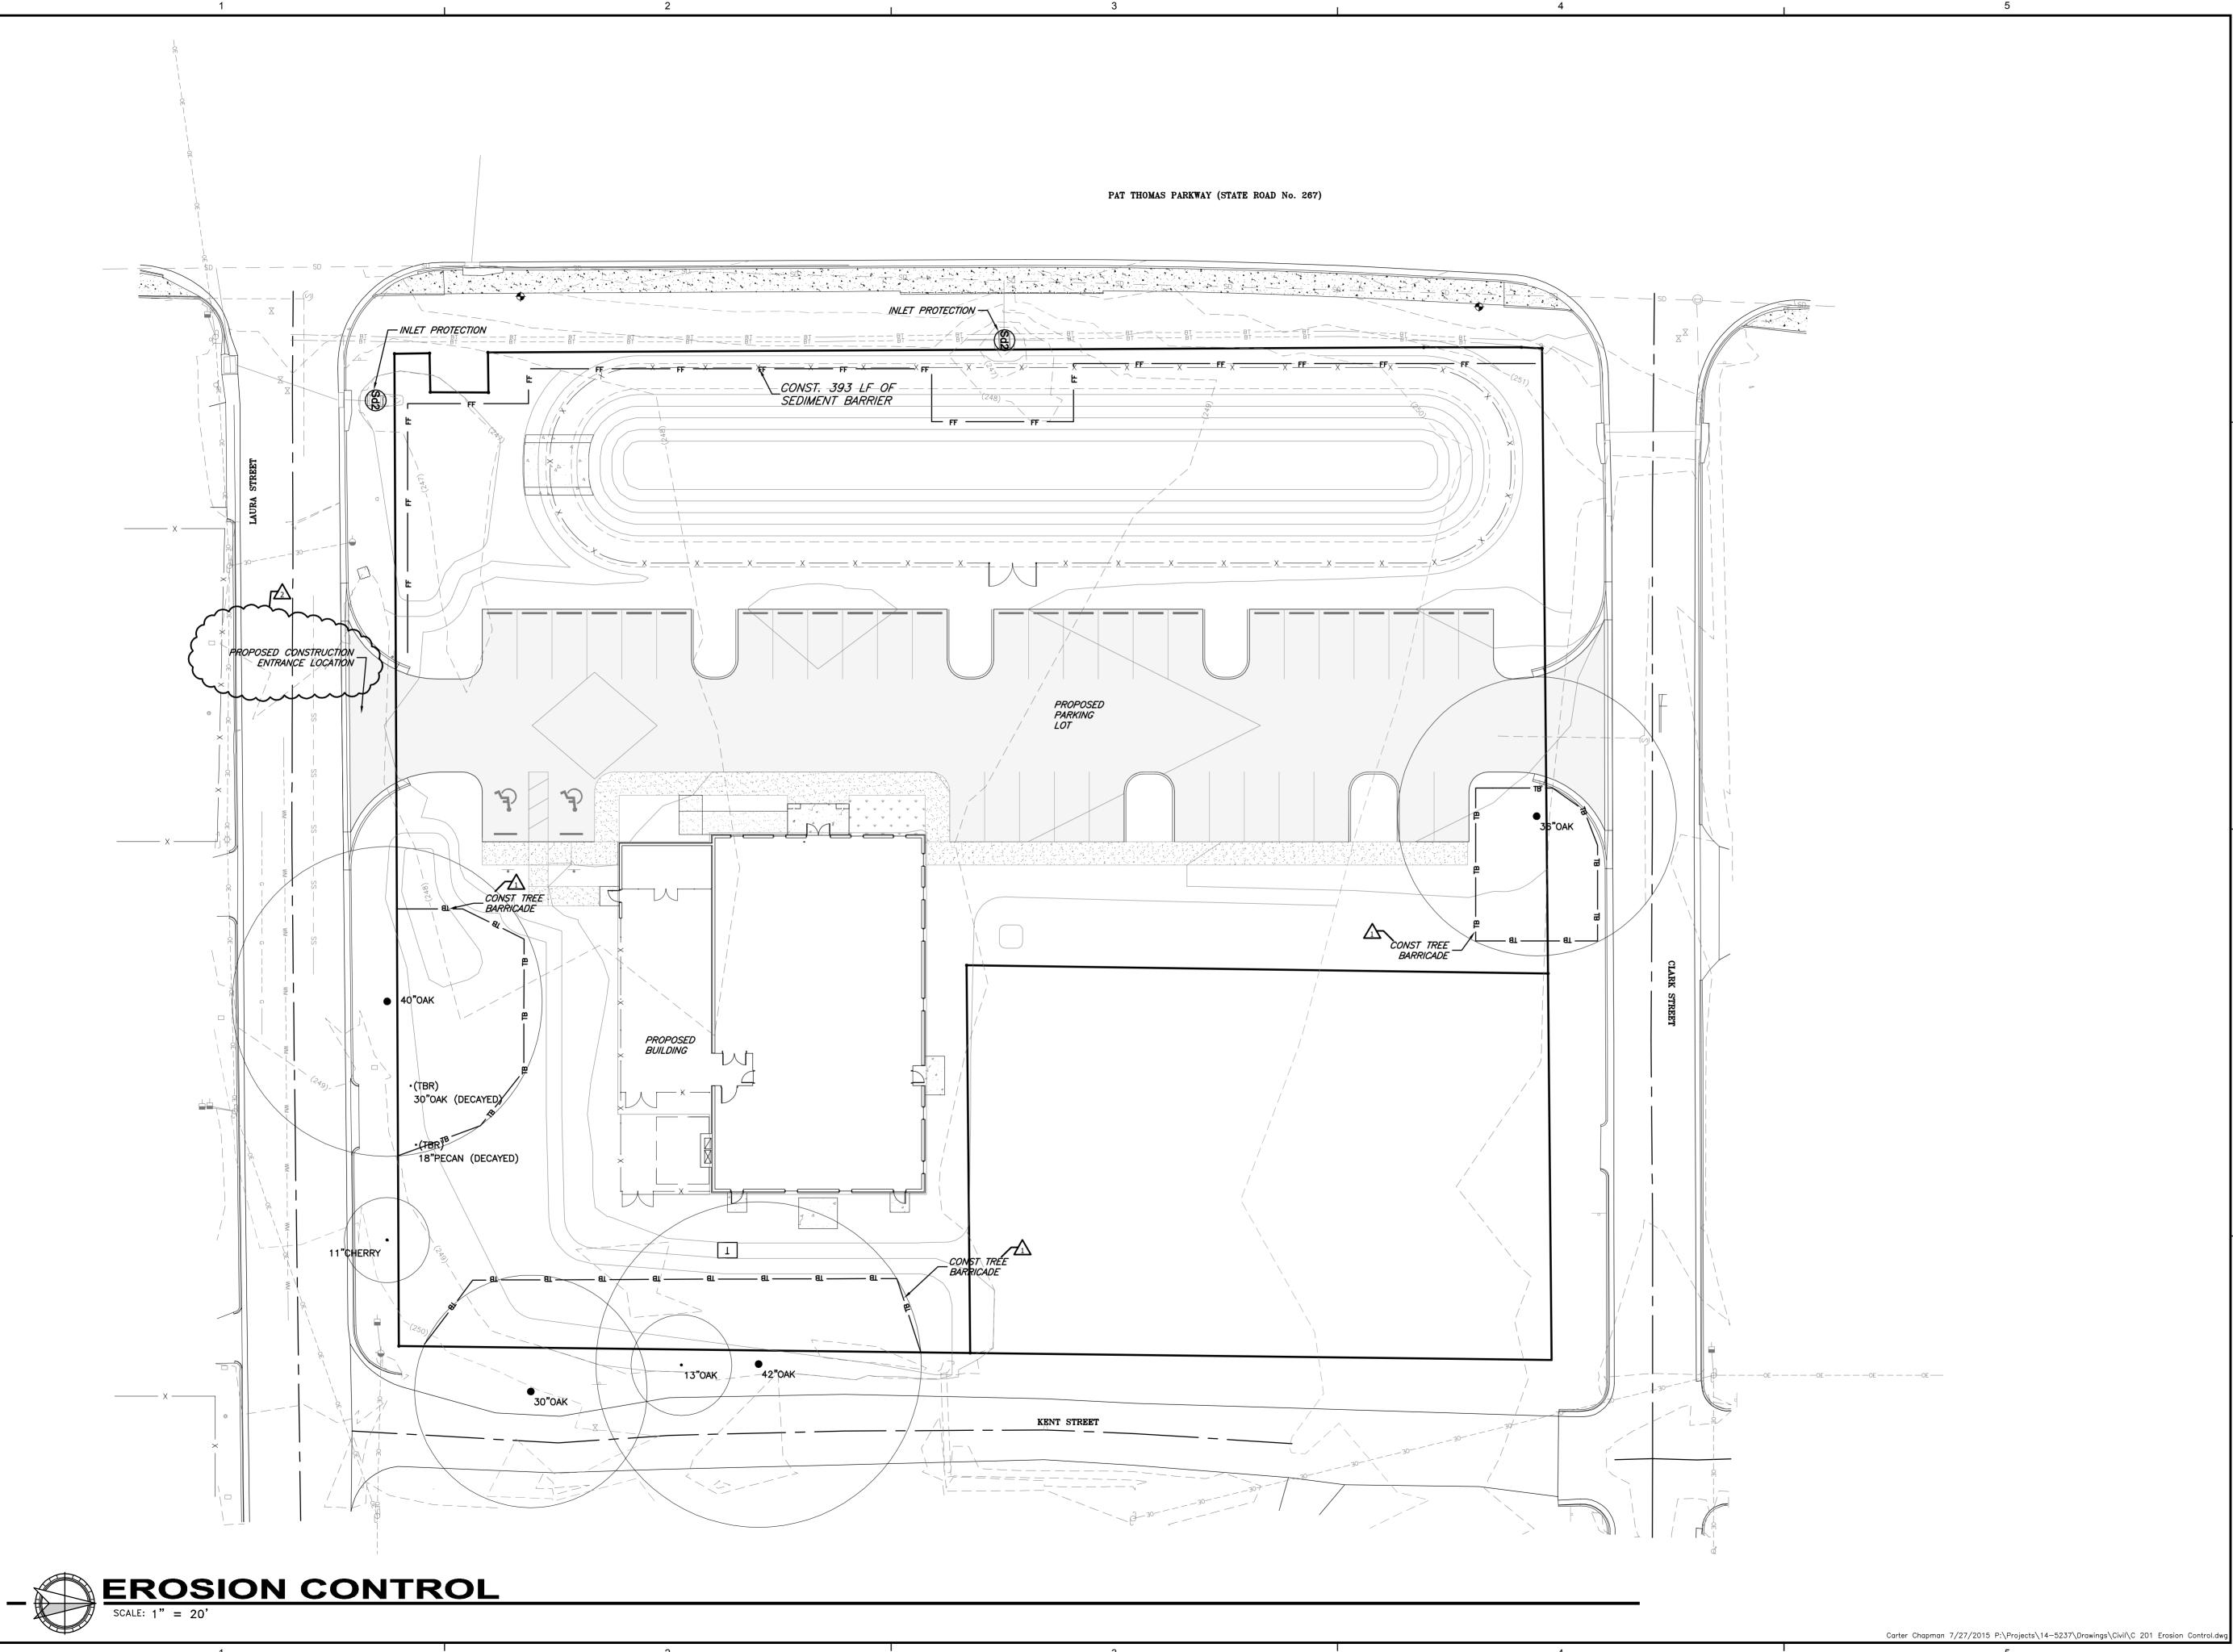

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TALLAHASSEE COMMUNITY COLLEG GADSDEN COUNTY CENTER

JOSEPH W. MILLER, P.E. State of Florida P.E. # 49889

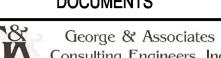Revision

DateNo.Description:3/19/20151EXPANDED TREE BARICADES3/19/20152CONSTRUCTION ENTRANCE LOCATION

222 PAT QUINCY,

Drawn By: LJR
Checked By: JWM

Date: 10 JUNE 2015


Project No.:

Drawing Title: EROSION CONTROL

Drawing No

C 201


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TALLAHASSEE COMMUNITY COLLEGADSDEN COUNTY CENTER

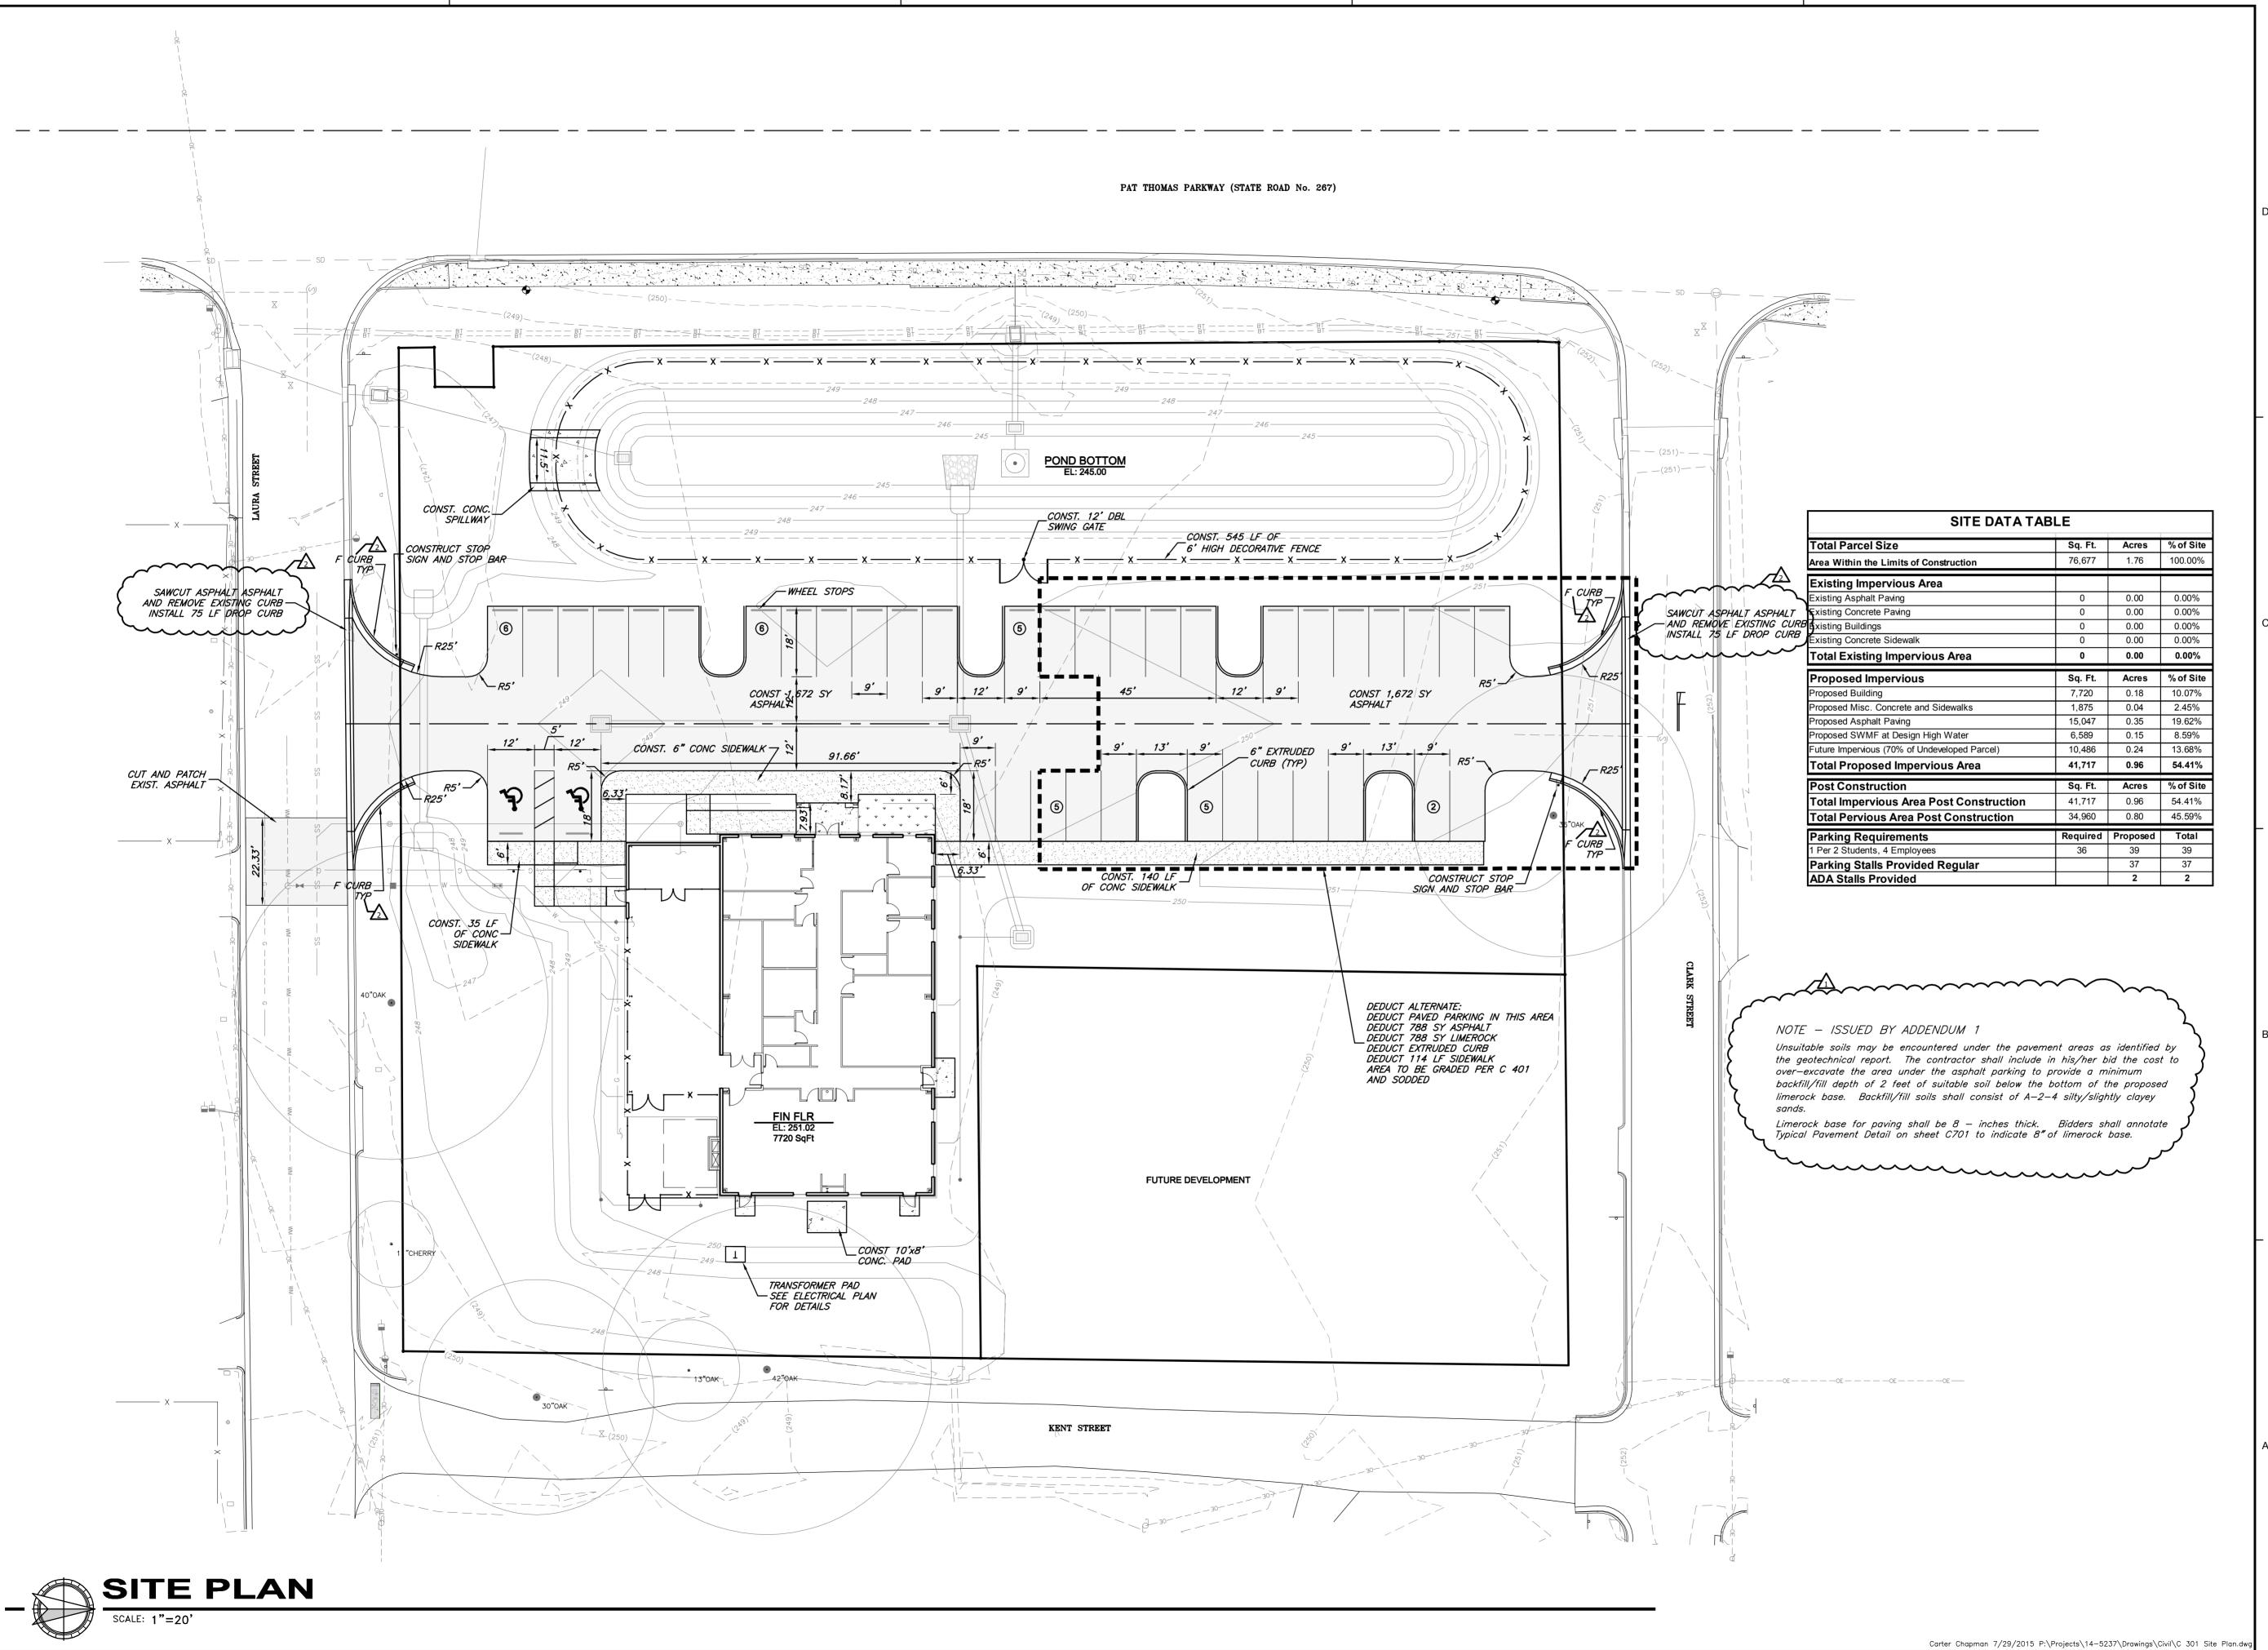JOSEPH W. MILLER, P.E. State of Florida P.E. # 49889

Revision

 Date
 No.
 Description:

 3/19/2015
 1
 ADDENDUM 1

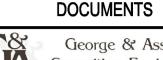 3/19/2015
 2
 ADD CURB

 3/19/2015
 3
 ADDED ISLAND CURB

 6/23/2015
 4
 ADJUST FOR NEW BUILDING FOOTPRINT

Drawn By: LJR
Checked By: JWM


Date: 10 JUNE 2015
Project No.: 14033

Drawing Title:

SITE PLAN

Drawing No


C 301

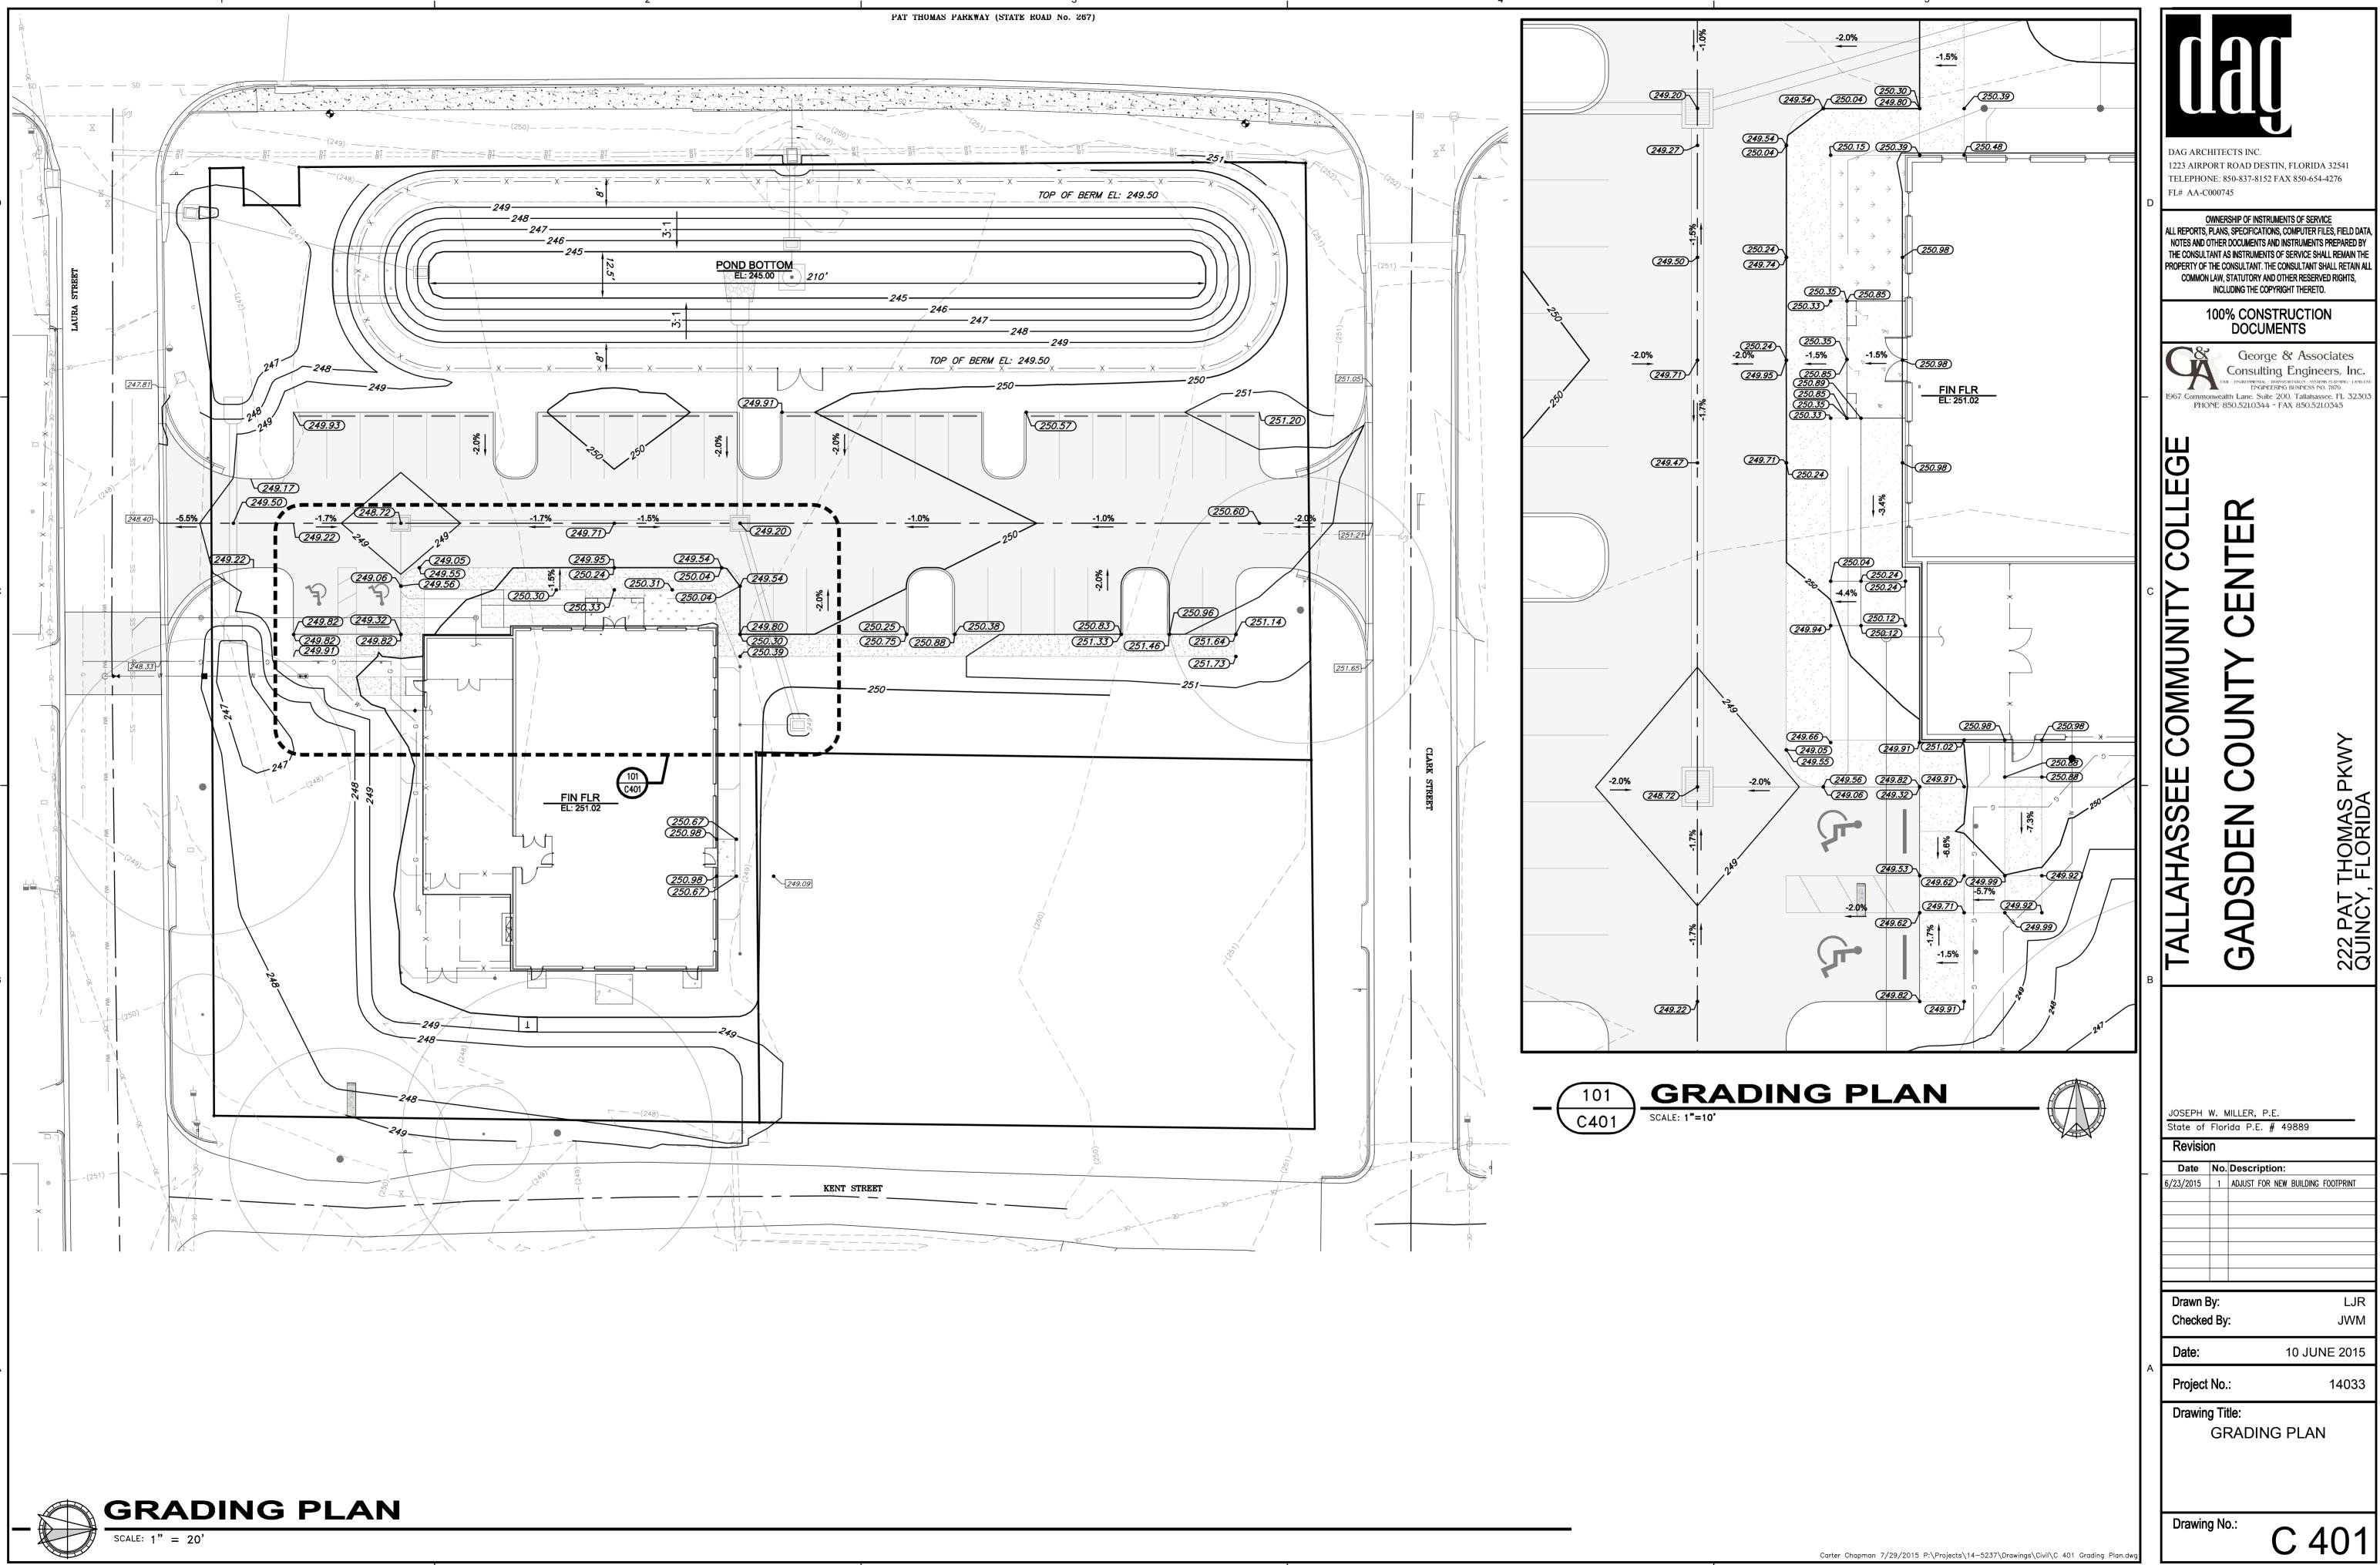

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C 401



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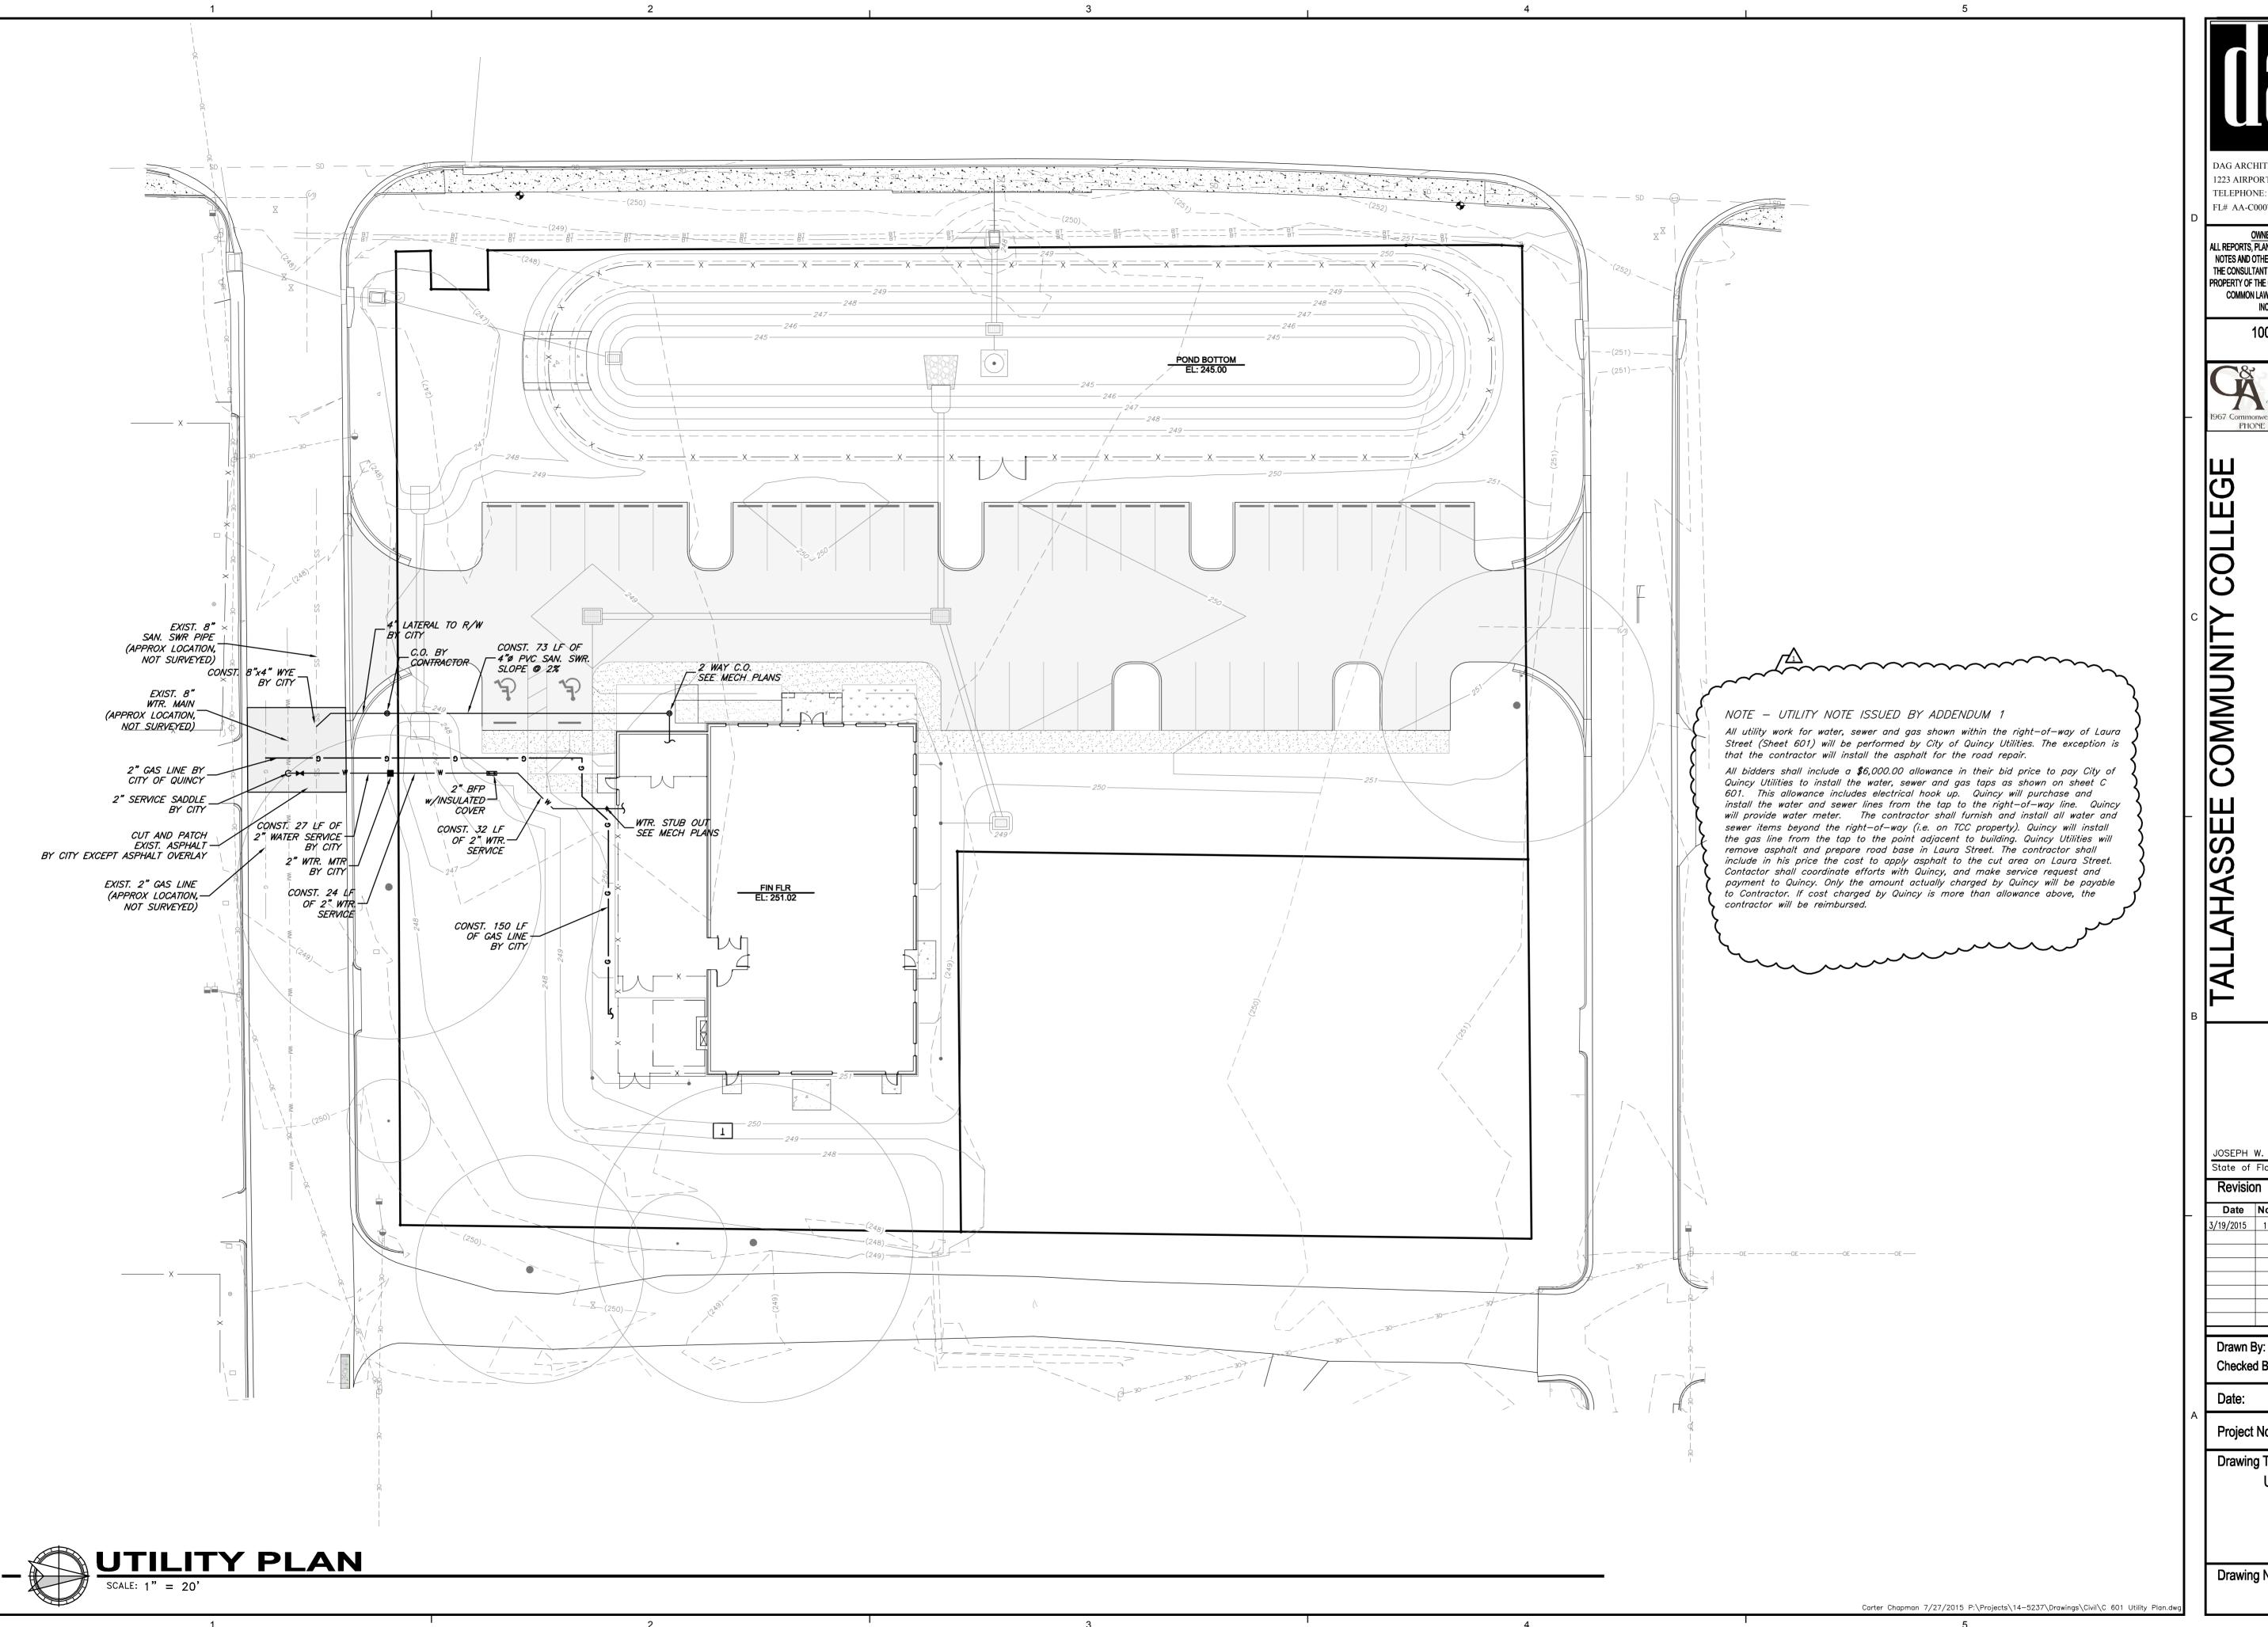
Date No. Description:

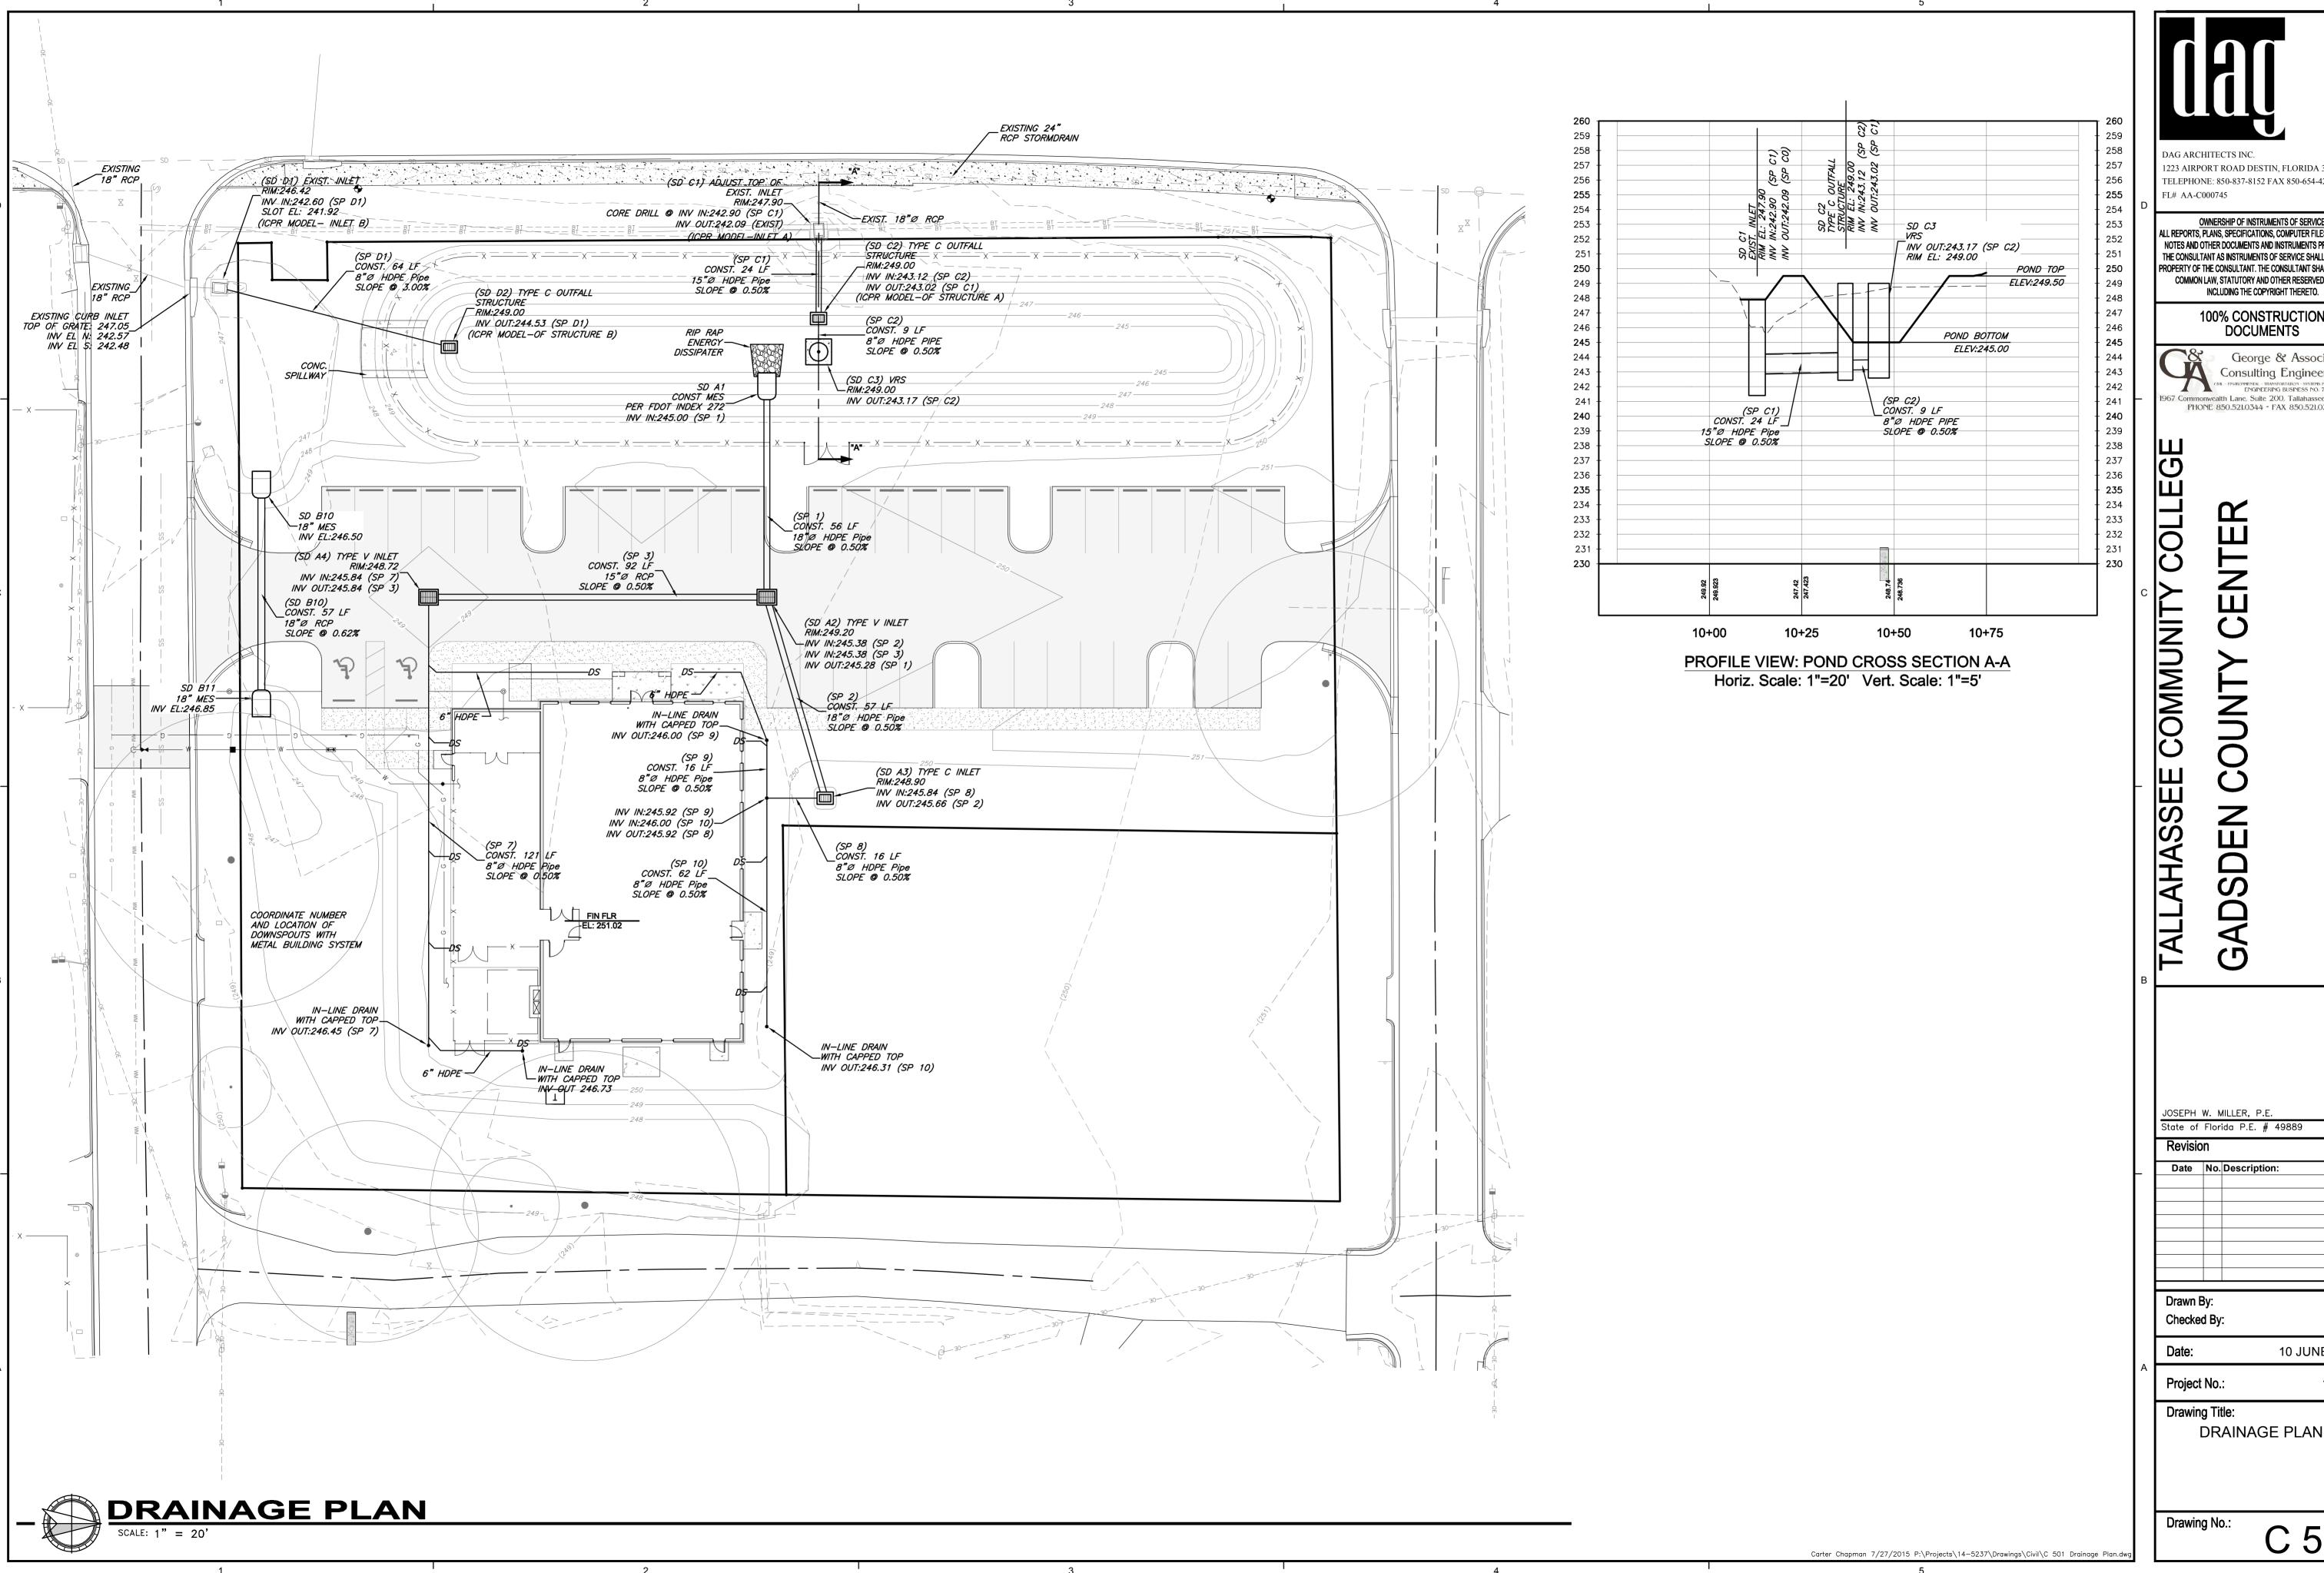LJR JWM

10 JUNE 2015

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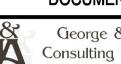
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Revision

Date No. Description:

JWM Checked By 10 JUNE 2015

LJR


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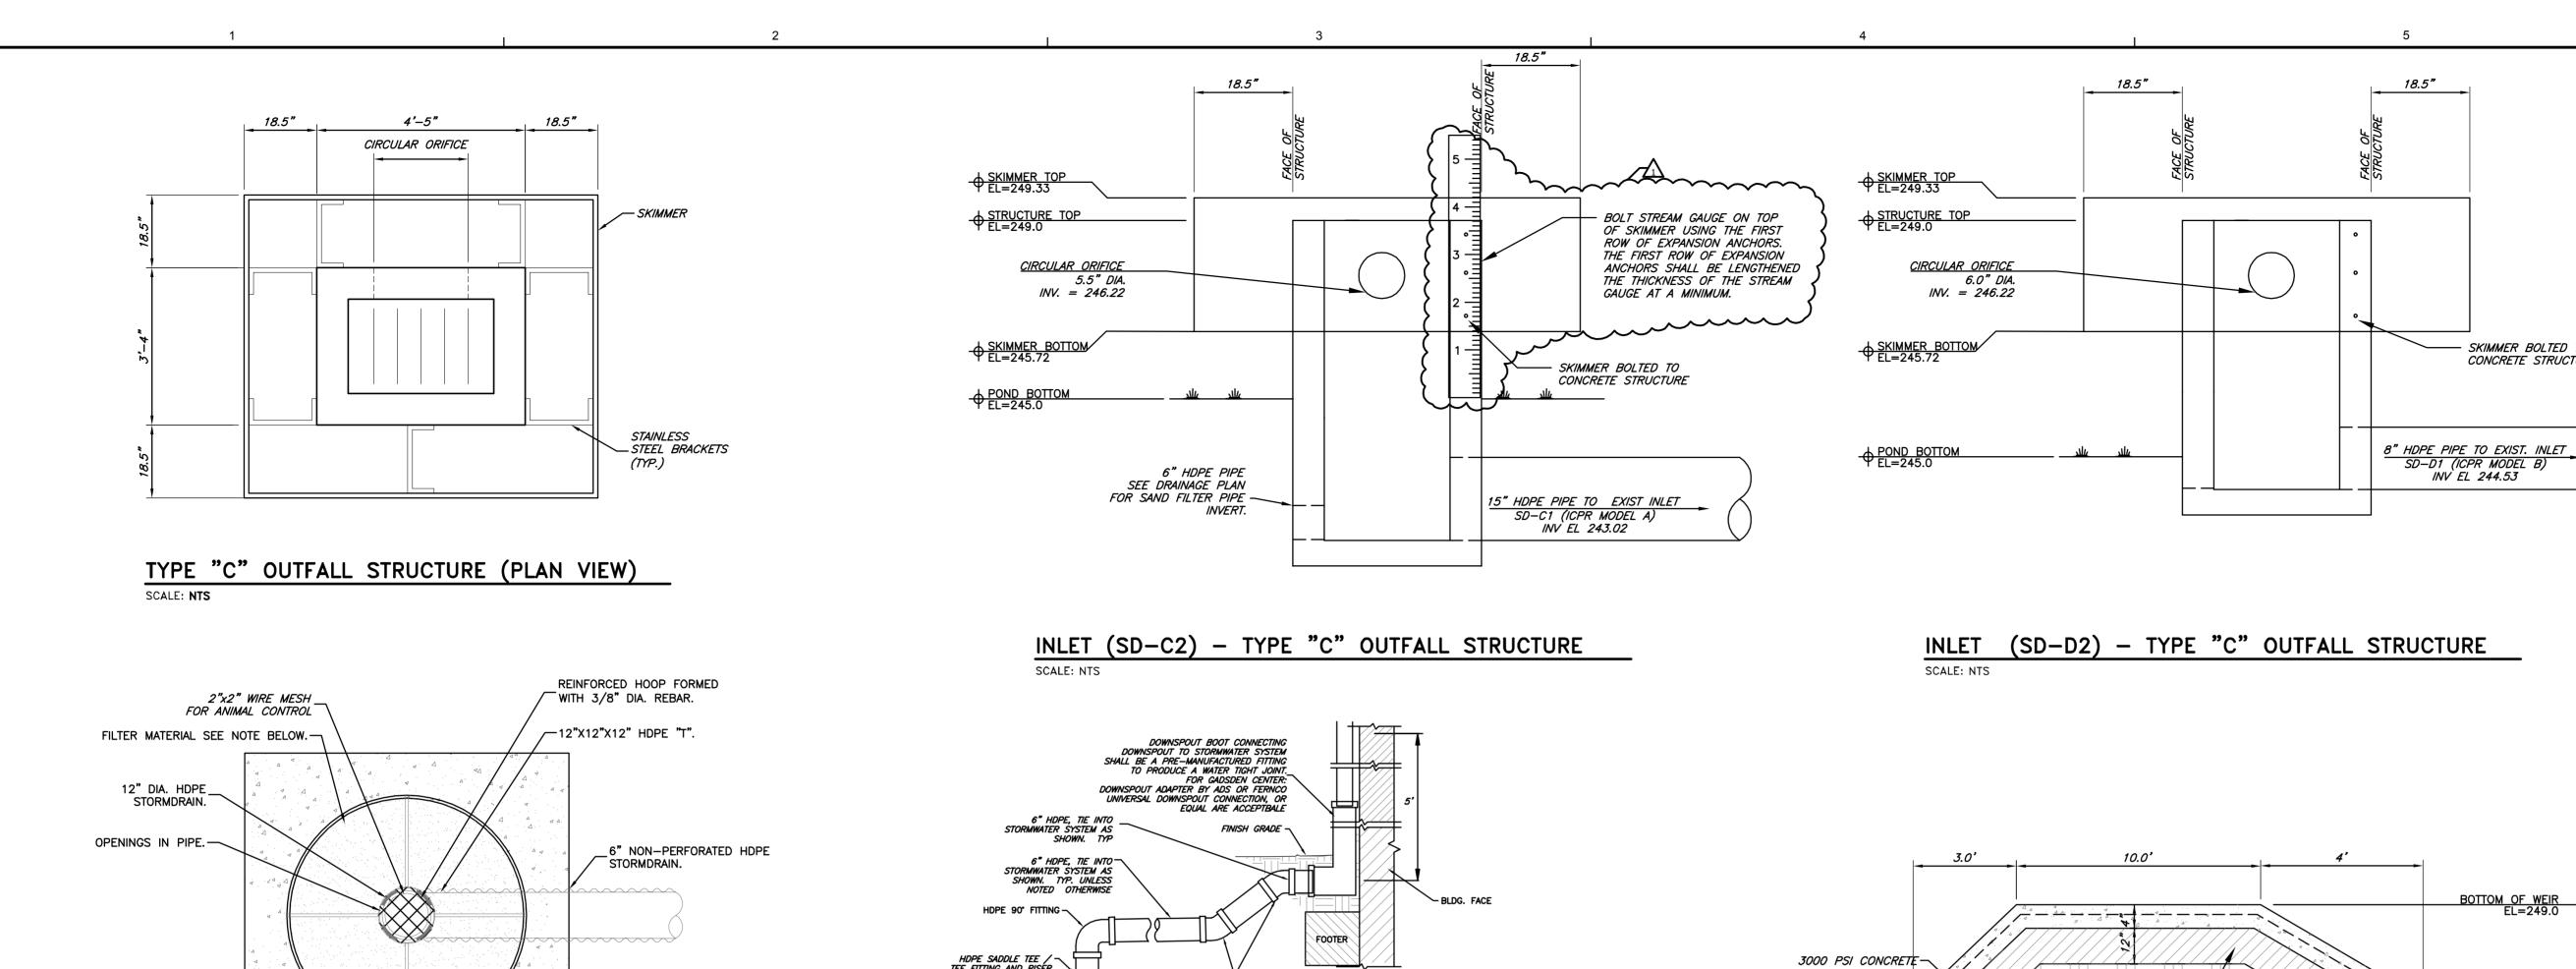
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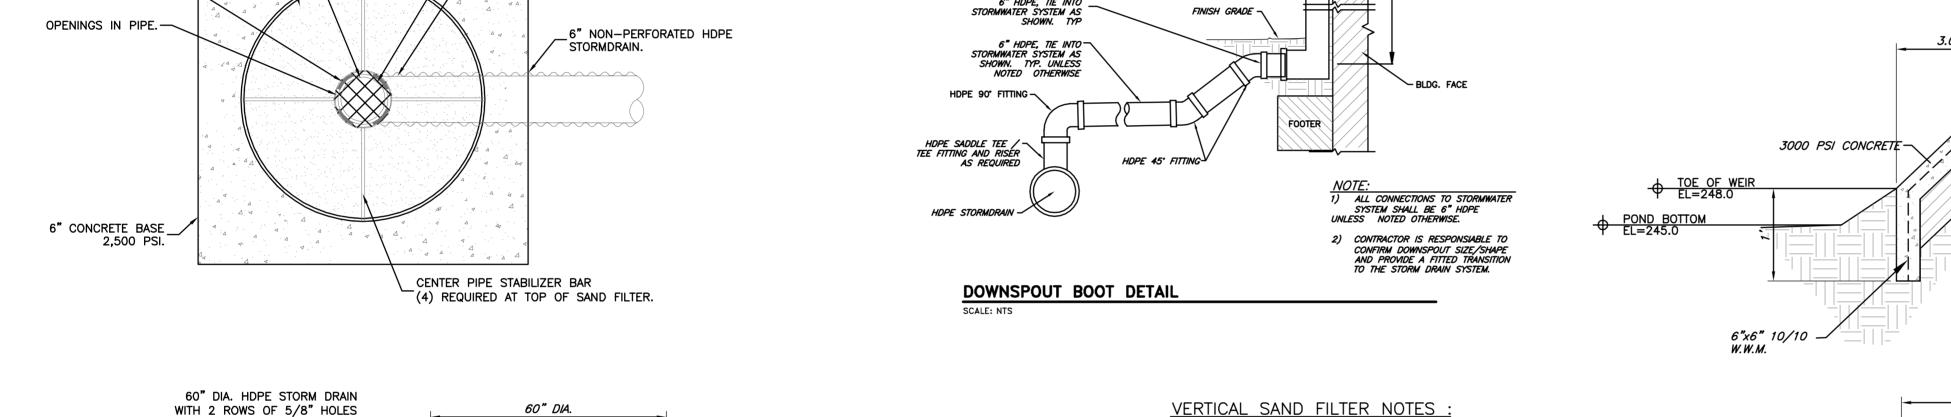
UTILITY PLAN


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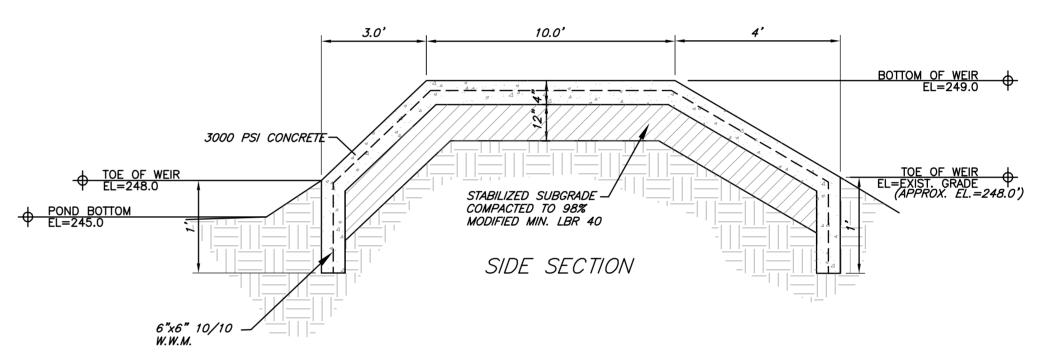








SCALE: NTS

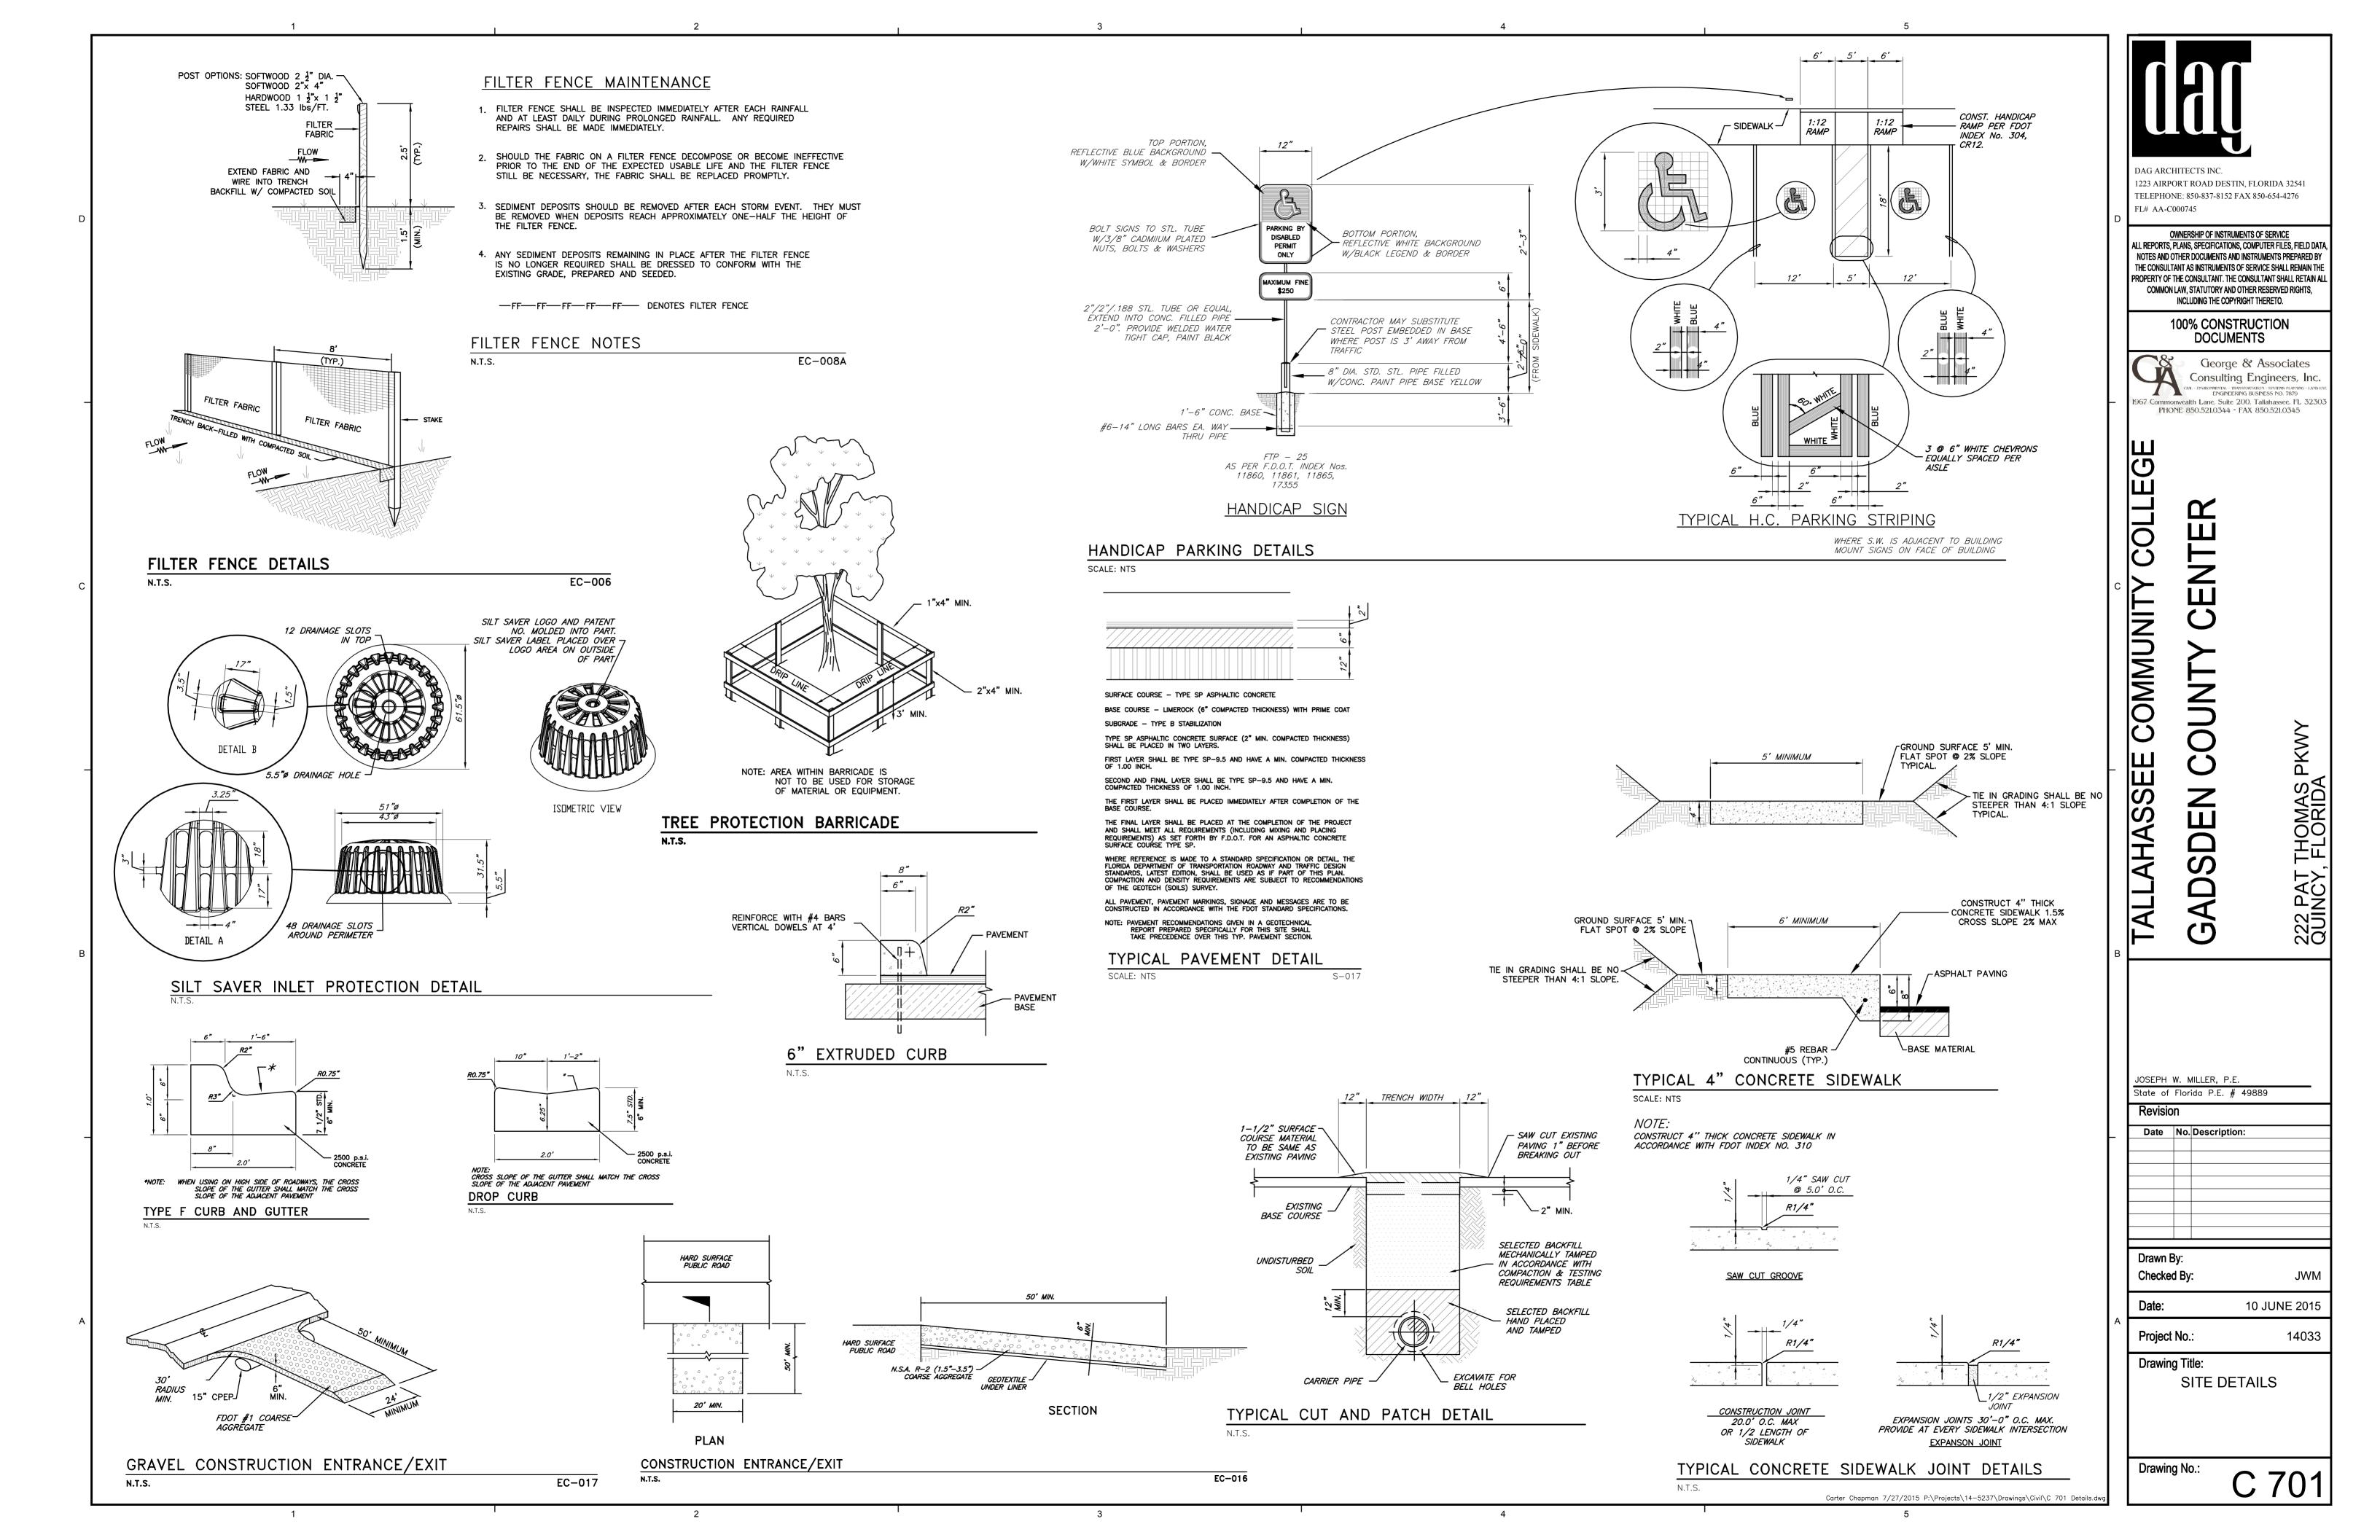- SAND FOR SAND FILTER SHALL BE AS SPECIFIED IN THE FLORIDA DEPARTMENT OF ENVIRONMENTAL PROTECTION REQUIREMENTS: (FAC 62-25)
- A. CONTAIN LESS THAN 1% SILT, CLAY AND ORGANIC
- UNIFORMITY COEFFICIENT SHALL BE BETWEEN 1.5 & 4. EFFECTIVE GRAIN SIZE SHALL BE BETWEEN 0.20 AND 0.55 MM IN DIAMETER.
- 2. PERCOLATION RATE OF SAND SHALL BE EQUAL TO OR GREATER THAN 120ft PER DAY.
- 3. PRIOR TO SAND PLACEMENT, THE CONTRACTOR SHALL NOTIFY THE ENGINEER FOR INSPECTION OF THE PERFORATED PIPE, GRAVEL AND FILTER FABRIC.
- 4. THE GEO-FABRIC SHALL BE REMOVED AND REPLACED DURING CONSTRUCTION AS NEEDED TO ENSURE DRAWDOWN WITHIN 36 HOURS.
- 5. AT SUCH TIME AFTER CONSTRUCTION THAT THE ENTIRE PROJECT IS STABILIZED AND ALL SEDIMENT HAS BEEN REMOVED FROM THE FILTER SYSTEM, THE EXTERIOR FILTER-FABRIC SHALL BE REMOVED AND REPLACED.
- PRIOR TO FINAL ACCEPTANCE OF THE FILTRATION SYSTEM THE CONTRACTOR SHALL DOCUMENT A MINIMUM OF TWO COMPLETE DRAWDOWN (i.e. FULL TREATMENT STORAGE VOLUME) TIME INTERVALS. THE CONTRACTOR SHALL NOTE THE DATE, TIME, AND DEPTH OF WATER AT THE BEGINNING OF THE DRAWDOWN AND THE SAME WHEN THE POND HAS HAS COMPLETELY DRAWN DOWN. THIS DOCUMENTATION SHALL OCCUR ONLY FOLLOWING COMPLETE SEDIMENT REMOVAL FROM THE POND'S DRAINAGE COLLECTION SYSTEM AND FOLLOWING SITE
- THE CONTRACTOR SHALL PROVIDE TO THE ENGINEER OF RECORD A CERTIFIED GEOTECHNICAL REPORT FOR THE
- CONTRACTOR SHALL WRAP OUTSIDE OF 60" PIPE AND COVER THE EXPOSED GRAVEL WITH FILTER FABRIC DURING CONSTRUCTION TO PREVENT SEDIMENT FROM CLOGGING PERFORATIONS. THIS FILTER FABRIC SHALL BE REMOVED ONCE CONSTRUCTION IS COMPLETE AND DRAINAGE BASIN IS STABILIZED.
- 9. IF FILTER FABRIC BECOMES CLOGGED, UTILIZE VACUUM TRUCK TO REMOVE FILTER MEDIA AND REPLACE FILTER FABRIC AND FILTER MEDIA.
- 10. INTERIOR PIPES OF VERTICAL SAND FILTER CAN BE USED AS CLEAN OUTS. IF SEDIMENT BUILDS IN DRAINAGE PIPE USE HIGH PRESSURE WATER TO REMOVE SEDIMENT.
- 11. CONTRACTOR SHALL ENSURE THE NUMBER OF 5/8" HOLES DRILLED INTO PIPE MEET 689 PER LF

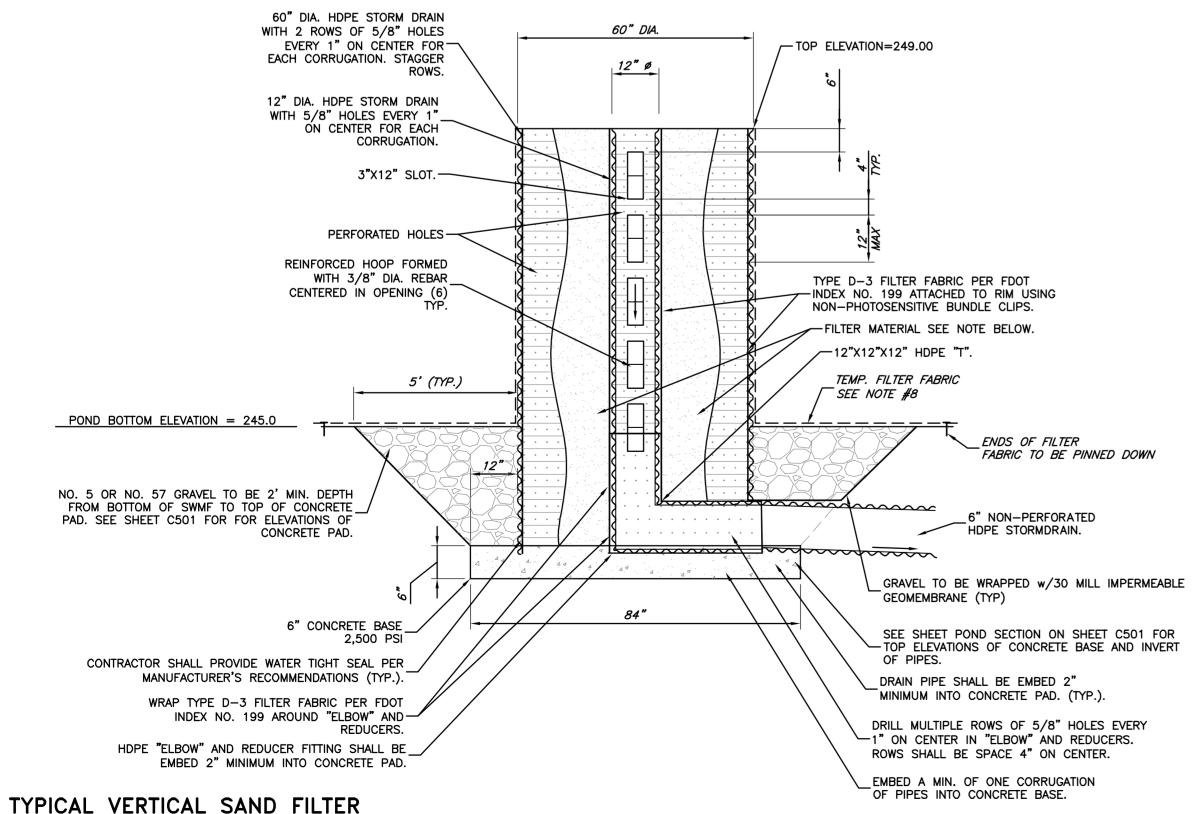

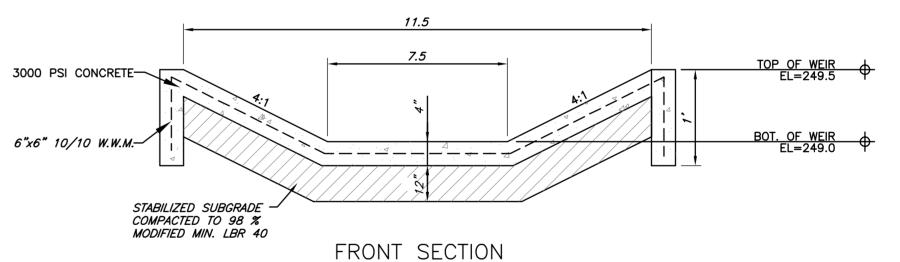

EMERGENCY CONCRETE OVERFLOW WEIR

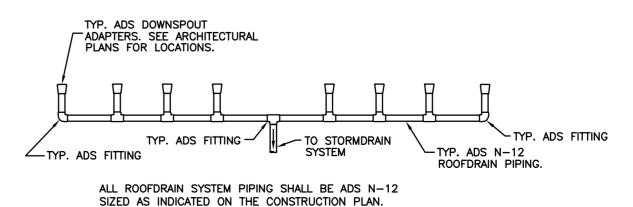

TYPICAL ADS ROOFDRAIN SYSTEM

SCALE: NTS

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CONCRETE STRUCTURE

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ite	of	Flo	rida	P.E.	#	49889	

Revision				
Date	No.	Description:		
3/19/2015	1	ADDED DEPTH GUAGE		
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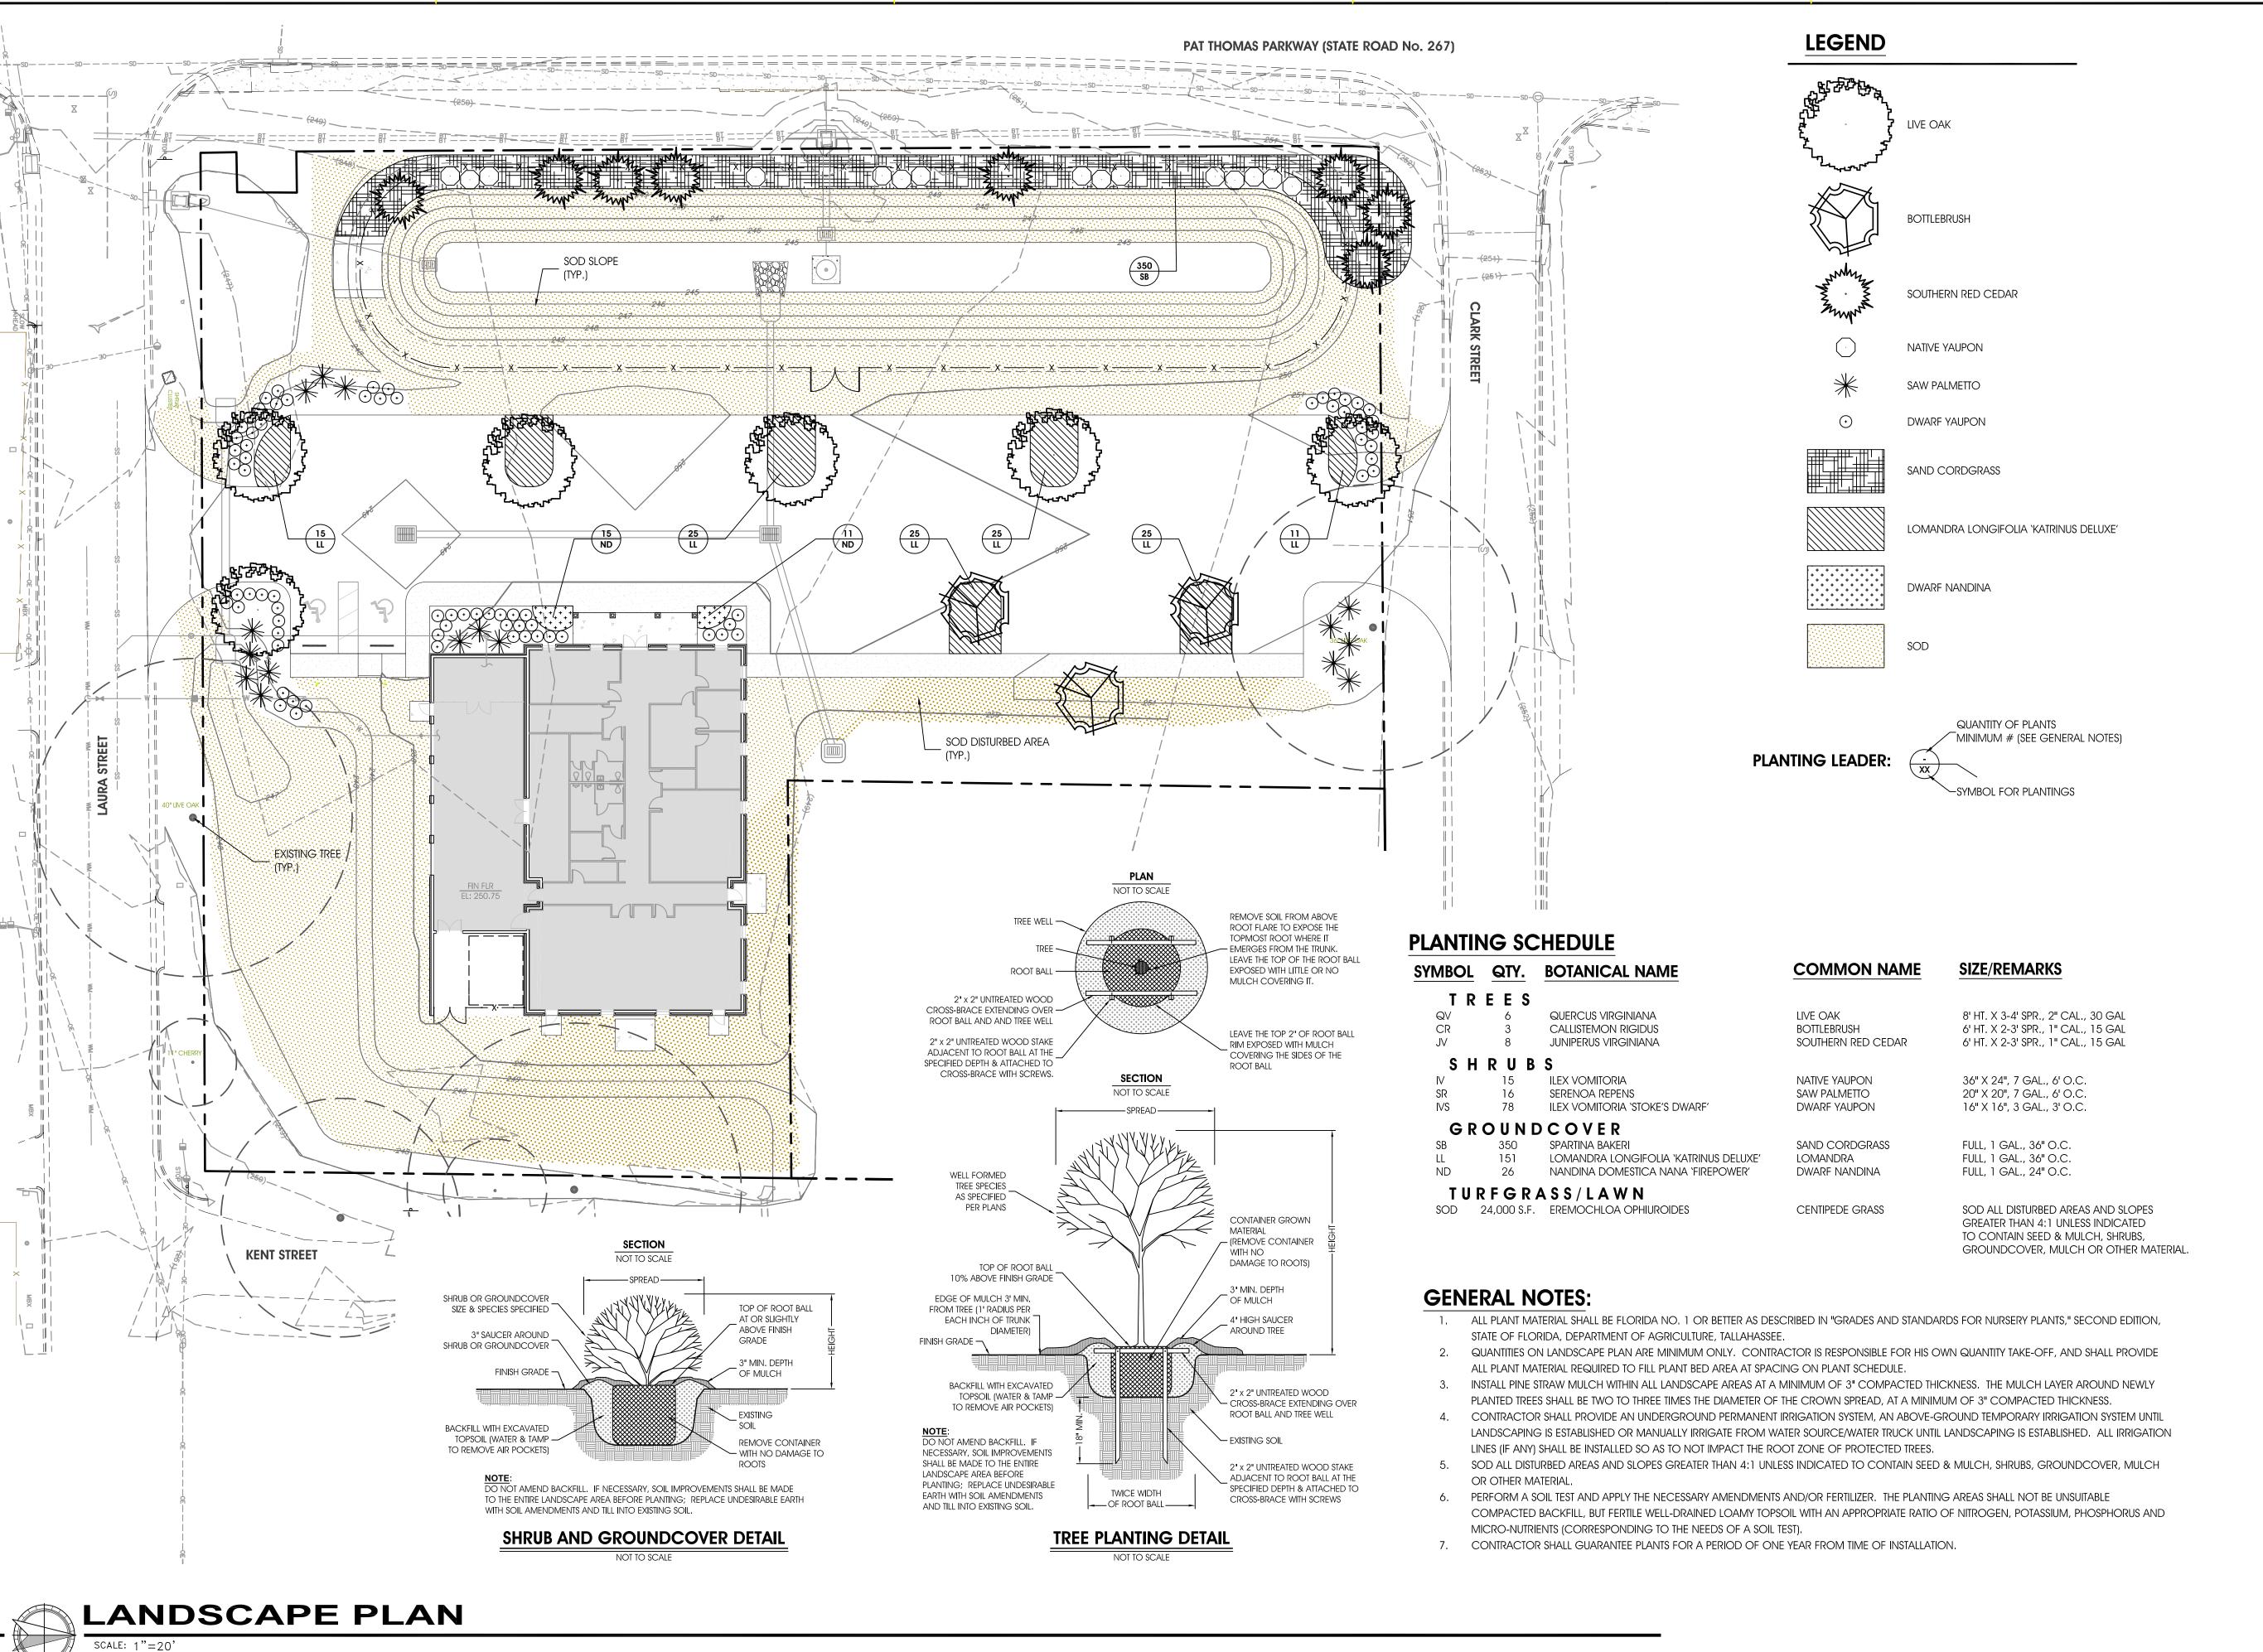
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10 JUNE 2015 14033

Project No.: Drawing Title:

DRAINAGE DETAILS

Drawing No.:



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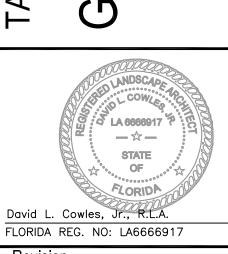
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Revision Description

Drawn By: DLC Checked By: DLC

Date: 10 JUNE 2015

Drawing Title:

Project No.:

LANDSCAPE PLAN

Drawing No.:

14033

GENERAL NOTES

- I. THE STRUCTURAL DRAWINGS SHALL BE USED IN CONJUNCTION WITH THE DRAWINGS OF ALL OTHER DISCIPLINES AND THE SPECIFICATIONS. THE CONTRACTOR SHALL VERIFY THE REQUIREMENTS OF OTHER TRADES AS TO SLEEVES, CHASES, HANGERS, INSERTS, ANCHORS, HOLES AND OTHER ITEMS TO BE PLACED OR SET IN THE STRUCTURAL WORK.
- 2. THE CONTRACTOR SHALL BE RESPONSIBLE FOR COMPLYING WITH ALL SAFETY PRECAUTIONS AND REGULATIONS DURING THE WORK. THE ENGINEER WILL NOT ADVISE ON NOR ISSUE DIRECTION AS TO SAFETY PRECAUTIONS AND PROGRAMS.
- 3. THE STRUCTURAL DRAWINGS HEREIN REPRESENT THE FINISHED STRUCTURE. THE CONTRACTOR SHALL PROVIDE ALL TEMPORARY GUYING AND BRACING REQUIRED TO ERECT AND HOLD THE STRUCTURE IN PROPER ALIGNMENT UNTIL ALL STRUCTURAL WORK AND CONNECTIONS HAVE BEEN COMPLETED. THE INVESTIGATION, DESIGN, SAFETY, ADEQUACY AND INSPECTION OF ERECTION BRACING, SHORING, TEMPORARY SUPPORTS, ETC. IS THE SOLE RESPONSIBILITY OF THE CONTRACTOR.
- 4. THE ENGINEER SHALL NOT BE RESPONSIBLE FOR THE METHODS, TECHNIQUES AND SEQUENCES OF PROCEDURES TO PERFORM THE WORK. THE SUPERVISION OF THE WORK IS THE SOLE RESPONSIBILITY OF THE CONTRACTOR.
- 5. DRAWINGS INDICATE GENERAL AND TYPICAL DETAILS OF CONSTRUCTION. WHERE CONDITIONS ARE NOT SPECIFICALLY SHOWN. SIMILAR DETAILS OF CONSTRUCTION SHALL BE USED, SUBJECT TO APPROVAL BY THE ENGINEER.
- 6. ALL STRUCTURAL SYSTEMS WHICH ARE TO BE COMPOSED OF COMPONENTS TO BE FIELD ERECTED SHALL BE SUPERVISED BY THE SUPPLIER DURING MANUFACTURING, DELIVERY, HANDLING, STORAGE AND ERECTION IN ACCORDANCE WITH THE SUPPLIER'S INSTRUCTIONS AND REQUIREMENTS.
- 7. LOADING APPLIED TO THE STRUCTURE DURING THE PROCESS OF CONSTRUCTION SHALL NOT EXCEED THE SAFE LOAD—CARRYING CAPACITY OF THE STRUCTURAL MEMBERS. THE LIVE LOADINGS USED IN THE DESIGN OF THIS STRUCTURE ARE INDICATED IN THE "DESIGN CRITERIA NOTES". DO NOT APPLY ANY CONSTRUCTION LOADS UNTIL STRUCTURAL FRAMING IS PROPERLY CONNECTED TOGETHER AND UNTIL ALL TEMPORARY BRACING IS IN PLACE.
- 8. ALL ASTM AND OTHER REFERENCES ARE PER THE LATEST EDITIONS OF THESE STANDARDS, UNLESS OTHERWISE NOTED.
- 9. SHOP DRAWINGS AND OTHER ITEMS SHALL BE SUBMITTED TO THE ENGINEER FOR REVIEW PRIOR TO FABRICATION. ALL SHOP DRAWINGS SHALL BE REVIEWED BY THE GENERAL CONTRACTOR BEFORE SUBMITTAL. THE ENGINEER'S REVIEW IS TO BE FOR CONFORMANCE WITH THE DESIGN CONCEPT AND GENERAL COMPLIANCE WITH THE RELEVANT CONTRACT DOCUMENTS. THE ENGINEER'S REVIEW DOES NOT RELIEVE THE CONTRACTOR OF THE SOLE RESPONSIBILITY TO REVIEW, CHECK AND COORDINATE THE SHOP DRAWINGS PRIOR TO SUBMISSION. THE CONTRACTOR REMAINS SOLELY RESPONSIBLE FOR ERROR AND OMISSIONS ASSOCIATED WITH THE PREPARATION OF SHOP DRAWINGS AS THEY PERTAIN TO MEMBER SIZES, DETAILS, DIMENSIONS, ETC.
- 10. AS A MINIMUM, SUBMIT THE FOLLOWING ITEMS FOR REVIEW:
- A. CONCRETE MIX DESIGN(S)
- B. REINFORCING STEEL SHOP DRAWINGS
- C. STRUCTURAL STEEL SHOP DRAWINGS
- D. PRE-ENGINEERED METAL BUILDING SYSTEM SHOP DRAWINGS E. CONCRETE MASONRY UNIT MATERIAL SUBMITTALS
- F. CFS FRAMING SHOP DRAWINGS AND CALCULATIONS
- ** OTHER SUBMITTALS MAY BE REQUIRED PER THE NOTES CONTAINED HEREIN.
- 11. ALL "STRUCTURAL SUBMITTALS" SHALL BE PREPARED BY A PROFESSIONAL ENGINEER LICENSED IN THE STATE OF FLORIDA. DRAWINGS PREPARED SOLELY AS A GUIDE FOR ERECTION, INSTALLATION AND CATALOG INFORMATION WILL NOT REQUIRE AN ENGINEER'S SEAL; HOWEVER, THEY SHALL BEAR THE ENGINEER'S SIGNATURE AND AN INDICATION THAT HE OR SHE CHECKED THE WORK.
- 12. DRAWINGS INTRODUCING ENGINEERING INPUT AND CALCULATIONS SHALL BE SIGNED, SEALED AND DATED BY THE ENGINEER PREPARING SUCH WORK.

DESIGN CRITERIA

1. THE INTENDED DESIGN STANDARDS AND/OR CRITERIA ARE AS FOLLOWS:

2010 FLORIDA BUILDING CODE, BUILDING (FBC-B), W/ 2012 SUPPLEMENTS

CONCRETE ACI 318-08

STRUCTURAL STEEL AISC 13TH EDITION (ASD) MASONRY ACI 530-08/ASCE 5-08/TMS 402-08

COLD-FORMED STEEL 2007 NORTH AMERICAN STANDARD FOR COLD-FORMED STEEL FRAMING

2. DESIGN SUPERIMPOSED GRAVITY DEAD LOADS USED IN THE DESIGN OF THE FOUNDATIONS, SLAB-ON-GRADE AND WALLS ARE AS FOLLOWS:

SOLAR PANELS

4 PSF COLLATERAL (MAIN BLDG.) 13 PSF MAX./4 PSF MIN. COLLATERAL (HVAC LAB/ENTRY) 9 PSF MAX./3 PSF MIN.

ACTUAL SELF-WT. ALL OTHERS

3. DESIGN SUPERIMPOSED GRAVITY LIVE LOADS USED IN THE DESIGN OF THE FOUNDATIONS, SLAB-ON-GRADE AND WALLS ARE AS

SLAB ON GRADE 125 PSF

ROOF 20 PSF (REDUCIBLE)

4. DESIGN LATERAL LIVE LOADS USED IN THE DESIGN OF THE FOUNDATIONS, SLAB—ON—GRADE AND WALLS ARE AS FOLLOWS:

WIND LOADS PER ASCE 7-10 (3-SEC GUST)

ULTIMATE WIND SPEED = 118 MPH RISK CATEGORY II

EXPOSURE CATEGORY E

INTERNAL PRESSURE COEFFICIENT, GCpi, = ±0.18 (ENCLOSED)

*SEE COMPONENTS & CLADDING WIND LOAD DIAGRAMS AND PRESSURES ON SHEET S101.

5. THE FOUNDATIONS. SLAB-ON-GRADE AND WALLS HAVE BEEN DESIGNED WITH "SAFETY FACTORS" IN ACCORDANCE WITH GENERALLY ACCEPTED PRINCIPLES OF STRUCTURAL ENGINEERING. THE FUNDAMENTAL NATURE OF THE "SAFETY FACTOR" IS TO COMPENSATE FOR UNCERTAINTIES IN THE INTENDED DESIGN, FABRICATION AND ERECTION OF STRUCTURAL BUILDING COMPONENTS. IT IS INTENDED THAT "SAFETY FACTORS" BE USED SO THAT THE LOAD CARRYING CAPACITY OF THE STRUCTURE DOES NOT FALL BELOW THE DESIGN LOAD AND THAT THE BUILDING WILL PERFORM UNDER DESIGN LOAD WITHOUT DISTRESS. WHILE THE USE OF "SAFETY FACTORS" IMPLIES SOME EXCESS CAPACITY BEYOND DESIGN LOAD, SUCH EXCESS CAPACITY CANNOT BE ADEQUATELY PREDICTED AND SHALL NOT BE RELIED UPON.

STRUCTURAL STEEL

- 1. ALL STRUCTURAL STEEL SHALL CONFORM TO THE 13TH EDITION OF THE "MANUAL OF STEEL CONSTRUCTION" OF THE AISC, ASD.
- 2. UNLESS OTHERWISE NOTED, ALL MATERIALS SHALL BE IN ACCORDANCE WITH THE FOLLOWING ASTM SPECIFICATIONS:

<u>MEMBER</u>	<u>ASTM</u>	MIN. STRENGTH
STRUCTURAL TUBING	A500-13 (GRADE B)	46 KSI
WIDE FLANGE SHAPES	A992-11 `	50 KSI
OTHER ROLLED PLATES/SHAPES	A36-12	36 KSI
CONNECTION BOLTS	A325-14	92 KSI
ANCHOR RODS	F1554-07	36 KSI
THREADED RODS	A36-12	36 KSI
NONSHRINK GROUT	C1107-14	8000 PSI

- 3. ALL CONNECTIONS SHALL BE SIMPLE SHEAR TYPE CONNECTIONS AND SHALL UTILIZE THE MAXIMUM NUMBER OF ROWS AT 3 INCH STANDARD BOLT SPACING USING MINIMUM 3/4" DIAMETER A325-N BOLTS, UNLESS OTHERWISE NOTED. ALL BOLTS SHALL BE SHEAR/BEARING TYPE BOLTS AND BE "SNUG-TIGHT".
- UNLESS OTHERWISE NOTED, PROVIDE CONT. MIN. SIZED FILLET WELDS PER AISC REQUIREMENTS. ALL FILLER MATERIAL SHALL HAVE A MINIMUM YIELD STRENGTH OF 58 KSI.

4. ALL WELDING SHALL BE IN ACCORDANCE WITH AWS STRUCTURAL WELDING CODE-STEEL (2010) D1.1 USING E70XX ELECTRODES.

- 5. HOLES IN STEEL SHALL BE DRILLED OR PUNCHED. ALL SLOTTED HOLES SHALL BE PROVIDED WITH SMOOTH EDGES. BURNING OF HOLES AND TORCH CUTTING AT THE SITE IS NOT PERMITTED.
- 6. ALL INTERIOR STRUCTURAL STEEL SHALL BE SHOP PRIMED WITH SSPC-PAINT 25, TYPE II, ZINC OXIDE, ALKYD, LINSEED OIL PRIMER AND COMPATIBLE TOPCOAT. ALL STRUCTURAL STEEL PERMANENTLY EXPOSED TO WEATHER SHALL BE HOT-DIP GALVANIZED IN ACCORDANCE WITH ASTM A153-09.
- 7. THE STRUCTURAL STEEL ERECTOR SHALL PROVIDE ALL TEMPORARY GUYING AND BRACING (SEE "GENERAL STRUCTURAL NOTES").
- 8. COLUMNS, ANCHOR BOLTS, BASE PLATES, ETC. HAVE BEEN DESIGNED FOR THE FINAL COMPLETED CONDITION AND HAVE NOT BEEN INVESTIGATED FOR POTENTIAL LOADINGS ENCOUNTERED DURING STEEL ERECTION AND CONSTRUCTION. ANY INVESTIGATION OF THE COLUMNS, ANCHOR BOLTS, BASE PLATES, ETC. FOR ADEQUACY DURING THE STEEL ERECTION AND CONSTRUCTION PROCESS IS THE SOLE RESPONSIBILITY OF THE CONTRACTOR.

FOUNDATION NOTES

- 1. ALL FOOTINGS HAVE BEEN DESIGNED USING AN ALLOWABLE SOIL BEARING PRESSURE OF 2,500 PSF AS RECOMMENDED BY SOUTHERN EARTH SCIENCES, INC. GEOTECHNICAL REPORT, FILE NO. T14-149 DATED NOVEMBER 6, 2014. THE FOUNDATION SUB-SOIL SHALL BE CONSOLIDATED PER THE GEOTECHNICAL REPORT PREPARED BY SOUTHERN EARTH SCIENCES, INC., DATED NOVEMBER 6, 2014. ALL FOUNDATION EXCAVATIONS SHALL BE EVALUATED BY THE GEOTECHNICAL ENGINEER/TESTING AGENCY PRIOR TO POURING FOUNDATION CONCRETE.
- 2. AT FOOTING SUBGRADES, AT LEAST ONE TEST OF EACH SOIL STRATUM WILL BE PERFORMED FOR EACH ISOLATED FOOTING AND EACH 50 LINEAR FEET OF CONTINUOUS WALL FOOTING PER LIFT TO VERIFY DESIGN BEARING CAPACITIES.
- 3. ALL FOUNDATION CONCRETE SHALL OBTAIN A 28 DAY COMPRESSIVE STRENGTH OF 3,000 PSI. ALL CONCRETE TO BE PERMANENTLY EXPOSED TO WEATHER SHALL BE AIR ENTRAINED TO 4% (±1.5%) WITH AN ADMIXTURE THAT CONFORMS TO ASTM C260-10a.
- 4. ALL CONCRETE WORK SHALL CONFORM TO THE REQUIREMENTS OF ACI 301-10, "SPECIFICATION FOR STRUCTURAL CONCRETE BUILDINGS". HOT WEATHER CONCRETING SHALL BE IN ACCORDANCE WITH ACI 305.1-14. COLD WEATHER CONCRETING SHALL BE IN ACCORDANCE WITH ACI 306.1-90 (2002).
- 5. ALL REINFORCING STEEL SHALL CONFORM TO ASTM A615-14, GRADE 60.
- 6. UNLESS OTHERWISE NOTED, THE FOLLOWING MINIMUM CONCRETE COVER SHALL BE PROVIDED FOR REINFORCEMENTS
- A) CONCRETE CAST AGAINST & PERMANENTLY EXPOSED TO EARTH 3"
- B) CONCRETE EXPOSED TO EARTH OR WEATHER: #6 THROUGH #18 BARS - 2" #5 BAR, W31 OR D31 WIRE & SMALLER - 1 1/2"
- 7. ALL REINFORCING MARKED CONTINUOUS (CONT.) ON THE PLANS AND DETAILS SHALL BE LAPPED 36 BAR DIAMETERS AT SPLICES UNLESS OTHERWISE INDICATED.
- 8. NO UNBALANCED BACKFILLING SHALL BE DONE AGAINST FOUNDATION WALLS UNLESS WALLS ARE SECURELY BRACED AGAINST OVERTURNING, EITHER BY TEMPORARY BRACING OR BY PERMANENT CONSTRUCTION.
- 9. PRIOR TO COMMENCING ANY FOUNDATION WORK, COORDINATE WORK WITH ANY EXISTING AND NEW UTILITIES. FOUNDATIONS SHALL BE STEPPED OR SLEEVED AS REQUIRED TO AVOID UTILITIES.
- 10. PROVIDE CONTROL JOINTS IN RETAINING WALLS AT APPROXIMATELY EQUAL INTERVALS NOT TO EXCEED 25 FEET NOR 3 TIMES THE WALL HEIGHT. PROVIDE EXPANSION JOINTS AT EVERY FOURTH CONTROL JOINT, UNLESS OTHERWISE INDICATED.

CONCRETE MASONRY NOTES

- MASONRY CONSTRUCTION SHALL CONFORM TO THE REQUIREMENTS OF THE "SPECIFICATIONS FOR MASONRY STRUCTURES (ACI 530-08/ASCE 5-08/TMS 402-08)", PUBLISHED BY THE AMERICAN CONCRETE INSTITUTE, DETROIT, MICHIGAN.
- 2. HOLLOW LOAD-BEARING MASONRY UNITS SHALL CONFORM TO ASTM C90-14, GRADE N AND BE MADE WITH MEDIUM WEIGHT AGGREGATE. THE MINIMUM I'M SHALL BE 2,000 PSI AT AN AGE OF 28 DAYS, AS DETERMINED BY THE UNIT STRENGTH METHOD OF ACI
- 3. FILL ALL BOND BEAMS AND REINFORCED CELLS SOLIDLY WITH GROUT. GROUT SHALL CONFORM TO ASTM C476-10 AND SHALL OBTAIN A MIN. 28 DAY COMPRESSIVE STRENGTH OF 2,500 PSI.
- 4. REINFORCING STEEL SHALL BE IN ACCORDANCE WITH ASTM A615-14, GRADE 60. SHOP FABRICATE REINFORCING BARS WHICH ARE SHOWN TO BE HOOKED OR BENT.
- 5. THE USE OF MASONRY-CEMENT MORTAR IS STRICTLY PROHIBITED. MORTAR SHALL CONFORM TO ASTM C270-14, TYPE S. ALL MORTAR SHALL MEET THE "PROPORTION SPECIFICATION" OF ASTM C270-14 AND BE MADE WITH PORTLAND CEMENT/LIME (NON AIR-ENTRAINED).
- 6. UNLESS OTHERWISE INDICATED, ALL WALLS SHALL BE LAID IN RUNNING BOND. BOND CORNERS AND INTERSECTIONS OF LOAD-BEARING
- 7. PROVIDE VERTICAL REINFORCING BARS OF THE GIVEN SIZE AND SPACING AS INDICATED. PROVIDE BARS AT ALL WALL CORNERS, INTERSECTIONS AND OPENING EDGES.
- 8. PROVIDE REBAR DOWELS FROM FOUNDATIONS TO MATCH VERTICAL REINFORCING SIZE AND SPACING. DOWELS SHALL HAVE STANDARD 90 DEGREE HOOKS AND LAP WITH THE FIRST LIFT OF REINFORCING.
- 9. PROVIDE HORIZONTAL BOND BEAMS WITH CONTINUOUS REINFORCING AS INDICATED. DISCONTINUE ALL HORIZONTAL REINFORCING AT CONTROL JOINTS EXCEPT FOR THE BOND BEAMS AT BEARING ELEVATIONS.
- 10. ALL VERTICAL WALL REINFORCING SHALL BE EXTENDED TO WITHIN 2" OF THE TOP OF ALL WALLS.
- 11. PROVIDE STANDARD 9 GAUGE HORIZONTAL JOINT REINFORCING AT 16" ON CENTER IN ALL WALLS. PROVIDE LADDER TYPE JOINT REINFORCING FOR ALL CONCRETE MASONRY. STOP ALL HORIZONTAL JOINT REINFORCING AT CONTROL JOINTS
- 12. SEE THE ARCHITECTURAL DRAWINGS FOR LOCATIONS OF ALL DOOR AND WINDOW OPENINGS.
- 13. THE MASONRY CONTRACTOR SHALL PROVIDE ALL REQUIRED TEMPORARY WALL BRACING DURING CONSTRUCTION (SEE "GENERAL STRUCTURAL NOTES").
- 14. WALL CONTROL JOINTS SHALL BE SPACED NO MORE THAN 20 FEET APART AT 13-FEET 4-INCH HIGH WALLS AND 12 FEET APART AT 7-FEET 8 1/2-INCH HIGH WALLS. SEE LOCATIONS SHOWN ON THE FOUNDATION PLAN.

EXTERIOR COLD-FORMED METAL FRAMING

- 1. DESIGN, DETAIL AND ERECT EXTERIOR COLD-FORMED METAL FRAMING IN ACCORDANCE WITH THE GENERAL NOTES AND SPECIFICATIONS.
- 2. COLD-FORMED STEEL FRAMING DETAILS SHOWN ON CONTRACT DOCUMENTS REPRESENT THE MINIMUM DESIGN INTENT TO BE FOLLOWED. CONNECTIONS NOT DETAILED IN CONTRACT DOCUMENTS SHALL BE DESIGNED AND DETAILED BY FABRICATOR ACCORDING TO SPECIFICATIONS AND REQUIREMENTS HEREIN. THE MINIMUM DESIGN THICKNESS OF GAUGE OF EXTERIOR COLD-FORMED METAL FRAMING SHALL BE 43 MILS. NO EXCEPTIONS WILL BE ACCEPTED.
- 3. SUBMIT COMPLETE SHOP DRAWINGS AND CALCULATIONS SHOWING METHOD OF FABRICATION, ERECTION PROCEDURES, ATTACHMENT OF THE SYSTEM TO THE BUILDING, JOINTS, CONNECTIONS AND FRAMING. CALCULATIONS AND SHOP DRAWINGS SHALL BE PREPARED, SIGNED. SEALED AND DATED BY A DELEGATED ENGINEER LICENSED IN THE STATE OF FLORIDA.
- 4. ALL COLD-FORMED STEEL SECTIONS, "C" STUDS, TRACKS, ANGLES AND STRAPS, AS SHOWN ON DRAWINGS AND DETAILS SHALL HAVE HOT DIPPED GALVANIZED STEEL COATING MEETING THE REQUIREMENTS OF ASTM A525-93 AND C955-11C WITH G-90 CLASS COATING AND A MINIMUM YIELD STRENGTH AS FOLLOWS:
 - 54 MIL THICKNESS AND GREATER: Fy=50 KSI MIN. 43 MIL THICKNESS: Fy=33 KSI MIN.
- ALL TRACKS TO HAVE SAME DESIGN THICKNESS AS STUDS WITH MINIMUM 1 1/4" LEGS.
- 5. DOOR AND WINDOW SILLS, HEADERS, AND JAMBS SHALL BE DESIGNED TO RESIST WIND FORCES ON TRIBUTARY WINDOWS AND DOORS AND TO TRANSMIT THE FORCES TO THE PRIMARY STRUCTURAL FRAME.
- 6. ALL JAMBS, HEADERS, AND OTHER BUILT-UP MEMBERS SHALL BE CONSTRUCTED USING UNPUNCHED MATERIAL.
- 7. ALL JAMB STUDS SHALL BE FASTENED TOGETHER TO FORM A CONTINUOUS BUILT-UP SECTION.
- 8. SCREWS, WHERE REQUIRED, SHALL MEET THE MINIMUM REQUIREMENTS OF SAE J429-14 GRADE 5; AND IFI-105-02. SCREWS SHALL HAVE A PROTECTIVE COATING EQUIVALENT TO CADMIUM OR ZINC PLATING, ASTM B766-86 (2008).
- 9. FIELD CUTTING OF COLD-FORM METAL FRAMING SHALL BE BY SAW OR SHEAR. TORCH CUTTING IS NOT PERMITTED.
- 10. LIMIT DEFLECTIONS OF STUDS BETWEEN SUPPORTS TO L/600 WHEN SUPPORTING MASONRY, L/360 WHEN SUPPORTING GYPSUM WALL BOARD OR PORTLAND CEMENT STUCCO AND L/240 FOR OTHER CONDITIONS.
- 11. ADD WEB STIFFENERS AT CONCENTRATED LOADS AS REQUIRED BY DESIGN.
- 12. ALL WELDERS SHALL BE CERTIFIED BY AWS FOR THIN METAL SECTIONS.

SLAB ON GRADE NOTES

- 1. REFER TO GEOTECHNICAL REPORT FOR SUBGRADE PREPARATION MORE THAN 12" BELOW BOTTOM OF SLAB
- 2. ABOVE SUBGRADE, USE TERMITE TREATED FILL CONTAINING NOT MORE THAN 10% PASSING #200 SIEVE AND MAXIMUM 3/4 INCH DIAMETER. PLACE IN 8" LOOSE LIFTS AND COMPACT TO 95% OF MAXIMUM DRY DENSITY AS DETERMINED BY MODIFIED PROCTOR (ASTM D-1557). COMPACT PRIOR TO PLACEMENT OF NEXT LIFT.
- 3. FILL PLACEMENT AND COMPACTION SHALL BE MONITORED AND ACCEPTED BY THE TESTING AGENCY. TAKE A MINIMUM OF ONE FIELD DENSITY TEST (ASTM D1556-07 OR D2922-05) FOR EACH 2,000 SQUARE FEET OF SLAB AREA FOR EACH LIFT OF CONTROLLED FILL. THE TESTING AGENCY SHALL RANDOMLY SELECT TEST LOCATIONS.
- 4. ALL CONCRETE FOR SLAB-ON-GRADE SHALL OBTAIN A 28 DAY COMPRESSIVE STRENGTH OF 3,000 PSI. PLACE CONCRETE WITH A MAXIMUM 4" SLUMP ±1 INCH AS MEASURED AT POINT OF DISCHARGE. REINFORCE WITH 6x6-W1.4xW1.4 WELDED WIRE REINFORCING. ALL CONCRETE TO BE PERMANENTLY EXPOSED TO WEATHER SHALL BE AIR ENTRAINED TO 3% (±1.5%) WITH AN ADMIXTURE THAT CONFORMS TO ASTM C260-10a, EXCEPT AT TROWEL-FINISHED FLOORS THE AIR CONTENT SHALL NOT EXCEED 3%.
- 5. FOR INTERIOR AND EXTERIOR SLABS PLACE VAPOR BARRIER BETWEEN SOIL AND BOTTOM OF SLAB. SEE SPECIFICATIONS FOR REQUIREMENTS.
- 6. ALL WELDED WIRE REINFORCING SHALL BE IN ACCORDANCE WITH ASTM A185-02. LAP ADJOINING PIECES AT LEAST ONE FULL MESH.
- 7. SLAB JOINTS SHALL BE FILLED WITH APPROVED MATERIAL. THIS SHOULD TAKE PLACE AS LATE AS POSSIBLE, PREFERABLY 4 TO 6 WEEKS AFTER THE SLAB HAS BEEN CAST. PRIOR TO FILLING, REMOVE ALL DEBRIS FROM THE SLAB JOINT, THEN FILL IN ACCORDANCE WITH THE MANUFACTURER'S RECOMMENDATIONS AS FOLLOWS:
 - 4" SLAB FILL WITH FIELD MOLDED OR ELASTOMERIC SEALANT.
- 8. SEE THE CIVIL SITE PLAN AND ARCHITECTURAL DRAWINGS FOR WALKWAYS AND OTHER EXTERIOR SLABS NOT INDICATED ON THE STRUCTURAL DRAWINGS FOR LOCATIONS, DIMENSIONS, ELEVATIONS, JOINTING DETAILS AND FINISH DETAILS. PROVIDE 4" WALKS REINFORCED WITH 6x6-W1.4xW1.4 WWR UNLESS OTHERWISE NOTED.
- 9. ALL CONCRETE WORK SHALL CONFORM TO THE REQUIREMENTS OF ACI 301-10, "SPECIFICATION FOR STRUCTURAL CONCRETE BUILDINGS". HOT WEATHER CONCRETING SHALL BE IN ACCORDANCE WITH ACI 305.1-14. COLD WEATHER CONCRETING SHALL BE IN ACCORDANCE WITH ACI 306.1-90 (2002)
- 10. IN ORDER TO AVOID CONCRETE SHRINKAGE CRACKING, LIMIT THE MAXIMUM LENGTH OF SLAB CAST IN ANY ONE CONTINUOUS POUR TO 100 FEET OR LESS. THE MAXIMUM SPACING OF CONTRACTION JOINTS SHALL BE 12' FOR 4" THICK SLABS UNLESS OTHERWISE
- 11. THE ALTERNATE WIRES OF THE WELDED WIRE REINFORCING MUST BE PRECUT AT THE SLAB CONTRACTION JOINT LOCATIONS TO CREATE A "WEAKENED PLANE". WITHOUT CUTTING THE ALTERNATE WIRES, THE STRENGTH OF THE WIRE WILL PREVENT THE SLAB FROM CRACKING (SEPARATING) AT THE JOINT AND THE SLAB MAY BEGIN TO CRACK ELSEWHERE.
- 12. THE USE OF POLYPROPYLENE FIBERS (IN LIEU OF WIRE REINFORCING) IS PROHIBITED WITHOUT THE WRITTEN AUTHORIZATION OF THE ENGINEER AND OWNER.
- 13. IN SIDEWALKS AND WALKWAYS, LOCATE ISOLATION JOINTS AT 20 FT. O.C. MAXIMUM, SCORE AND TOOL BETWEEN ISOLATION JOINTS IN EQUAL BAYS NOT GREATER THAN SIDEWALK WIDTH UNLESS DETAILED ELSEWHERE.
- 14. SEE THE ARCHITECTURAL DRAWINGS FOR EXACT LOCATIONS OF DEPRESSED SLAB AREAS AND DRAINS. SLOPE SLAB TO DRAINS WHERE SHOWN.

PRE-ENGINEERED METAL BUILDING NOTES

- 1. THE ENTIRE PRE-ENGINEERED METAL BUILDING SYSTEM SHALL BE DESIGNED BY THE METAL BUILDING MANUFACTURER IN CONFORMANCE TO THE PROVISIONS OF THE "FLORIDA BUILDING CODE" (2010 FBC-B W/ 2012 SUPPLEMENTS) AND THE "LOW-RISE BUILDING SYSTEMS MANUAL" AS PUBLISHED BY THE METAL BUILDING MANUFACTURER'S ASSOCIATION. WHERE THESE CRITERIA CONFLICT, THE MORE STRINGENT CRITERIA SHALL APPLY.
- 2. IT IS THE PRE-ENGINEERED METAL BUILDING MANUFACTURER'S RESPONSIBILITY TO DESIGN THE COMPLETE BUILDING SYSTEM (STEEL FRAMING, ANCHOR BOLTS, PURLINS, GIRTS, BRACINGS, CONNECTIONS, ROOFING, WALL PANELS, COMPONENTS, ATTACHMENTS, ETC.) THE MANUFACTURER SHALL SUBMIT A CERTIFICATION LETTER BEARING THE SEAL OF A PROFESSIONAL ENGINEER REGISTERED IN FLORIDA STATING THAT THE BUILDING SYSTEM DESIGN MEETS THE INDICATED CODE, PERFORMANCE AND LOADING REQUIREMENTS.
- 3. THE PRE-ENGINEERED METAL BUILDING MANUFACTURER SHALL HAVE THE INTERNATIONAL ACCREDITATION SERVICE (IAS) AC 472 ACCREDITATION FOR METAL BUILDINGS.
- 4. THE CONTRACTOR SHALL SUBMIT SHOP DRAWINGS OF THE ENTIRE METAL BUILDING SYSTEM FOR REVIEW. THE CONTRACTOR SHALL ALSO SUBMIT A COMPLETE STRUCTURAL DESIGN ANALYSIS OF THE BUILDING SYSTEM (FOR RECORD PURPOSES ONLY). THE SHOP DRAWING SUBMITTAL SHALL INCLUDE ALL ANCHOR BOLT REQUIREMENTS AND FOUNDATION REACTIONS. ALL SHOP DRAWING AND CALCULATION SUBMITTALS SHALL BEAR THE SEAL OF A PROFESSIONAL ENGINEER REGISTERED IN FLORIDA.
- 5. DESIGN LOADS TO BE USED IN CONNECTION WITH THE METAL BUILDING DESIGN ARE PER THE "DESIGN CRITERIA NOTES". IN ADDITION TO THE ACTUAL DEAD LOAD, AN ADDITIONAL COLLATERAL ROOF FRAMING DEAD LOAD SHALL BE INCLUDED AS SHOWN IN THE "DESIGN CRITERIA NOTES". COORDINATE ANY EQUIPMENT LOADS WITH MECHANICAL AND ARCHITECTURAL DRAWINGS. PAY PARTICULAR ATTENTION TO THE CODE REQUIRED WIND LOADING REQUIREMENTS (WIND EXPOSURE CATEGORY, RISK CATEGORY, ETC.)
- 6. CALCULATIONS FOR FRAME DEFLECTIONS SHALL BE DONE USING ONLY THE BARE FRAME METHOD. REDUCTIONS BASED ON ENGINEERING JUDGEMENT USING THE ASSUMED COMPOSITE STIFFNESS OF THE BUILDING ENVELOPE SHALL NOT BE PERMITTED. DRIFT SHALL FOLLOW AISC'S "SERVICEABILITY DESIGN CONSIDERATIONS FOR LOW-RISE BUILDINGS." CALCULATIONS SHALL BE SUBMITTED VERIFYING THAT THE ACTUAL DRIFT UNDER CODE REQUIRED LOADINGS DOES NOT EXCEED THE ALLOWABLE.
- 7. THE PRE-ENGINEERED MANUFACTURER SHALL PROVIDE ALL GIRTS, PURLINS, AND OTHER COMPONENTS REQUIRED FOR A COMPLETE SYSTEM. ALL WALL SYSTEMS, SUCH AS METAL STUDS, STOREFRONTS, ETC. SHALL BE PROPERLY SUPPORTED BY THE METAL BUILDING SYSTEM. ALLOWABLE DEFLECTIONS OF COMPONENTS SHALL BE IN ACCORDANCE WITH THE 2010 FLORIDA BUILDING CODE (FBC-B) WITH 2012 SUPPLEMENTS.
- FOR COORDINATION OF ANY REVISIONS REQUIRED AS A RESULT OF A CHANGE IN THE BUILDING MANUFACTURER, INCLUDING REDESIGN OF THE FOUNDATIONS.

8. THE FOUNDATION DESIGN IS BASED UPON THE "AMERICAN BUILDINGS" BUILDING SYSTEM. THE CONTRACTOR SHALL BE RESPONSIBLE

9. THE SIZE, NUMBER AND PLACEMENT PATTERN OF ALL ANCHOR BOLTS SHALL BE DETERMINED BY THE PRE-ENGINEERED BUILDING MANUFACTURER. ANCHOR BOLT EMBEDMENTS ARE INDICATED ON THE DRAWINGS.

10. THE PRE-ENGINEERED METAL BUILDING SHALL BE DESIGNED BY THE MANUFACTURER TO RESIST LATERAL LOADS AS FOLLOWS:

INTERIOR FRAME LINES - RIGID FRAMES (PINNED-BASED COLUMNS)

- PERIMETER WALL LINES BRACED BAYS OR PORTAL FRAMES 11. THE METAL BUILDING ERECTOR SHALL PROVIDE ALL TEMPORARY GUYING AND BRACING (SEE 'GENERAL STRUCTURAL NOTES').
- 12. UNLESS OTHERWISE NOTED OR SPECIFIED, ALL STEEL MEMBERS SHALL BE CLEANED AND PAINTED IN ACCORDANCE WITH MANUFACTURER'S STANDARD PROCEDURES.
- 13. THE FOUNDATIONS HAVE BEEN DESIGNED FOR THE REACTIONS SHOWN ON SHEET AB-7 OF THE SHOP DRAWINGS PROVIDED BY AMERICAN BUILDINGS, DATED 05/22/2015. THEY ARE BASED ON PINNED COLUMN BASES. NO "FIXED BASE" COLUMNS ARE PERMITTED WITHOUT THE ENGINEER'S WRITTEN APPROVAL

STRUCTURAL NARRATIVE

THESE STRUCTURAL DOCUMENTS INCLUDE THE DESIGN OF THE PRE-ENGINEERED METAL BUILDING COLUMN FOOTINGS, SLAB-ON-GRADE AS NOTED, CMU WALL FOUNDATIONS, PARTITION SUPPORT STEEL AS NOTED AND THE EXTERIOR MASONRY WALLS TO PROVIDE LATERAL STABILITY OF THE PRE-ENGINEERED METAL BUILDING SYSTEM.



MARIANNA 850/482-3045 TALLAHASSEE 850/671-7221

Certificate No. EB-0005637 LB-006435 LC-0000277



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KIMBERLY M. HOLLOWAY, P.E.

FLORIDA LICENSE NO.: 69166

1 (0) 101011				
Date:	No.	Description:		

KMH Drawn By: Checked By: KMH & OSM

Date: 10 JUNE 2015

Project No.:

Drawing Title:

STRUCTURAL **NOTES**

14033

TYP. 3 2 SLOPE ► 4:12 3 3 3 3 8'-0" TYP. 3 SLOPE 4:12 3 SLOPE 50 4:12 50 ₩

8'-0"

COMPONENTS AND CLADDING WIND PRESSURES

ROOF ULTIMATE WIND PRESSURES FOR 4:12 SLOPE

ZONE	EFFECTIVE WIND AREA, SF	WIND PRESSURE PRESSURE	AND SUCTION (PSF) SUCTION
1	10	+16.0	-22.9
•	20	+16.0	-22.3
	50	+16.0	-21.4
	100	+16.0	-20.8
2	10	+16.0	-39.9
	20	+16.0	-36.7
	50	+16.0	-32.5
	100	+16.0	-29.3
3	10	+16.0	-59.0
	20	+16.0	-55.2
	50	+16.0	-50.1
	100	+16.0	-46.3
2 O.H.	10	+16.0	-46.7
	20	+16.0	-46.7
	50	+16.0	-46.7
	100	+16.0	-46.7
	500	+16.0	-46.7
3 O.H.	10	+16.0	-78.5
	20	+16.0	-70.9
	50	+16.0	-60.7
	100	+16.0	-53.1
	500	+16.0	-53.1

"a"=8'-0"

WALL ULTIMATE WIND PRESSURES AT 4:12 SLOPE

ZONE	EFFECTIVE WIND AREA, SF	WIND PRESSURE A	AND SUCTION (PSF
4	10	+25.0	-27.2
T	20	+23.9	-27.2 -26.0
	50	+22.4	-24.6
	100	+21.3	-23.4
	500	+18.7	-20.8
5	10	+25.0	-33.5
-	20	+23.9	-31.3
	50	+22.4	-28.3
	100	+21.3	-26.0
	500	+18.7	-20.8
"-" O' O"			

"a"=8'-0"

LEGEND:			
	WIND	LOAD	SEPARATION

OVERHANG

ROOF ULTIMATE WIND PRESSURES FOR 1:12 ROOF

ZONE	EFFECTIVE WIND AREA, SF	WIND PRESSURE PRESSURE	AND SUCTION (PSF) SUCTION
1	10	+16.0	-25.0
'	20	+16.0	-24.4
	50	+16.0	-23.6
	100	+16.0	-22.9
2	10	+16.0	-42.0
	20	+16.0	-37.6
	50	+16.0	-31.6
	100	+16.0	-27.2
3	10	+16.0	-63.3
	20	+16.0	-52.4
	50	+16.0	-38.0
	100	+16.0	-27.2
1&2 O.H.	10	+16.0	-36.1
	20	+16.0	-35.4
	50	+16.0	-34.6
	100	+16.0	-34.0
3 O.H.	10	+16.0	-59.4
	20	+16.0	-46.7
	50	+16.0	-29.8
	100	+16.0	-17.0


"a"=8'-0"

WALL ULTIMATE WIND PRESSURES AT 1:12 SLOPE

	EEEEOTIVE WIND	WIND DESCRIPE	AND CHOTION (DCE)
ZONE	AREA, SF	PRESSURE	AND SUCTION (PSF) SUCTION
4	10	+22.9	-24.8
	20	+21.9	-23.8
	50	+20.6	-22.5
	100	+19.6	-21.5
	500	+17.2	-19.1
5	10	+22.9	-30.6
	20	+21.9	-28.5
	50	+20.6	-25.9
	100	+19.6	-23.8
	500	+17.2	-19.1

"a"=8'-0"

C&C WALL DIAGRAM

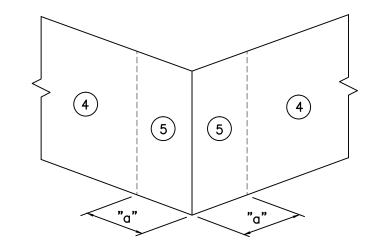





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FLORIDA LICENSE NO.: 69166

Revisio	n	
Date:	No.	Description:
Drawn F	3v:	KMH

Checked By: KMH & OSM

Date: 10 JUNE 2015

Project No.: 14033

Drawing Title:

C&C WIND LOAD DIAGRAMS AND PRESSURES

Drawing No.: S101

FOOTING SCHEDULE									
			REINFO	RCING					
MARK	SIZE	THICKNESS	BOTTOM STEEL	TOP STEEL	COMMENTS				
F2-6	2'-6"x2'-6"	2'-0"	(5) #5 x 2'-0" EACH WAY	(5) #5 x 2'-0" EACH WAY					
F3-0	3'-0"x3'-0"	2'-0"	(5) #5 x 2'-6" EACH WAY	(5) #5 x 2'-6" EACH WAY					
F3-6	3'-6"x3'-6"	2'-0"	(6) #5 x 3'-0" EACH WAY	(6) #5 x 3'-0" EACH WAY					
F4-0	4'-0"x4'-0"	2'-0"	(7) #5 x 3'-6" EACH WAY	(7) #5 x 3'-6" EACH WAY					
F4-6	4'-6"x4'-6"	2'-0"	(8) #5 x 4'-0" EACH WAY	(8) #5 x 4'-0" EACH WAY					
F5-0	5'-0"x5'-0"	2'-0"	(9) #5 x 4'-6" EACH WAY	(9) #5 x 4'-6" EACH WAY					
F6-0	6'-0"x6'-0"	2'-0"	(10) #5 x 5'-6" EACH WAY	(10) #5 x 5'-6" EACH WAY					

SHEET LEGEND:

U.O.N. = UNLESS OTHERWISE NOTED.

A.F.F. = ABOVE FINISH FLOOR.

S.C. = INDICATES SAW CUT. (SEE SECTION 4/S400)

B.F.F. = BELOW FINISH FLOOR.

= INDICATES VERTICAL BAR IN GROUTED CELL. INSTALL AT LOCATIONS SHOWN AND NOTED ON THE PLAN SHEETS.

T.O.F. = TOP OF FOOTING.

F.F. = FINISH FLOOR.

PLCS. = PLACES.

W.C.J. = INDICATES WALL CONTROL JOINT. (SEE SECTION 2/S500)

FOUNDATION NOTES:


1. SEE FOUNDATION NOTES ON SHEET S100.


2. SEE ARCHITECTURAL FOR WALLS AND DIMENSIONS NOT SHOWN.

3. VERIFY DOOR OPENINGS AND LOCATIONS WITH

4. VERIFY DIMENSIONS AND LOCATIONS OF RECESSED SLABS WITH ARCHITECTURAL.

5. ALL SLABS ARE AT +0'-0" REF. UNLESS NOTED OTHERWISE. SEE CIVIL DRAWINGS FOR FINISH FLOOR.

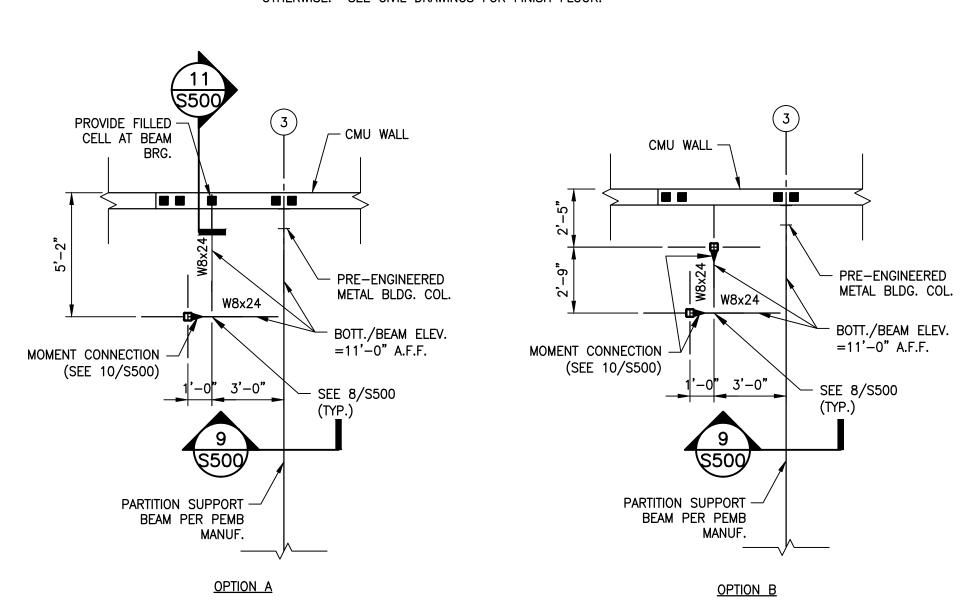

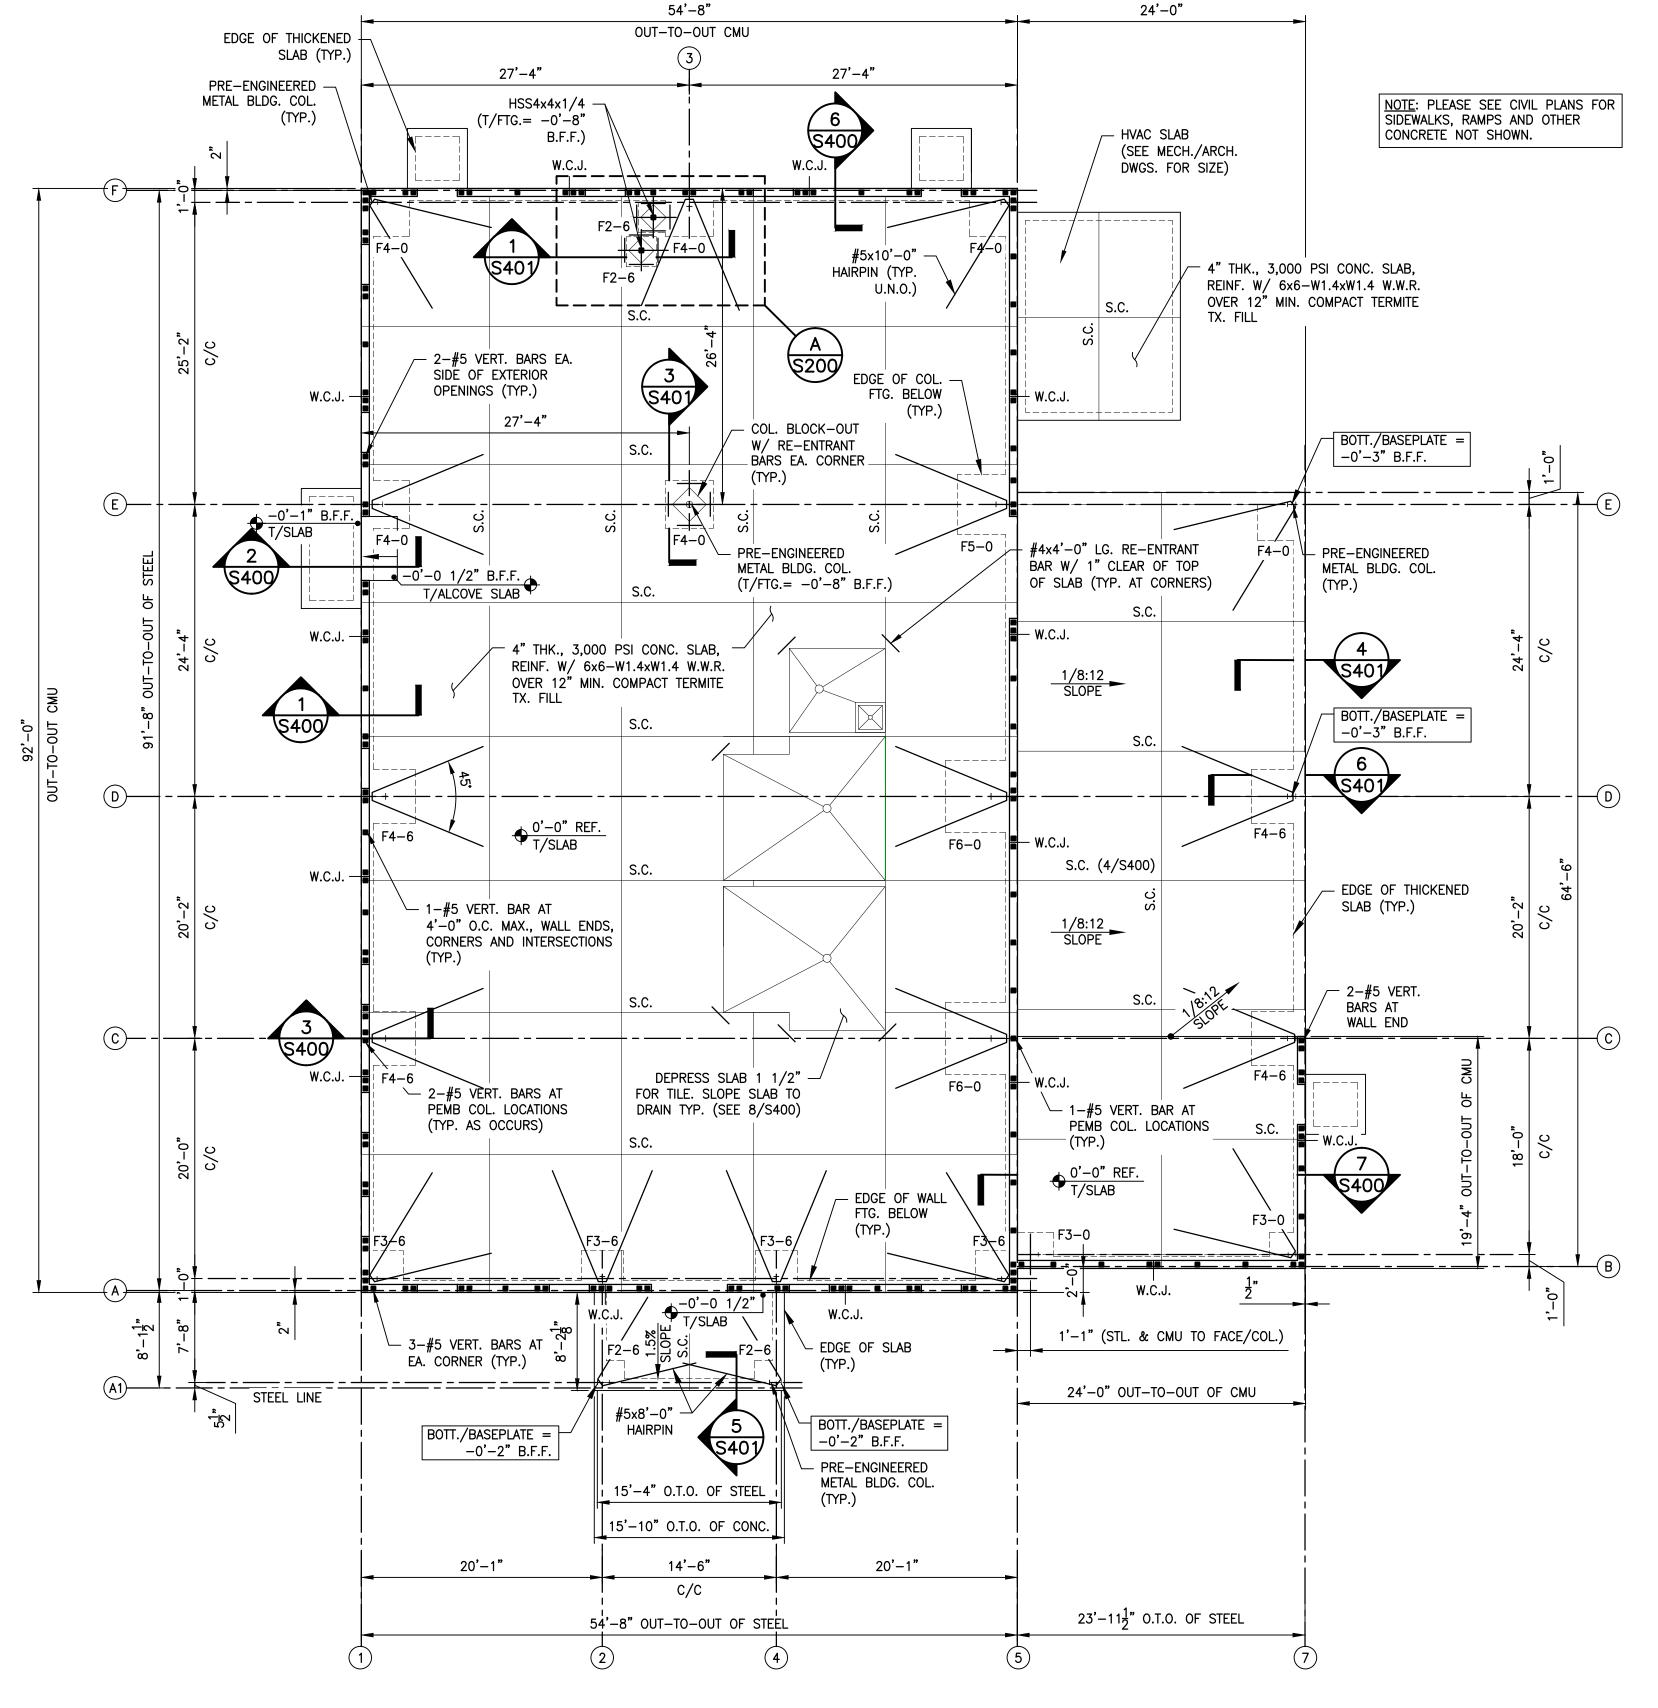





(DAVID H. MELVIN, INC. **Consulting Engineers** MARIANNA 850/482-3045 TALLAHASSEE 850/671-7221 Certificate No. EB-0005637 LB-006435 LC-0000277



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FLORIDA LICENSE NO.: 69166

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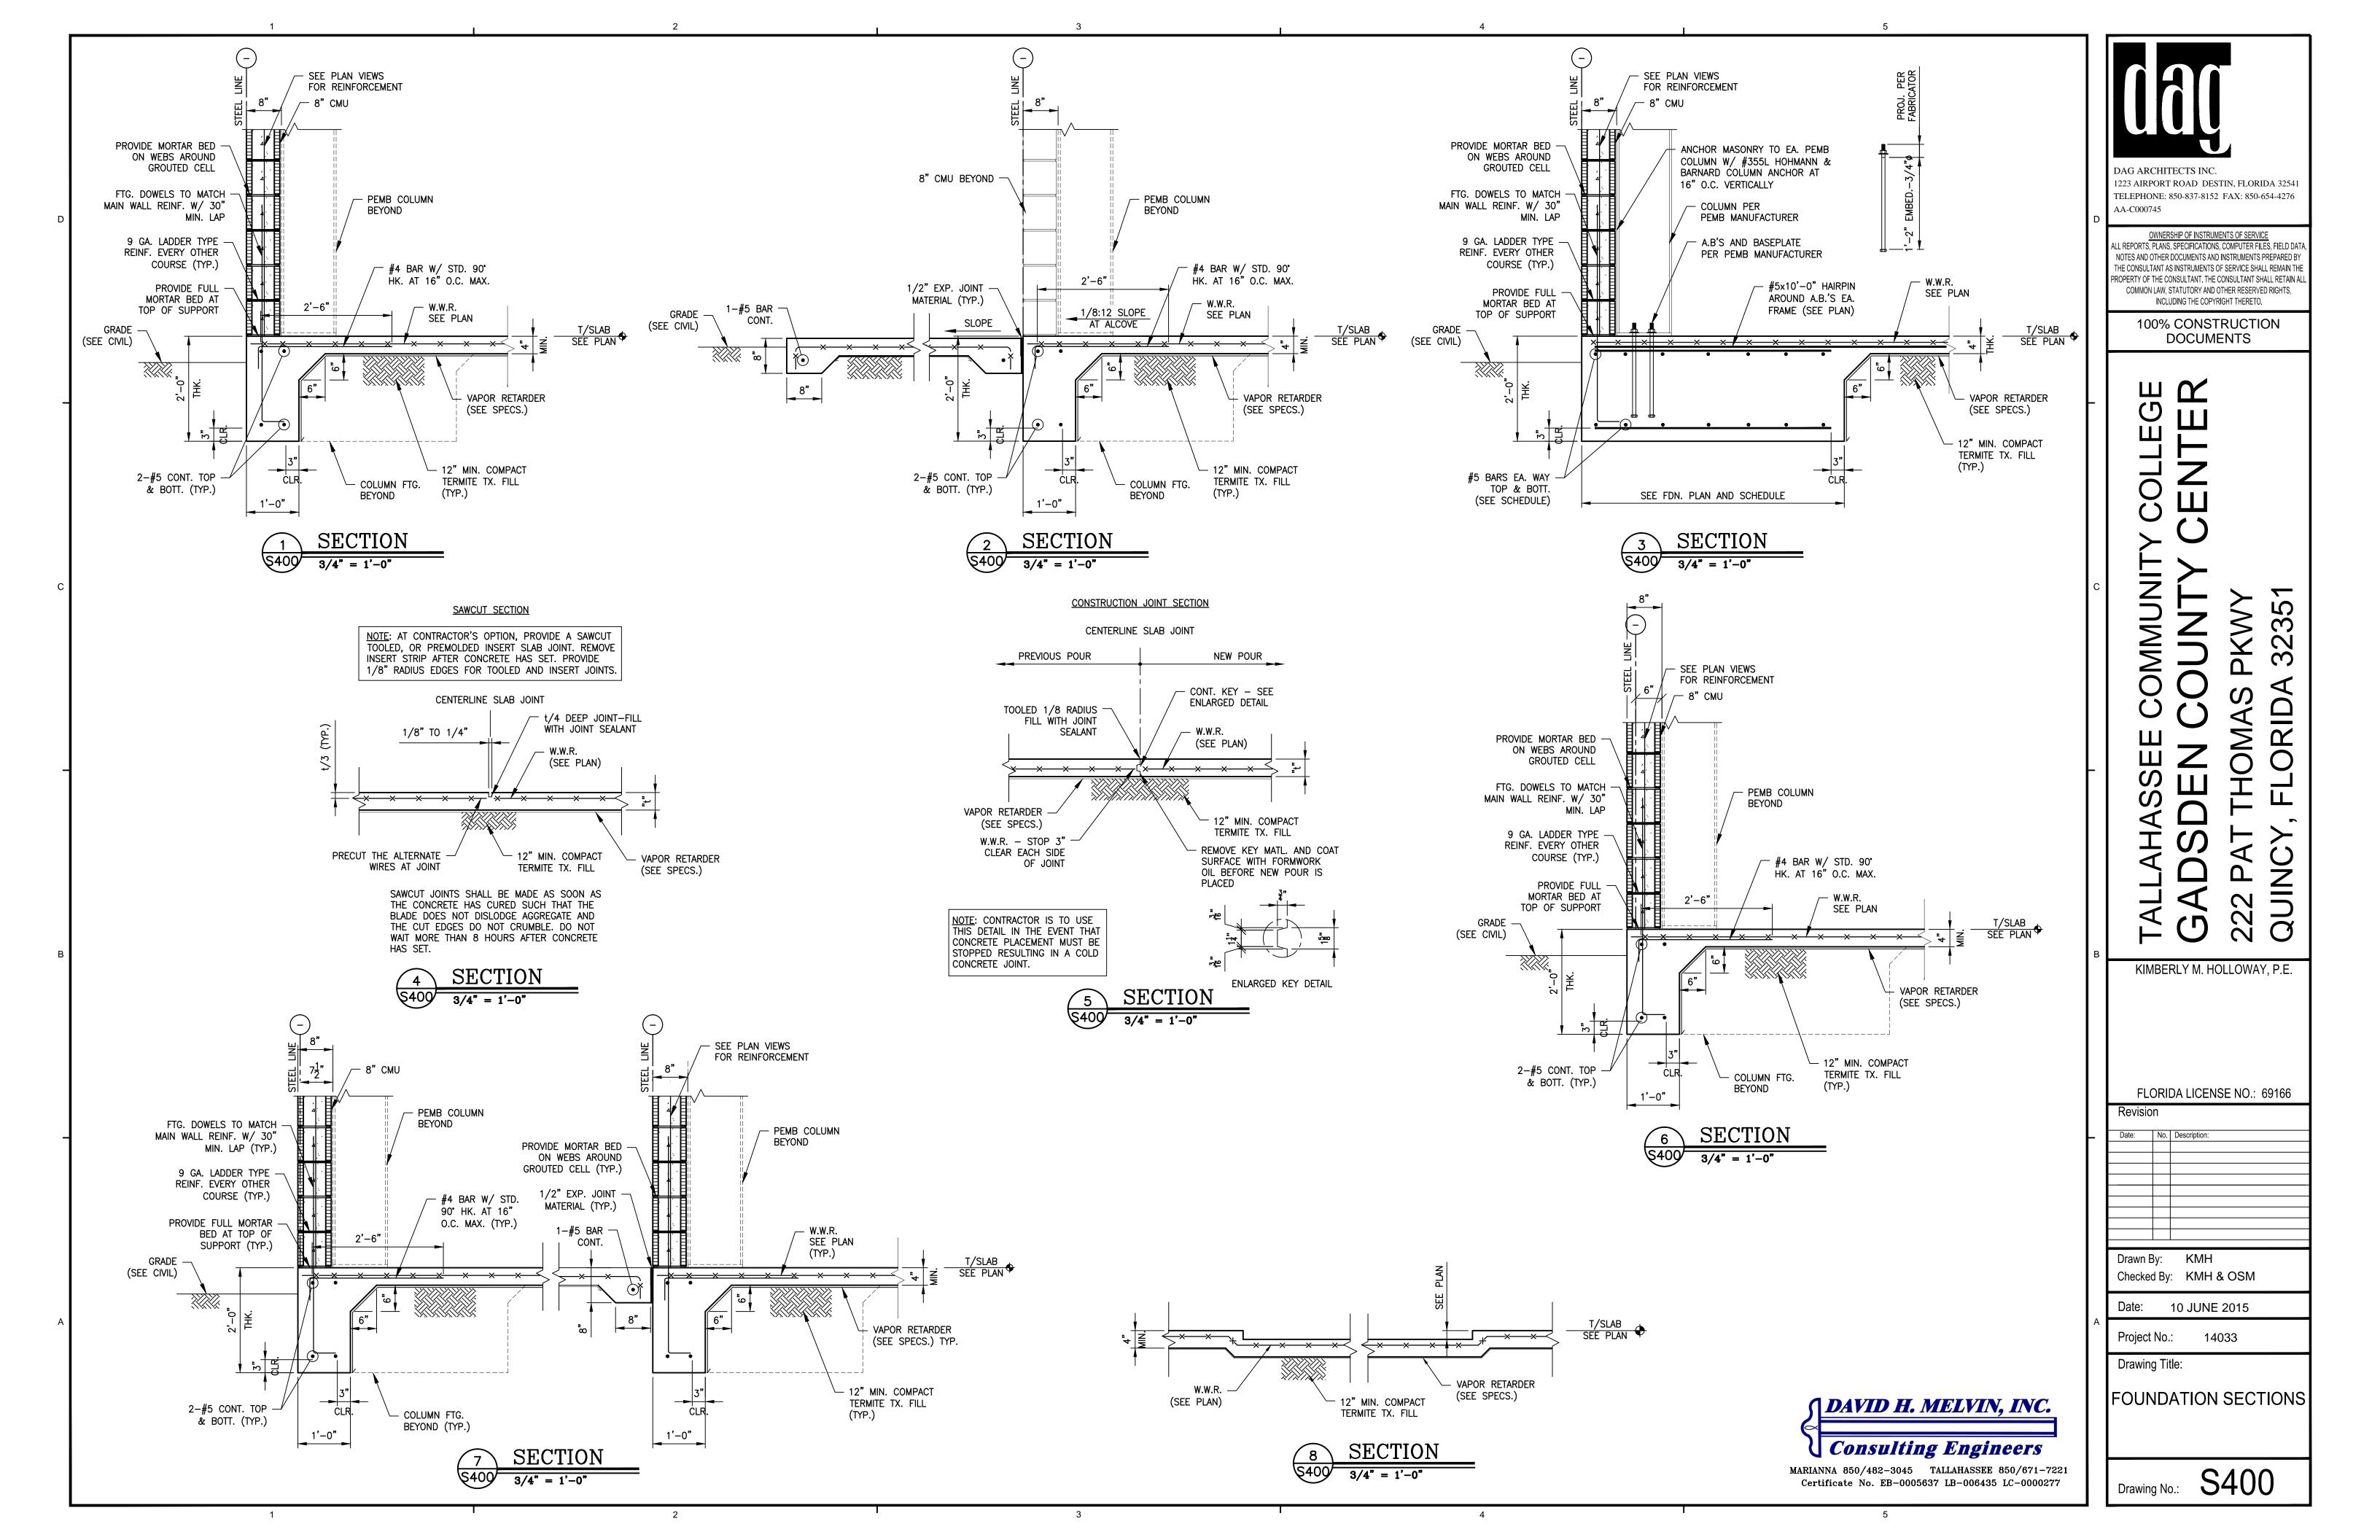
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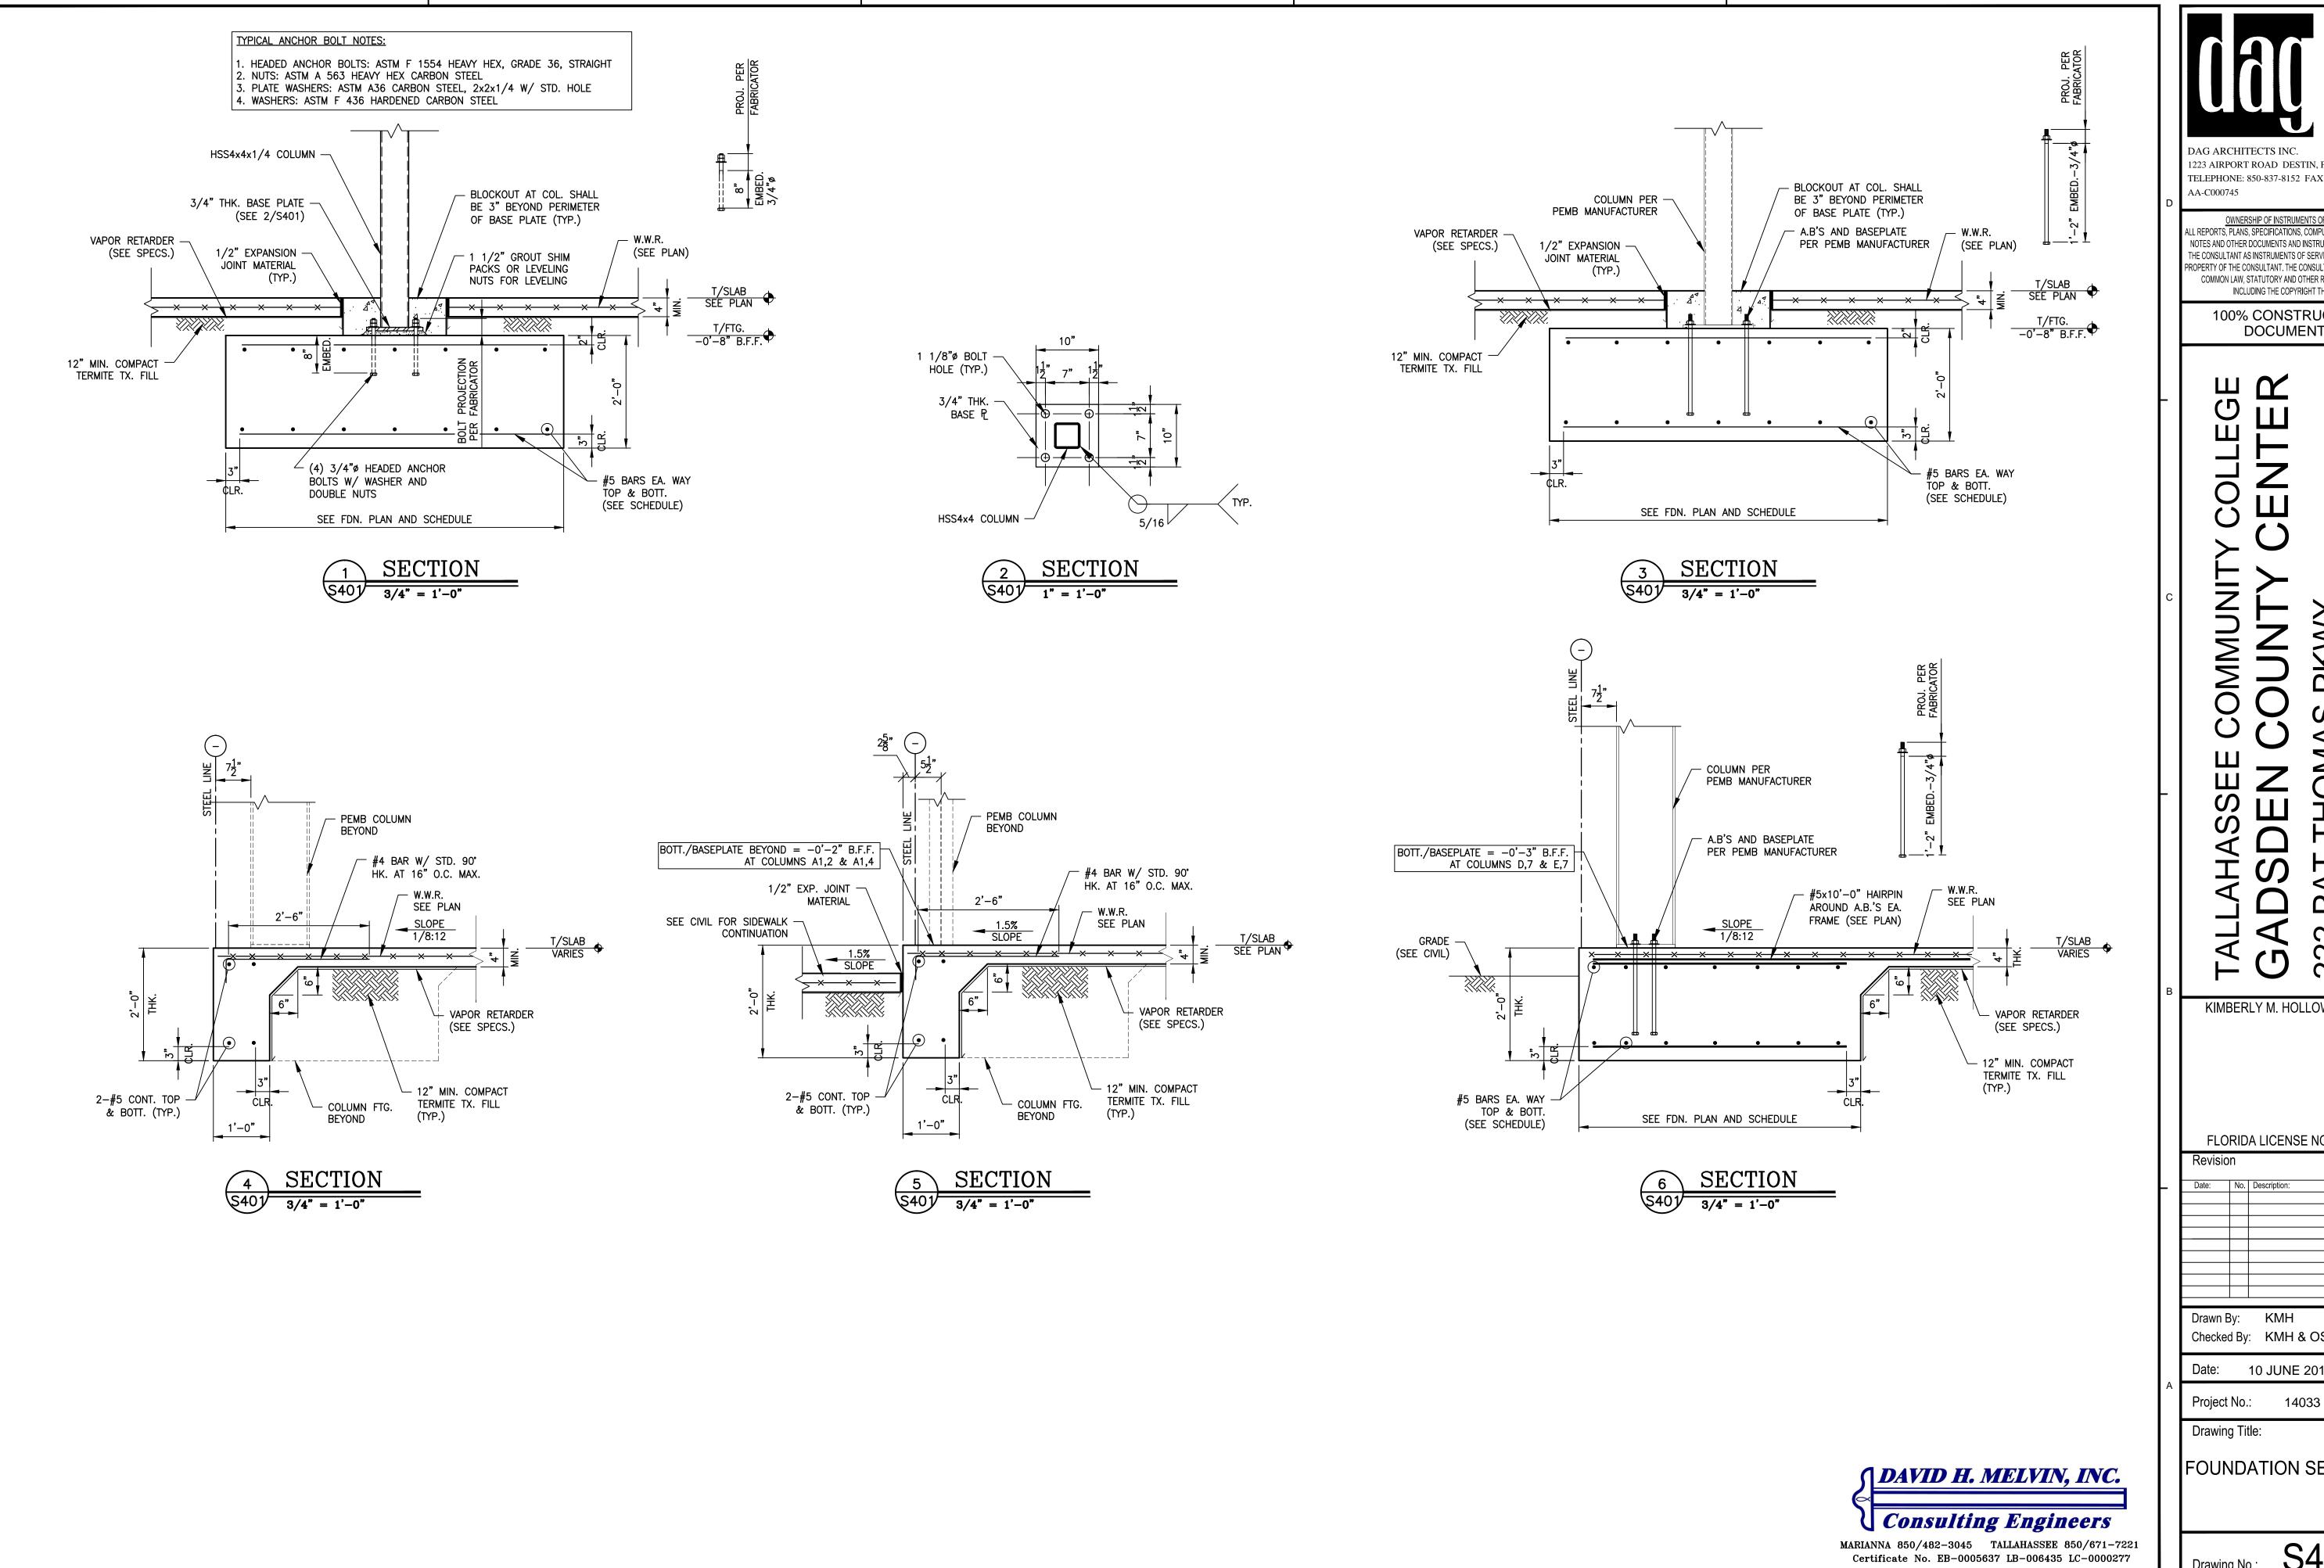
Project No.: 14033

Drawing Title:

FOUNDATION PLAN & **ENLARGED FRAMING** PLAN

Drawing No.: S200





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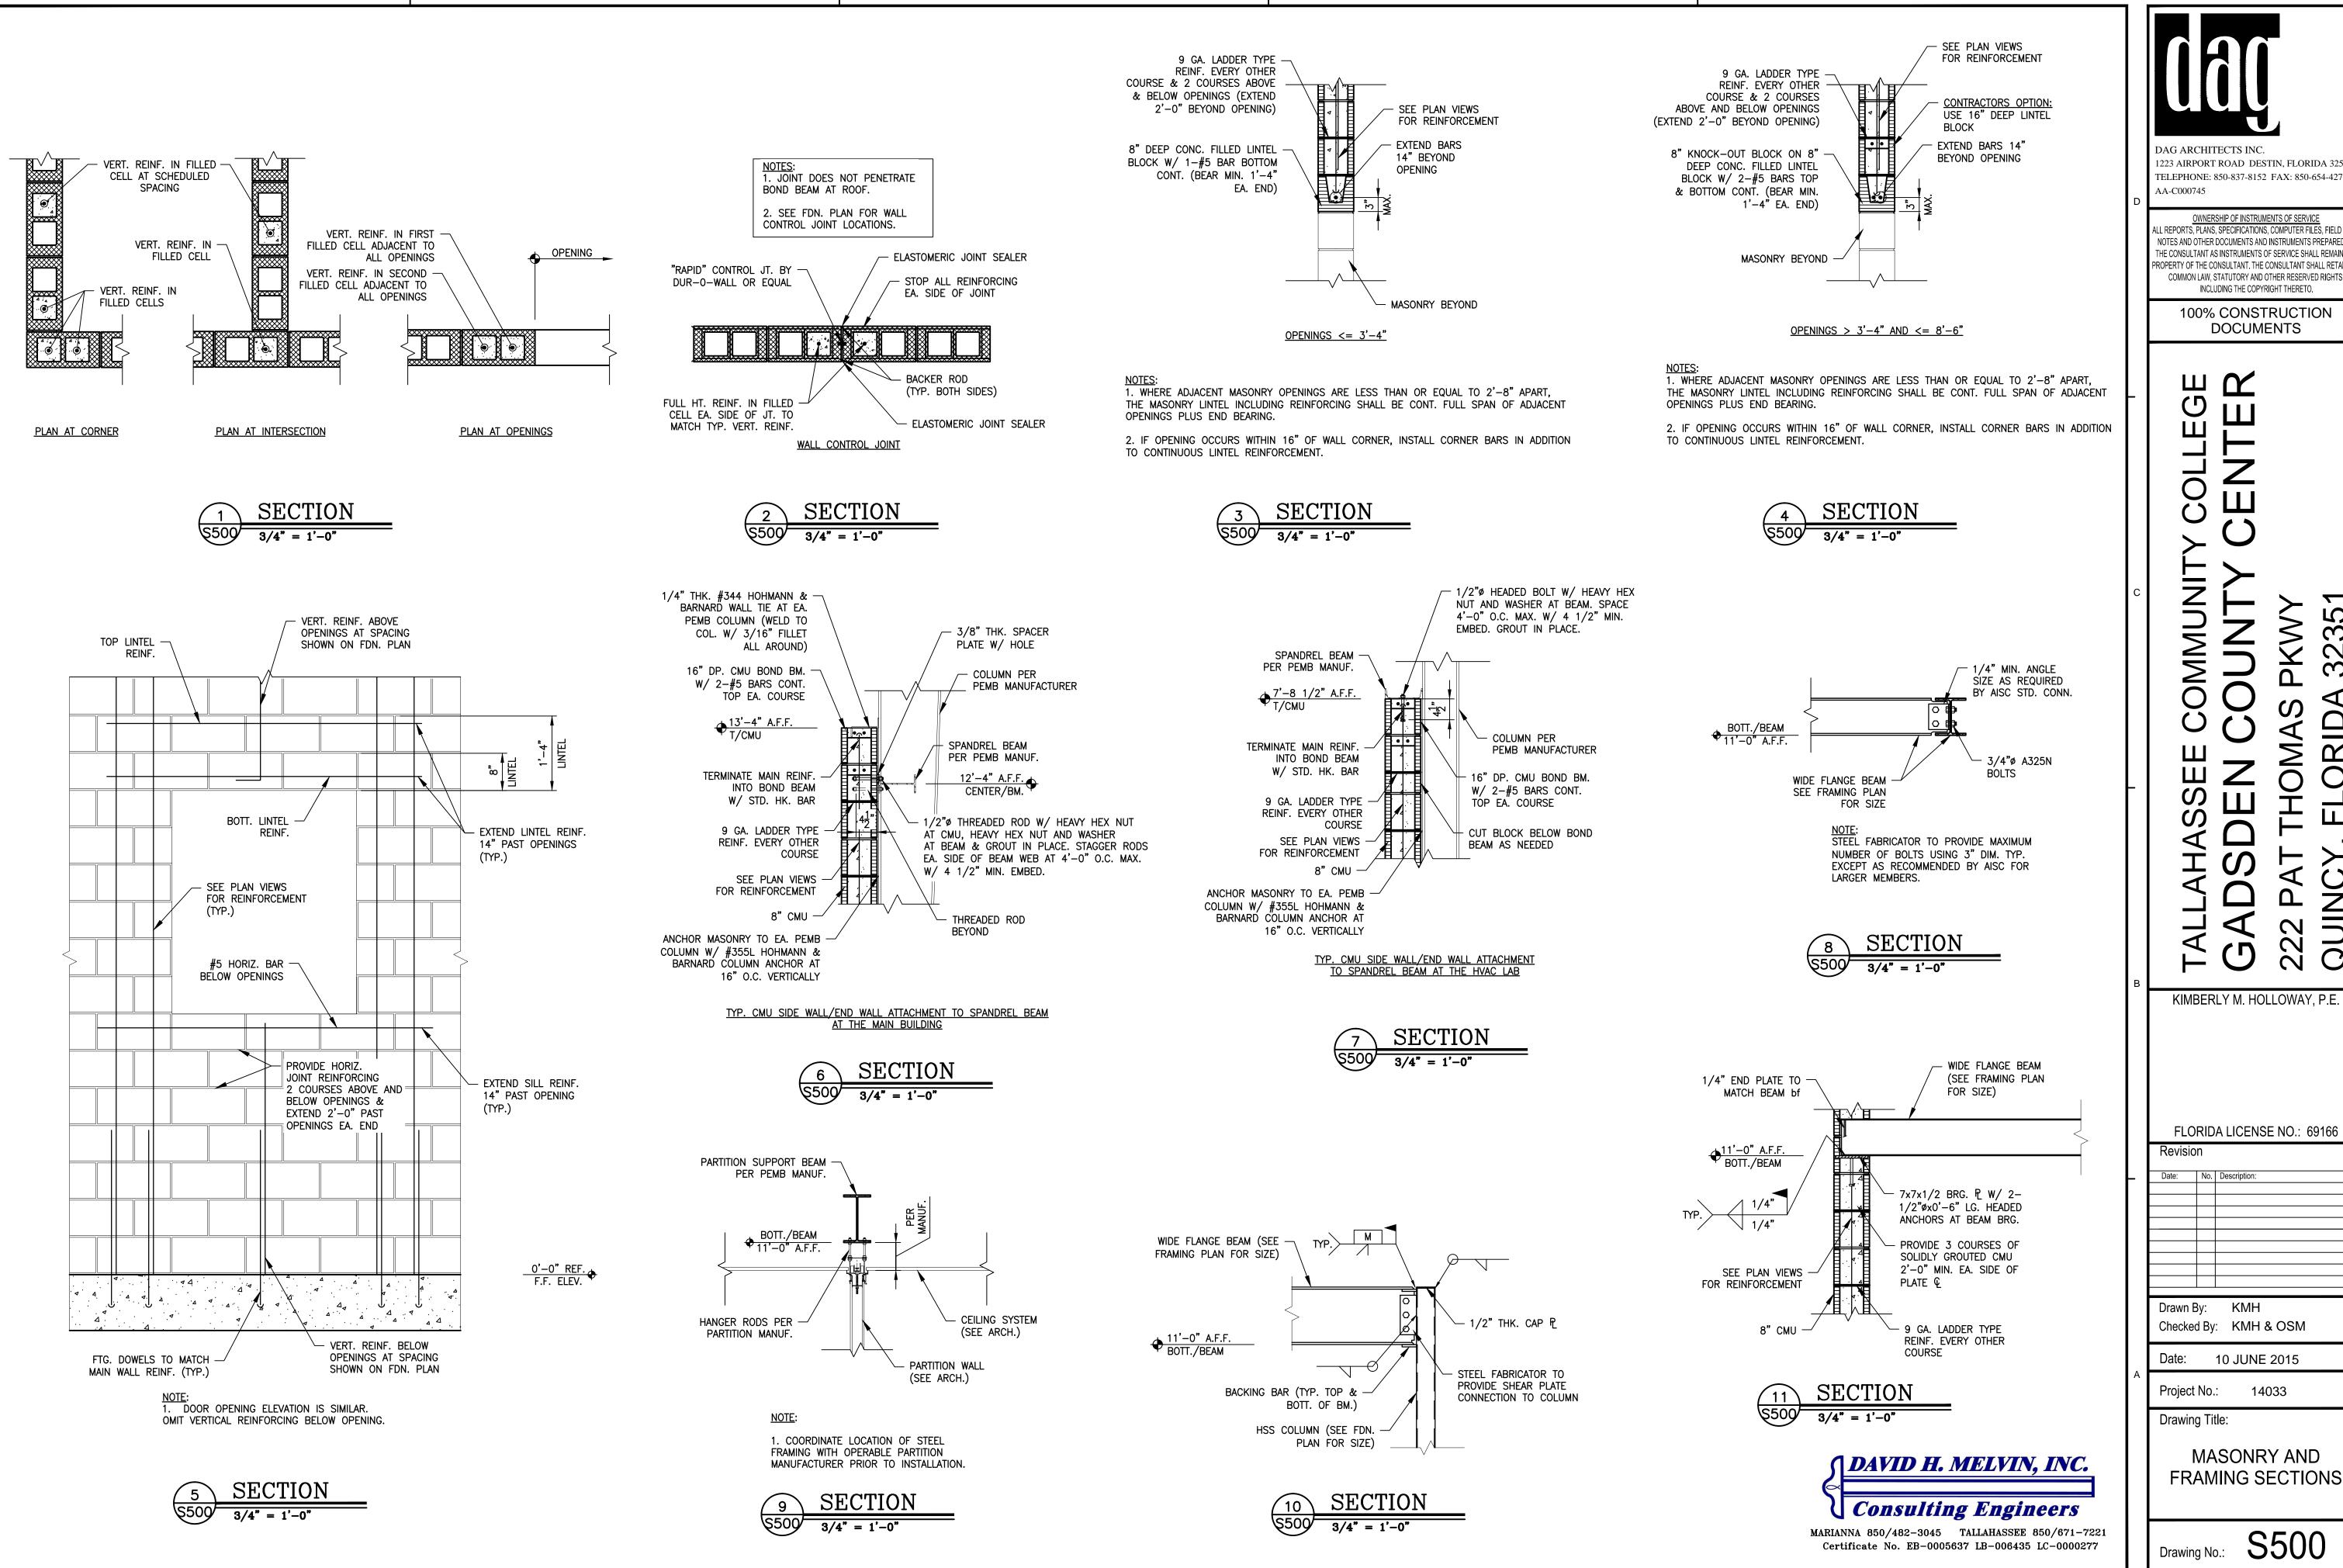
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FOUNDATION SECTIONS

S401 Drawing No.:



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Drawn By: KMH Checked By: KMH & OSM

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Drawing Title:


MASONRY AND FRAMING SECTIONS

14033

S500 Drawing No.:

Tallahassee Community College - Gadsden County Center

222 Pat Thomas Parkway, Quincy, Florida 32351

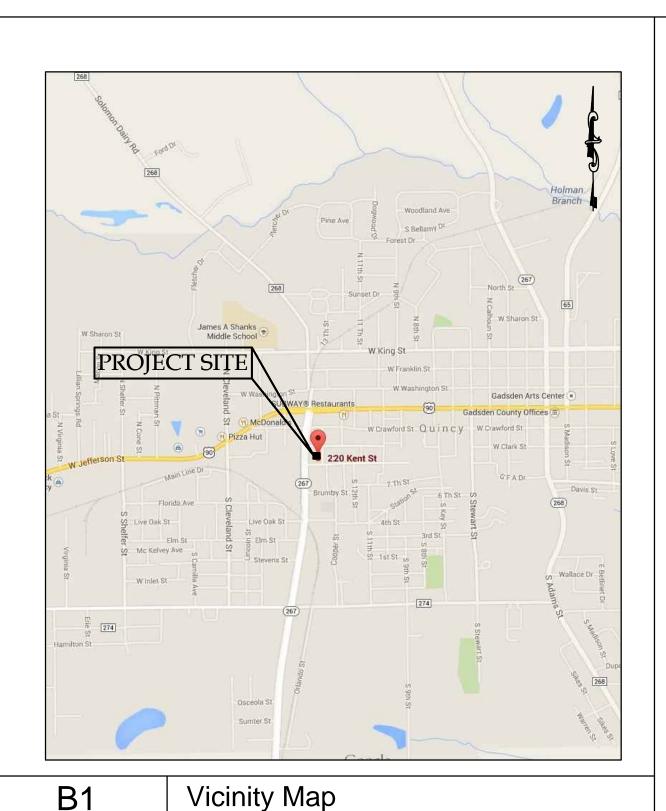



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	SCALE: NTS		KEVIN VAUG	HIN	IRUSTEE
	OWNER CONTACTS:	ARCHITECT:	STRUCTURAL:	PLUMBING/MECHANICAL:	ELECTRICAL:
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	CIVIL & SURVEYING:	TELECOMMUNICATIONS:			
4	George & Associates 1967 Commonwealth Lane, Suite 200 Tallahassee, Florida 32303 Phone: 850-521-0344 Fax: 850-521-0345	H2Engineering, Inc. 114 East Fifth Avenue Tallahassee, Florida 32303 Phone: 850-224-7922 Fax: 850-224-5876			
	PIC: Joesph W. Miller, P.E. Email: jmiller@gaceng.net	PIC: Matt Scaringe, P.E. Email: mscaringe@h2engineering.com			

GENERAL:

Set Cover Sheet - Project Stats, Sheet Index Design Team.

LIFE SAFETY:

Life Safety Plan and Code Summary

CIVIL:

Civil Cover Sheet **General Notes Existing Conditions Erosion Control Grading Plan** Drainage Plan Site Details Drainage Details Landscape

C&C Wind Load Diagrams and Pressures

Foundation Sections Foundation Sections

Foundation Plan & Enlarged Framing Plan

Masonry and Framing Sections

Door, Frame and Finish Schedule

Door and Window Details

ARCHITECTURAL:

Abbreviations and Symbol Partition Types A101 Floor Plan A102 Reflected Ceiling Plan A103 **Enlarged Plans and Interior Elevations Exterior Elevations**

PLUMBING:

General Notes, Legends and Schedules - Plumbing

Floor Plan - Plumbing Details - Plumbing

General Notes, Legends and Schedules - HVAC

Legends - Electrical General Notes and Schedules - Electrical

Site Plan - Electrical

Floor Plan - Lighting Floor Plan - Power Riser Diagram - Systems



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JACK DEYATTE BAKER, RA

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Checked By: JDB

10 JUNE 2015

Project No.:

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Cover Sheet Sheet Index

Design Team

Drawing No.: G001


Project Sheet Index A4


Project Teams and Discipline Allocation

A1


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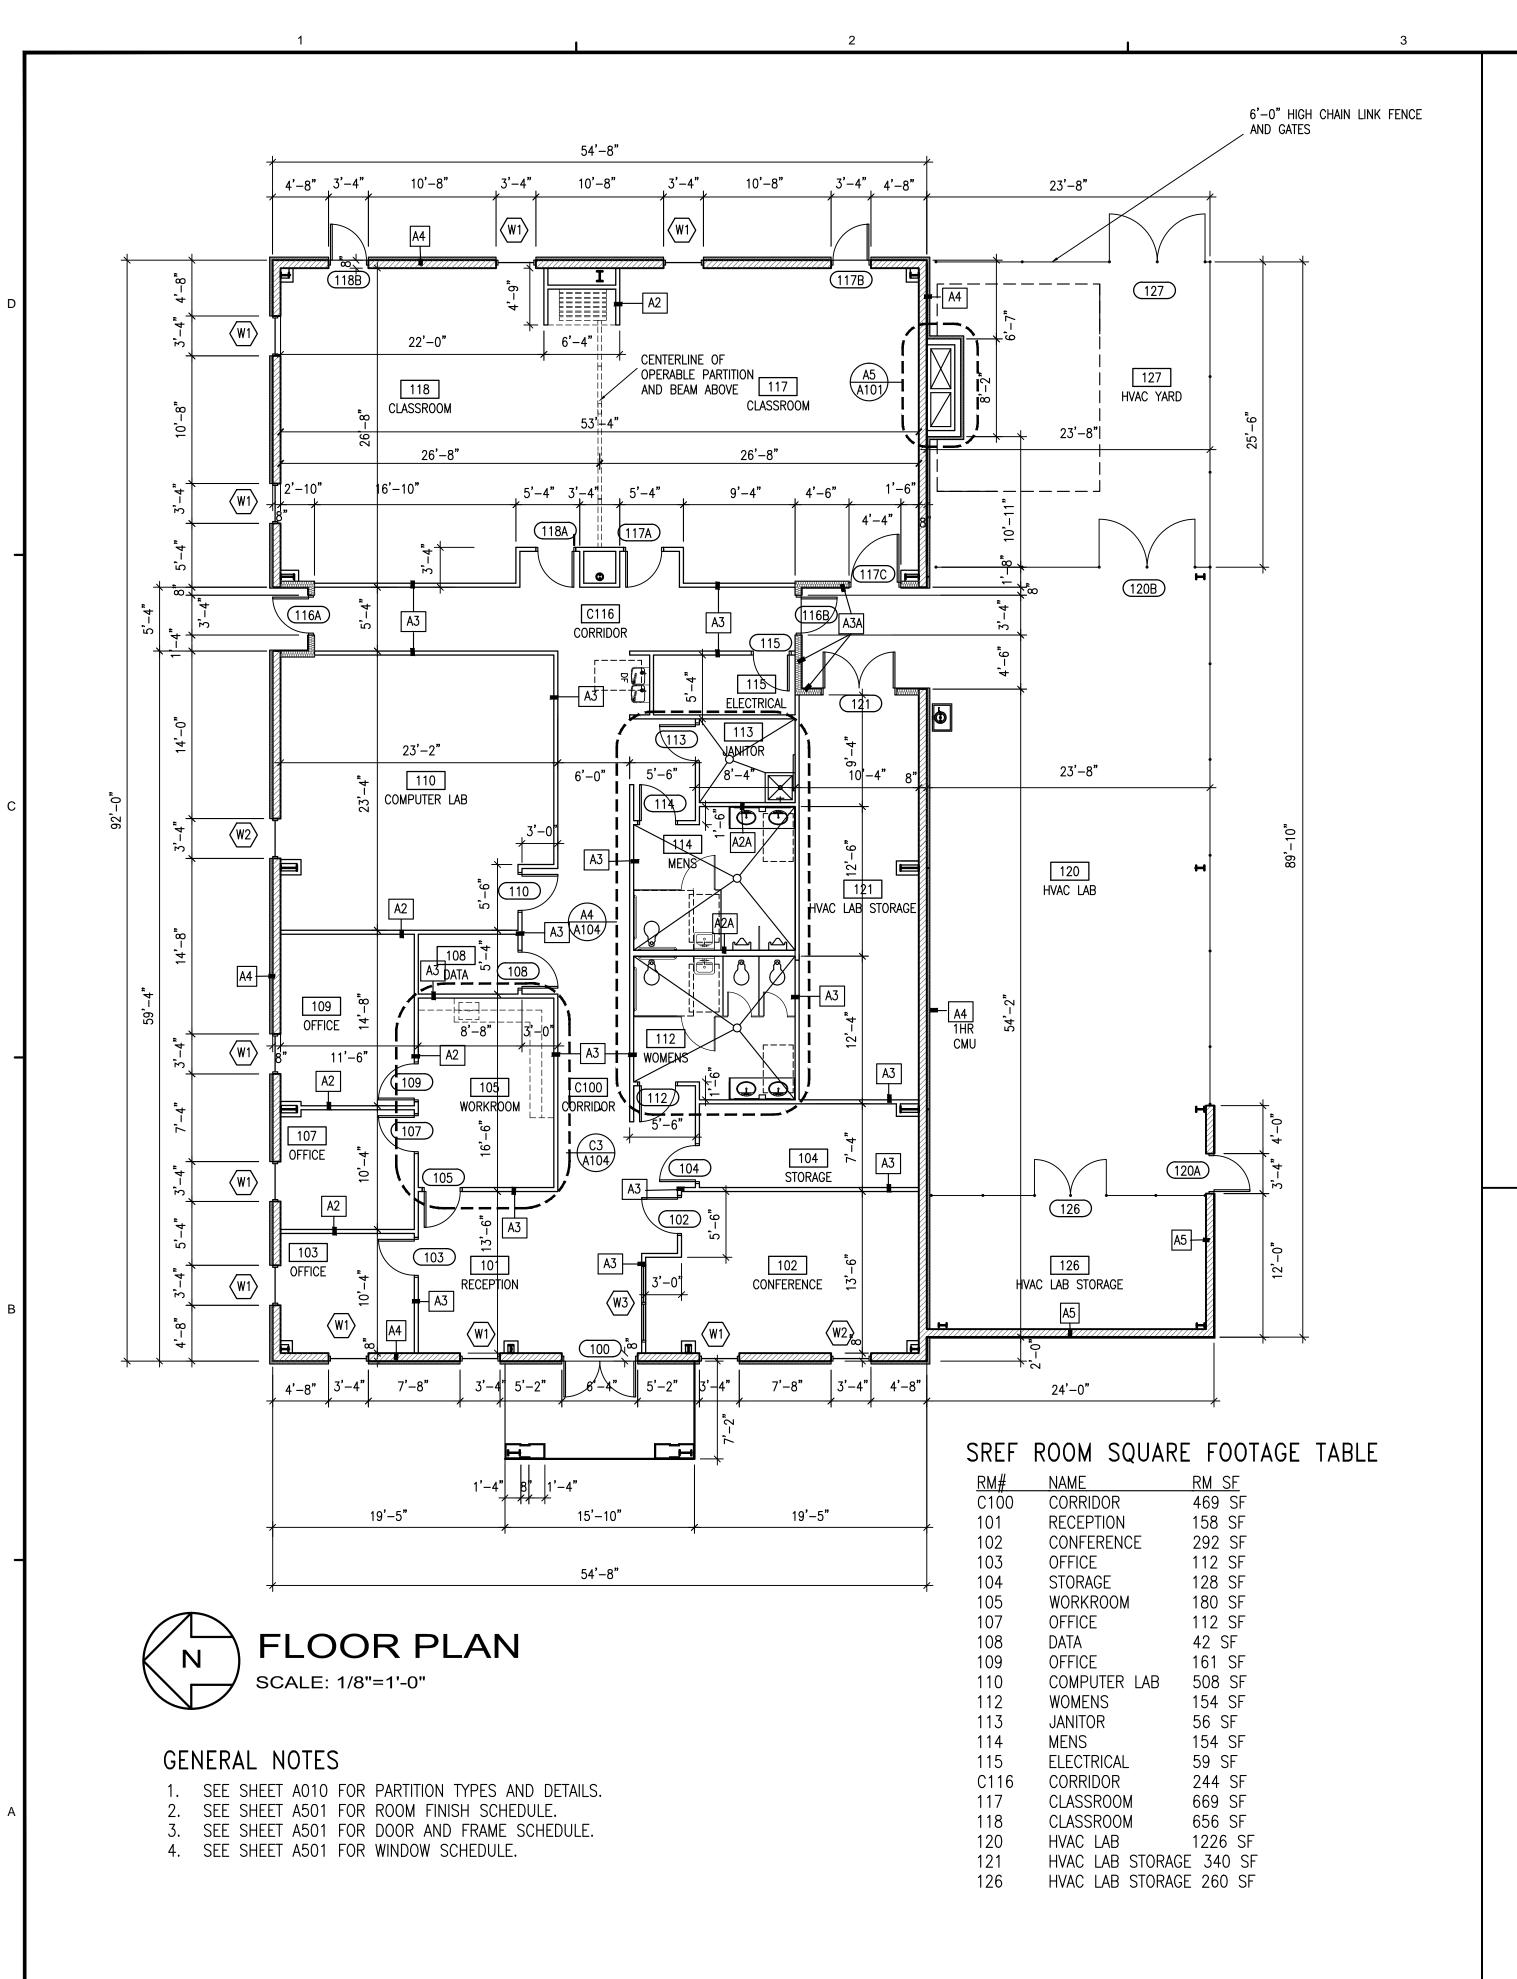
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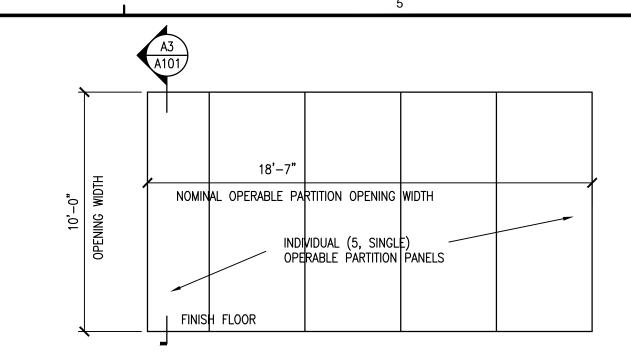


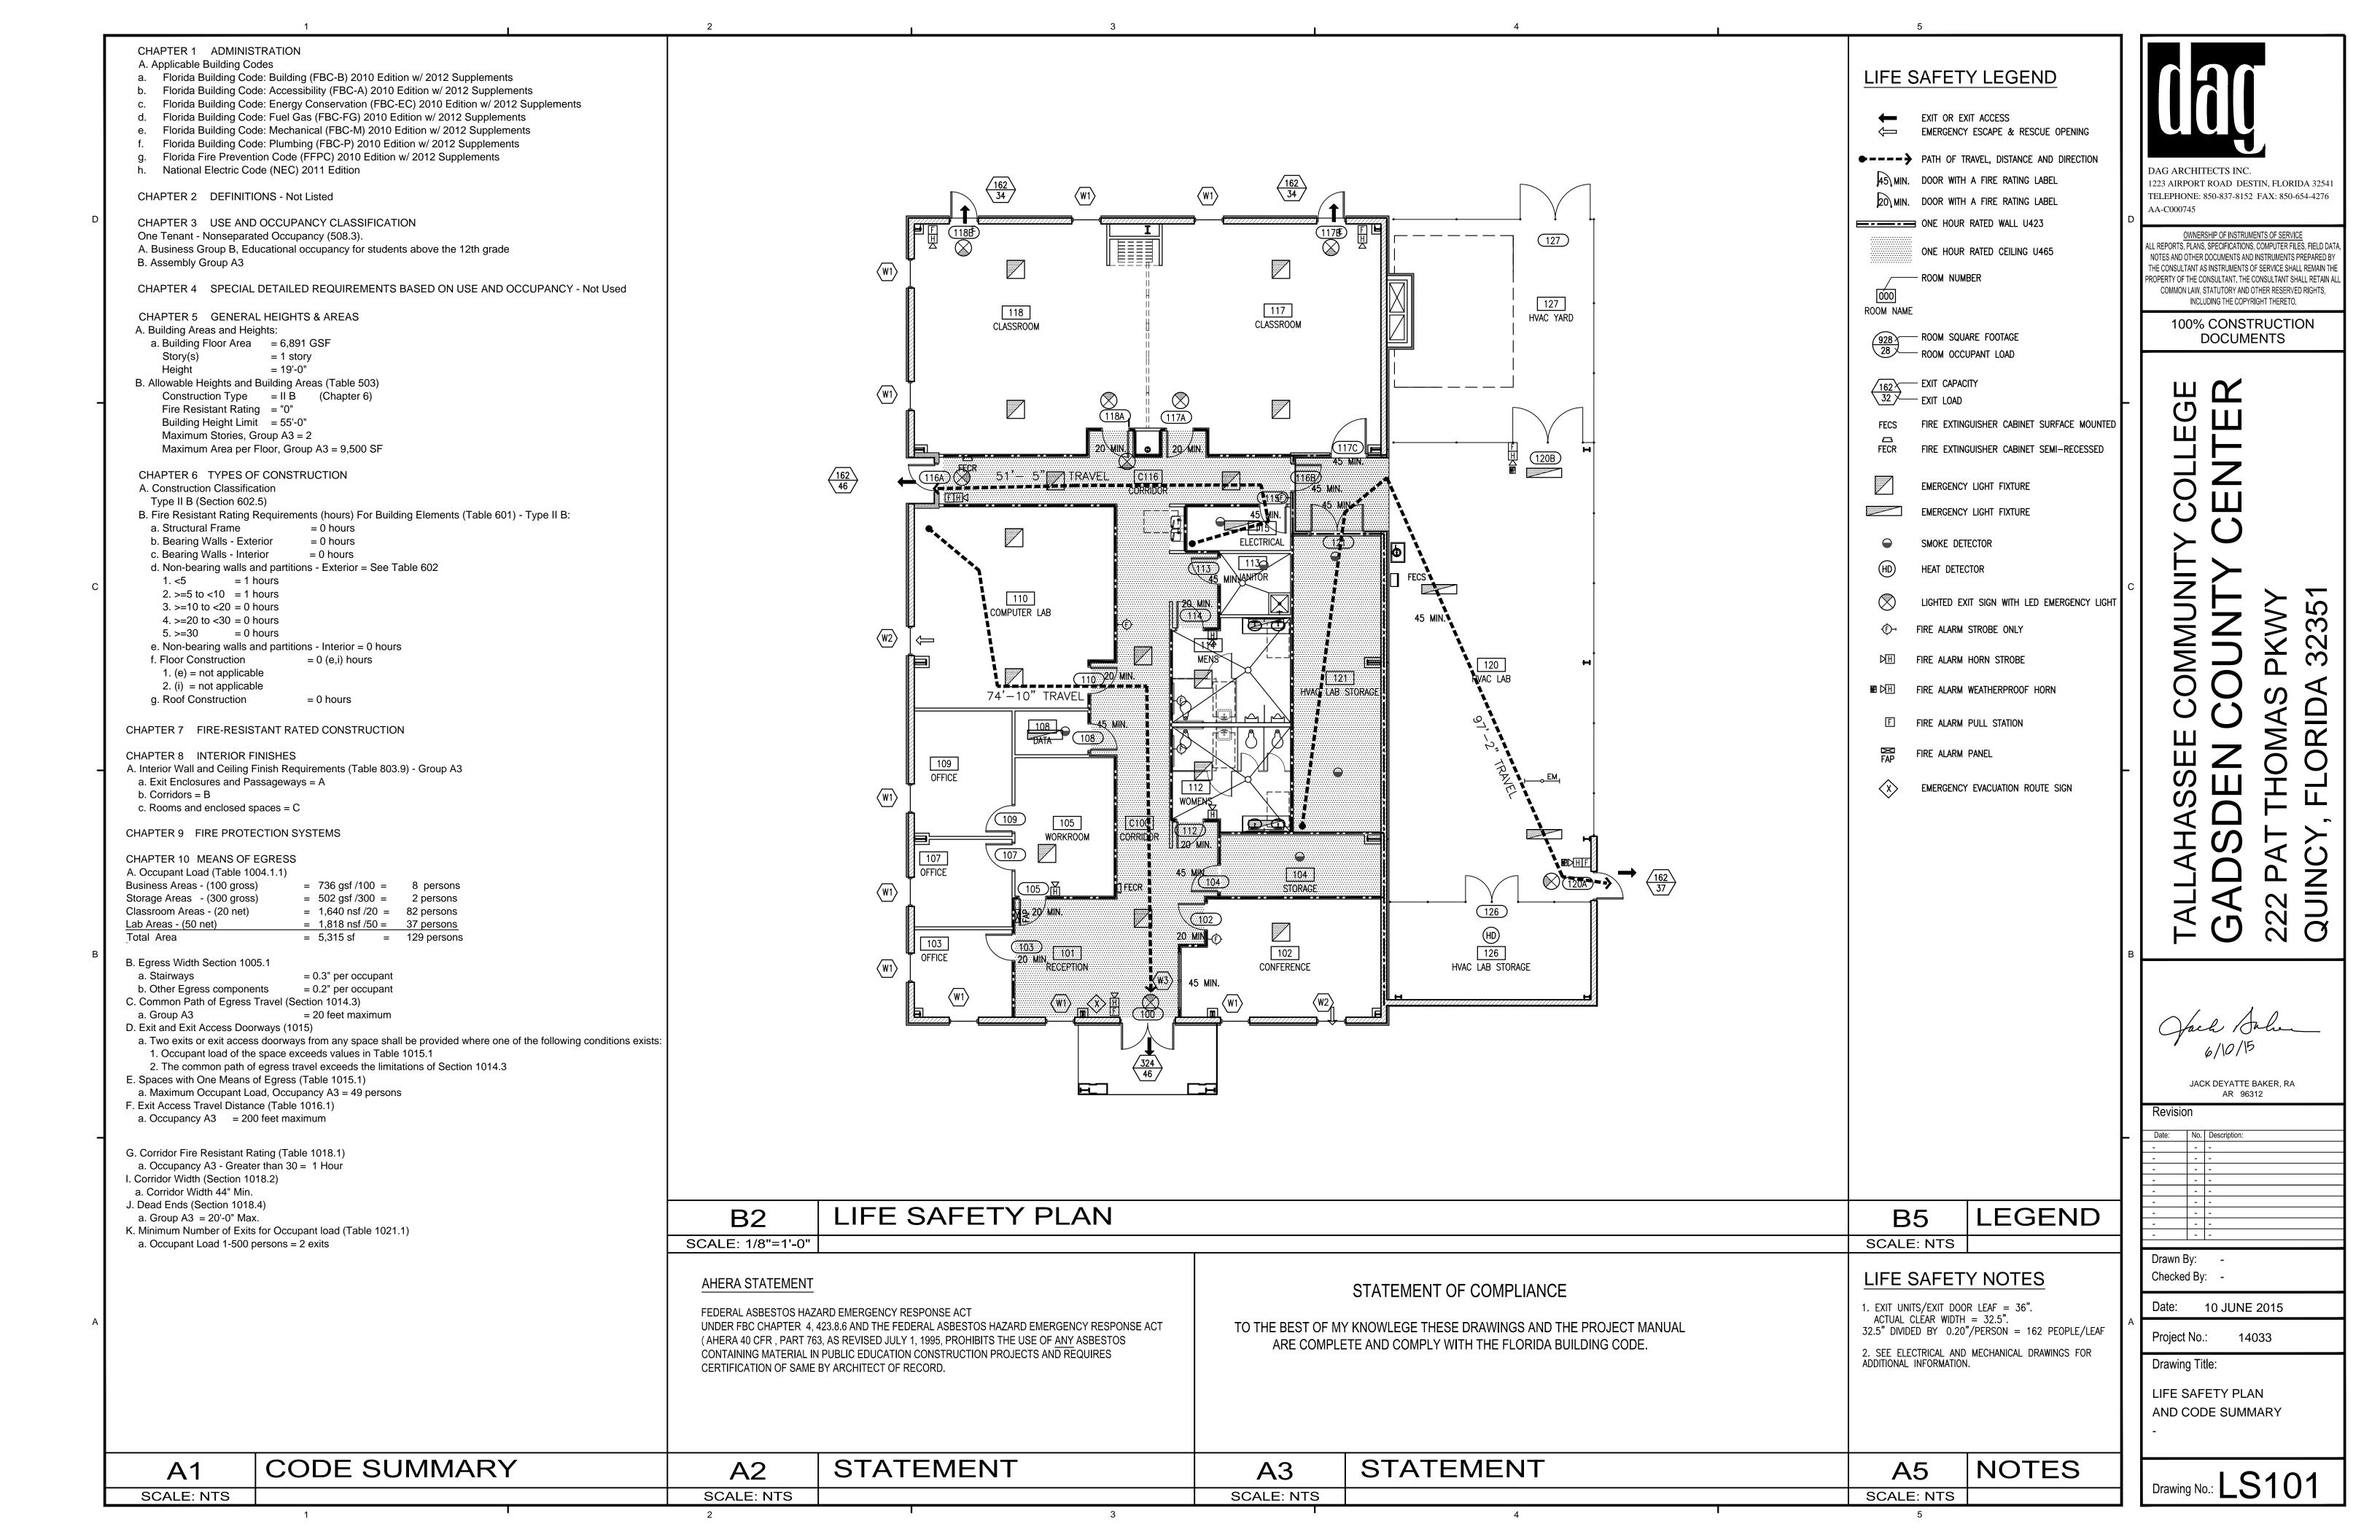



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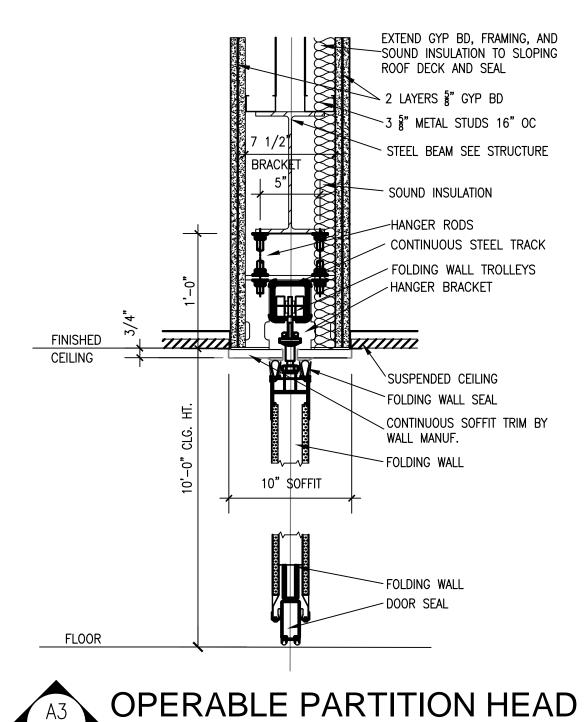


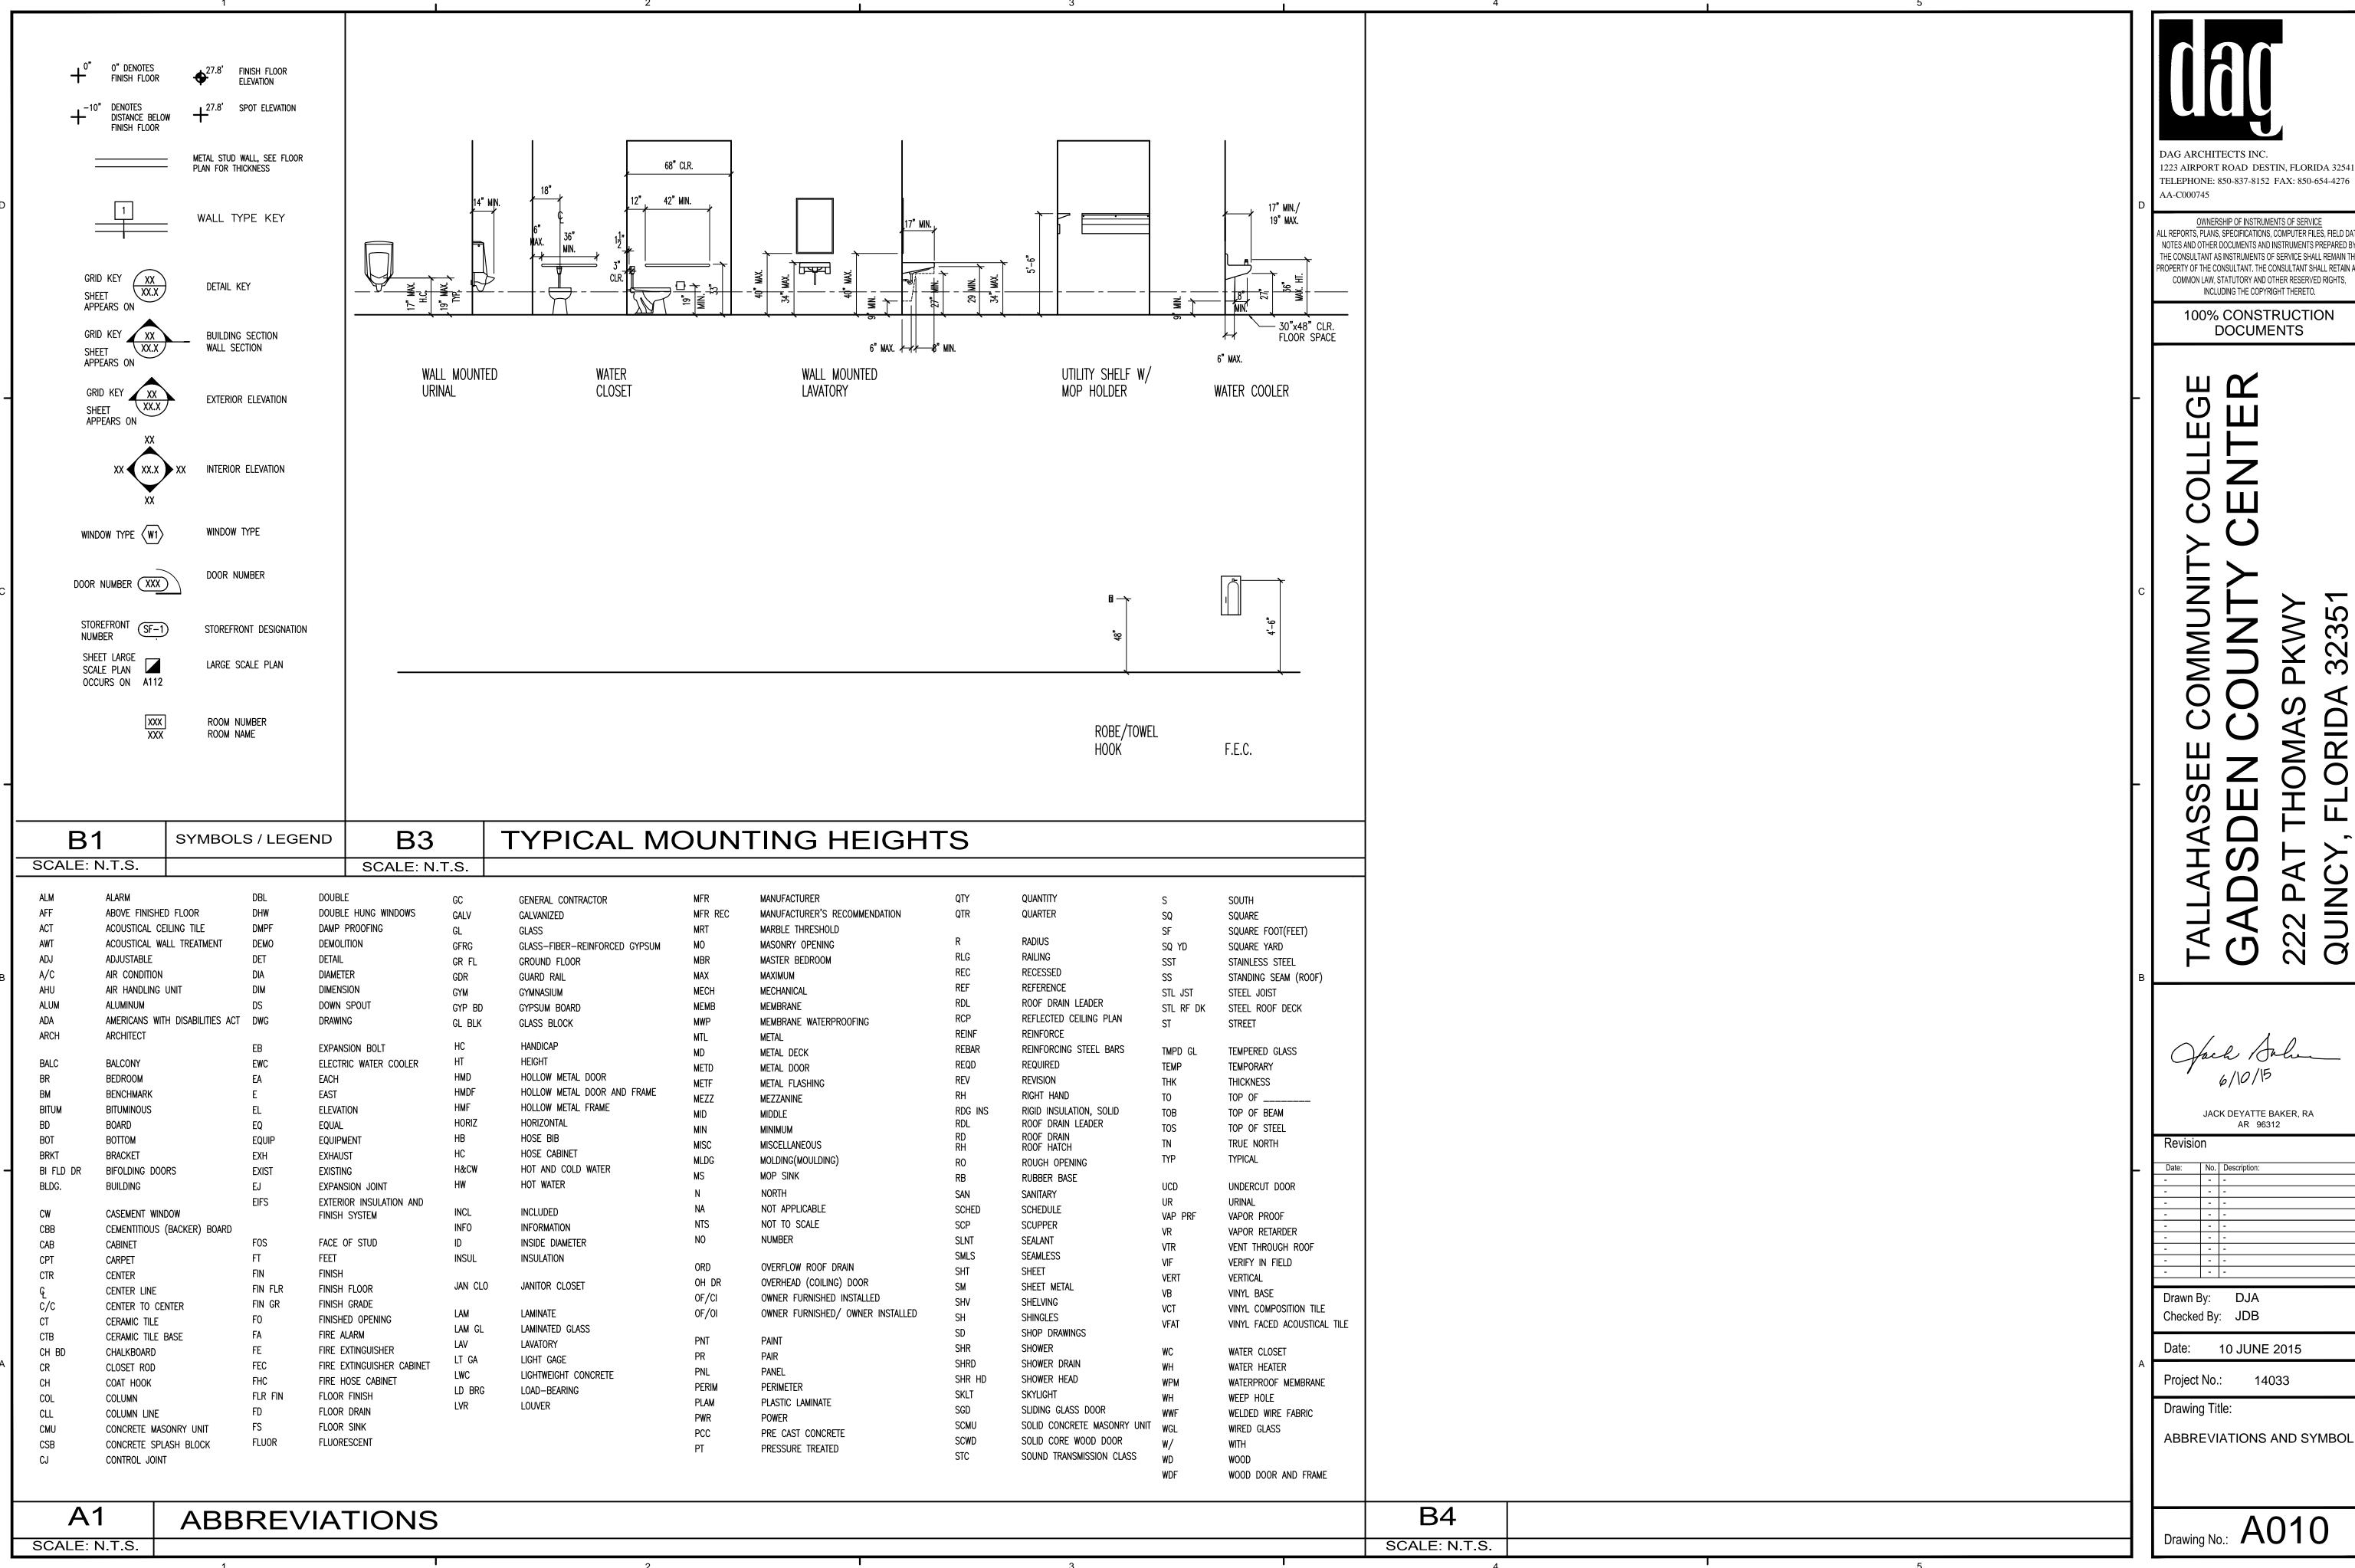



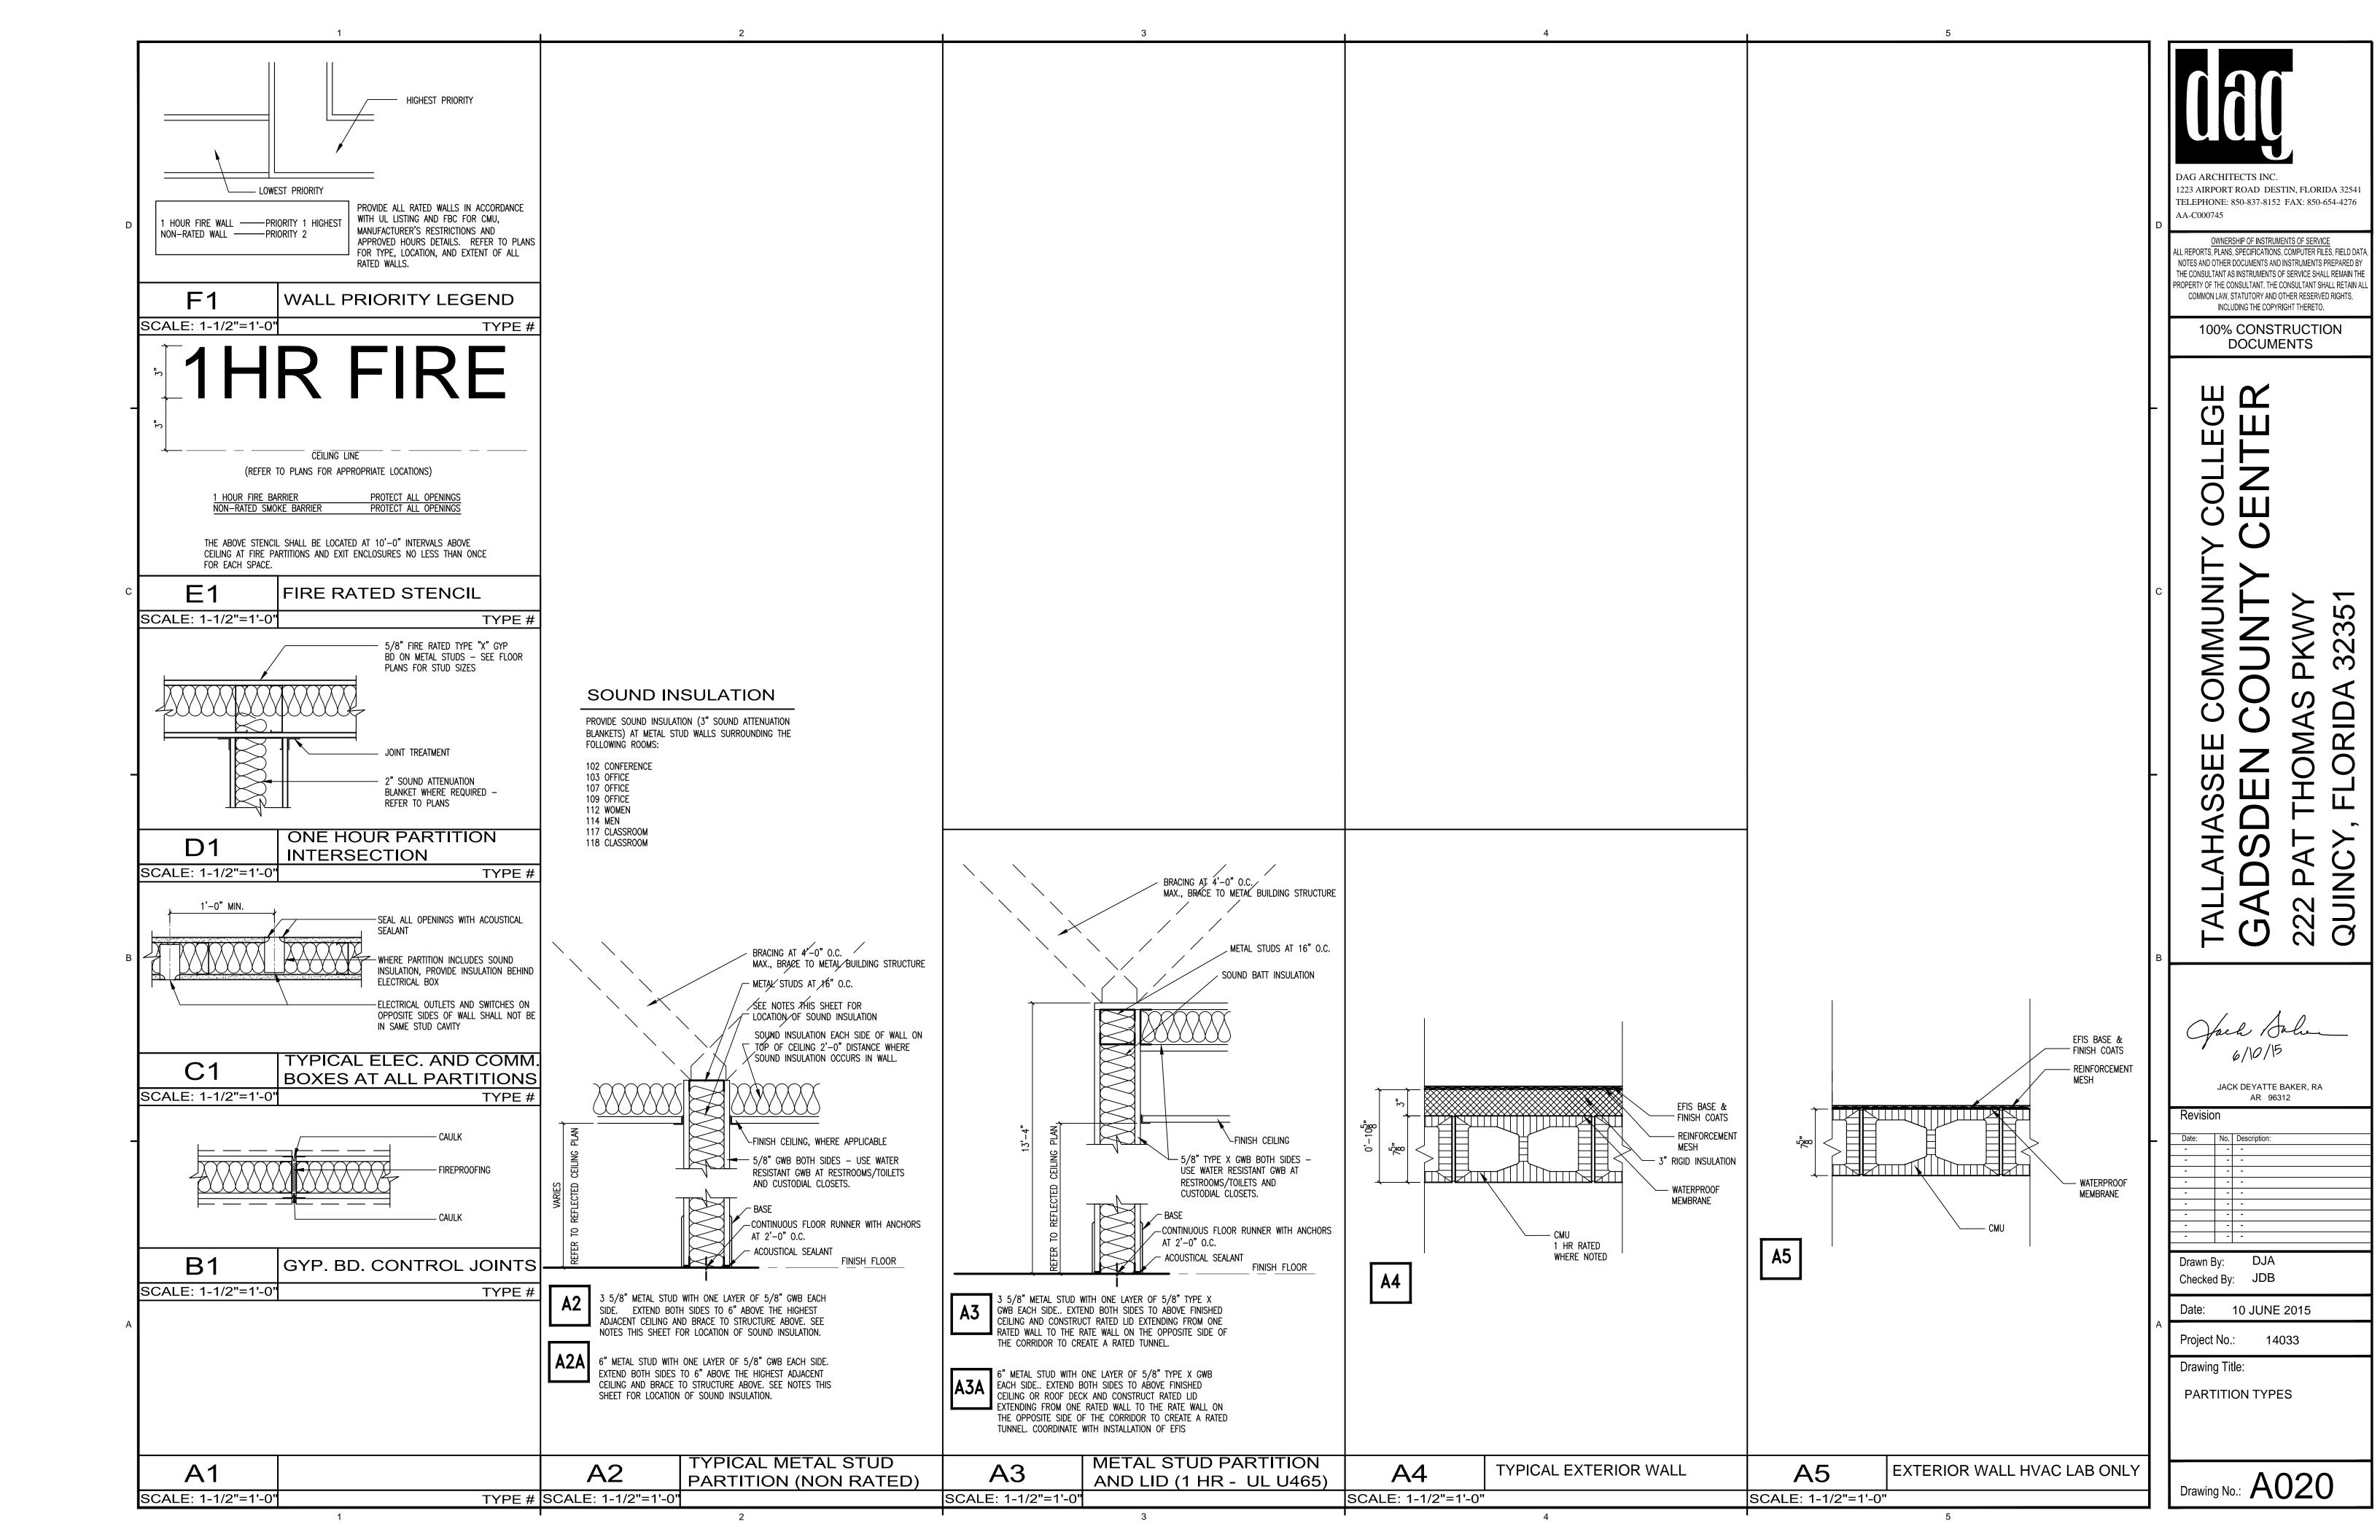

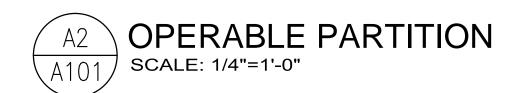

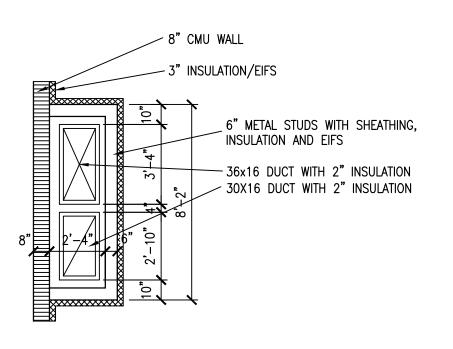



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Jack Salue 6/10/15

JACK DEYATTE BAKER, RA

AR 96312 Revision

Drawn By: DJA Checked By: JDB


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Project No.: 14033


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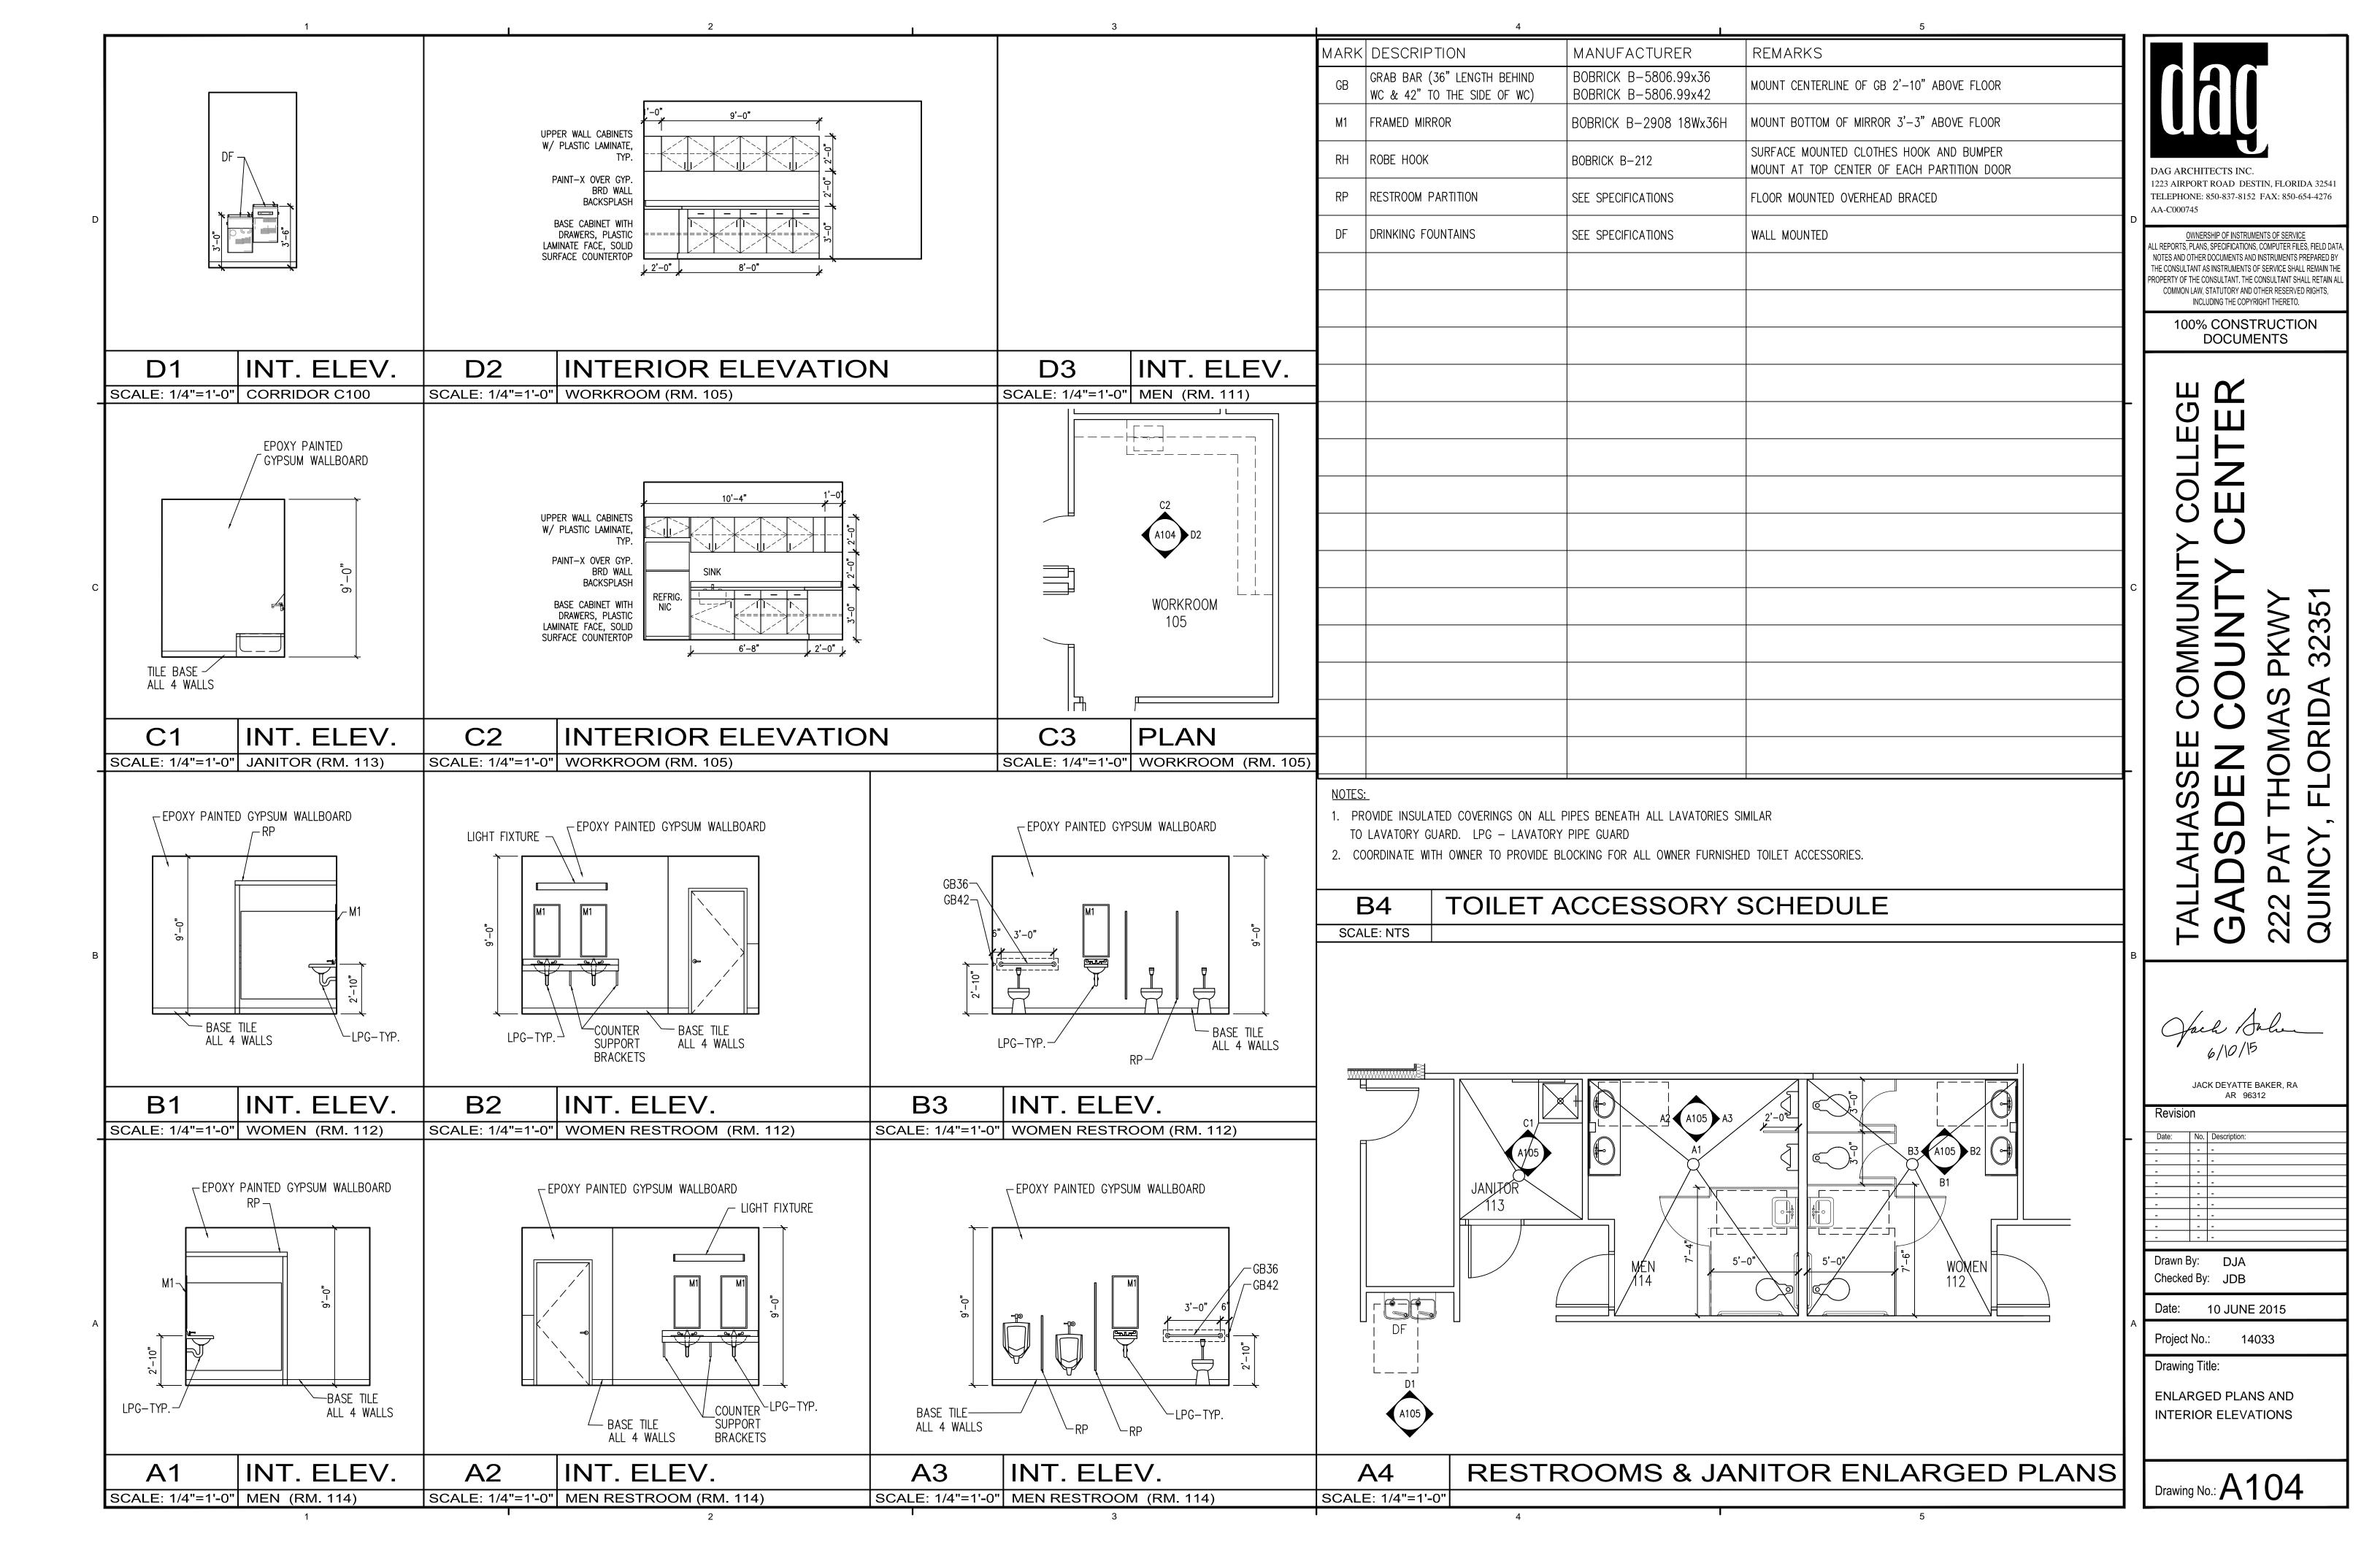
FLOOR PLAN


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EIFS COLORS

- E1 EIFS COLOR PAREX CLAY 1571L(66)
- E2 EIFS COLOR PAREX BUFFALO 1568L(66)
- E3 EIFS COLOR PAREX MOONDANCE 3027L(66)

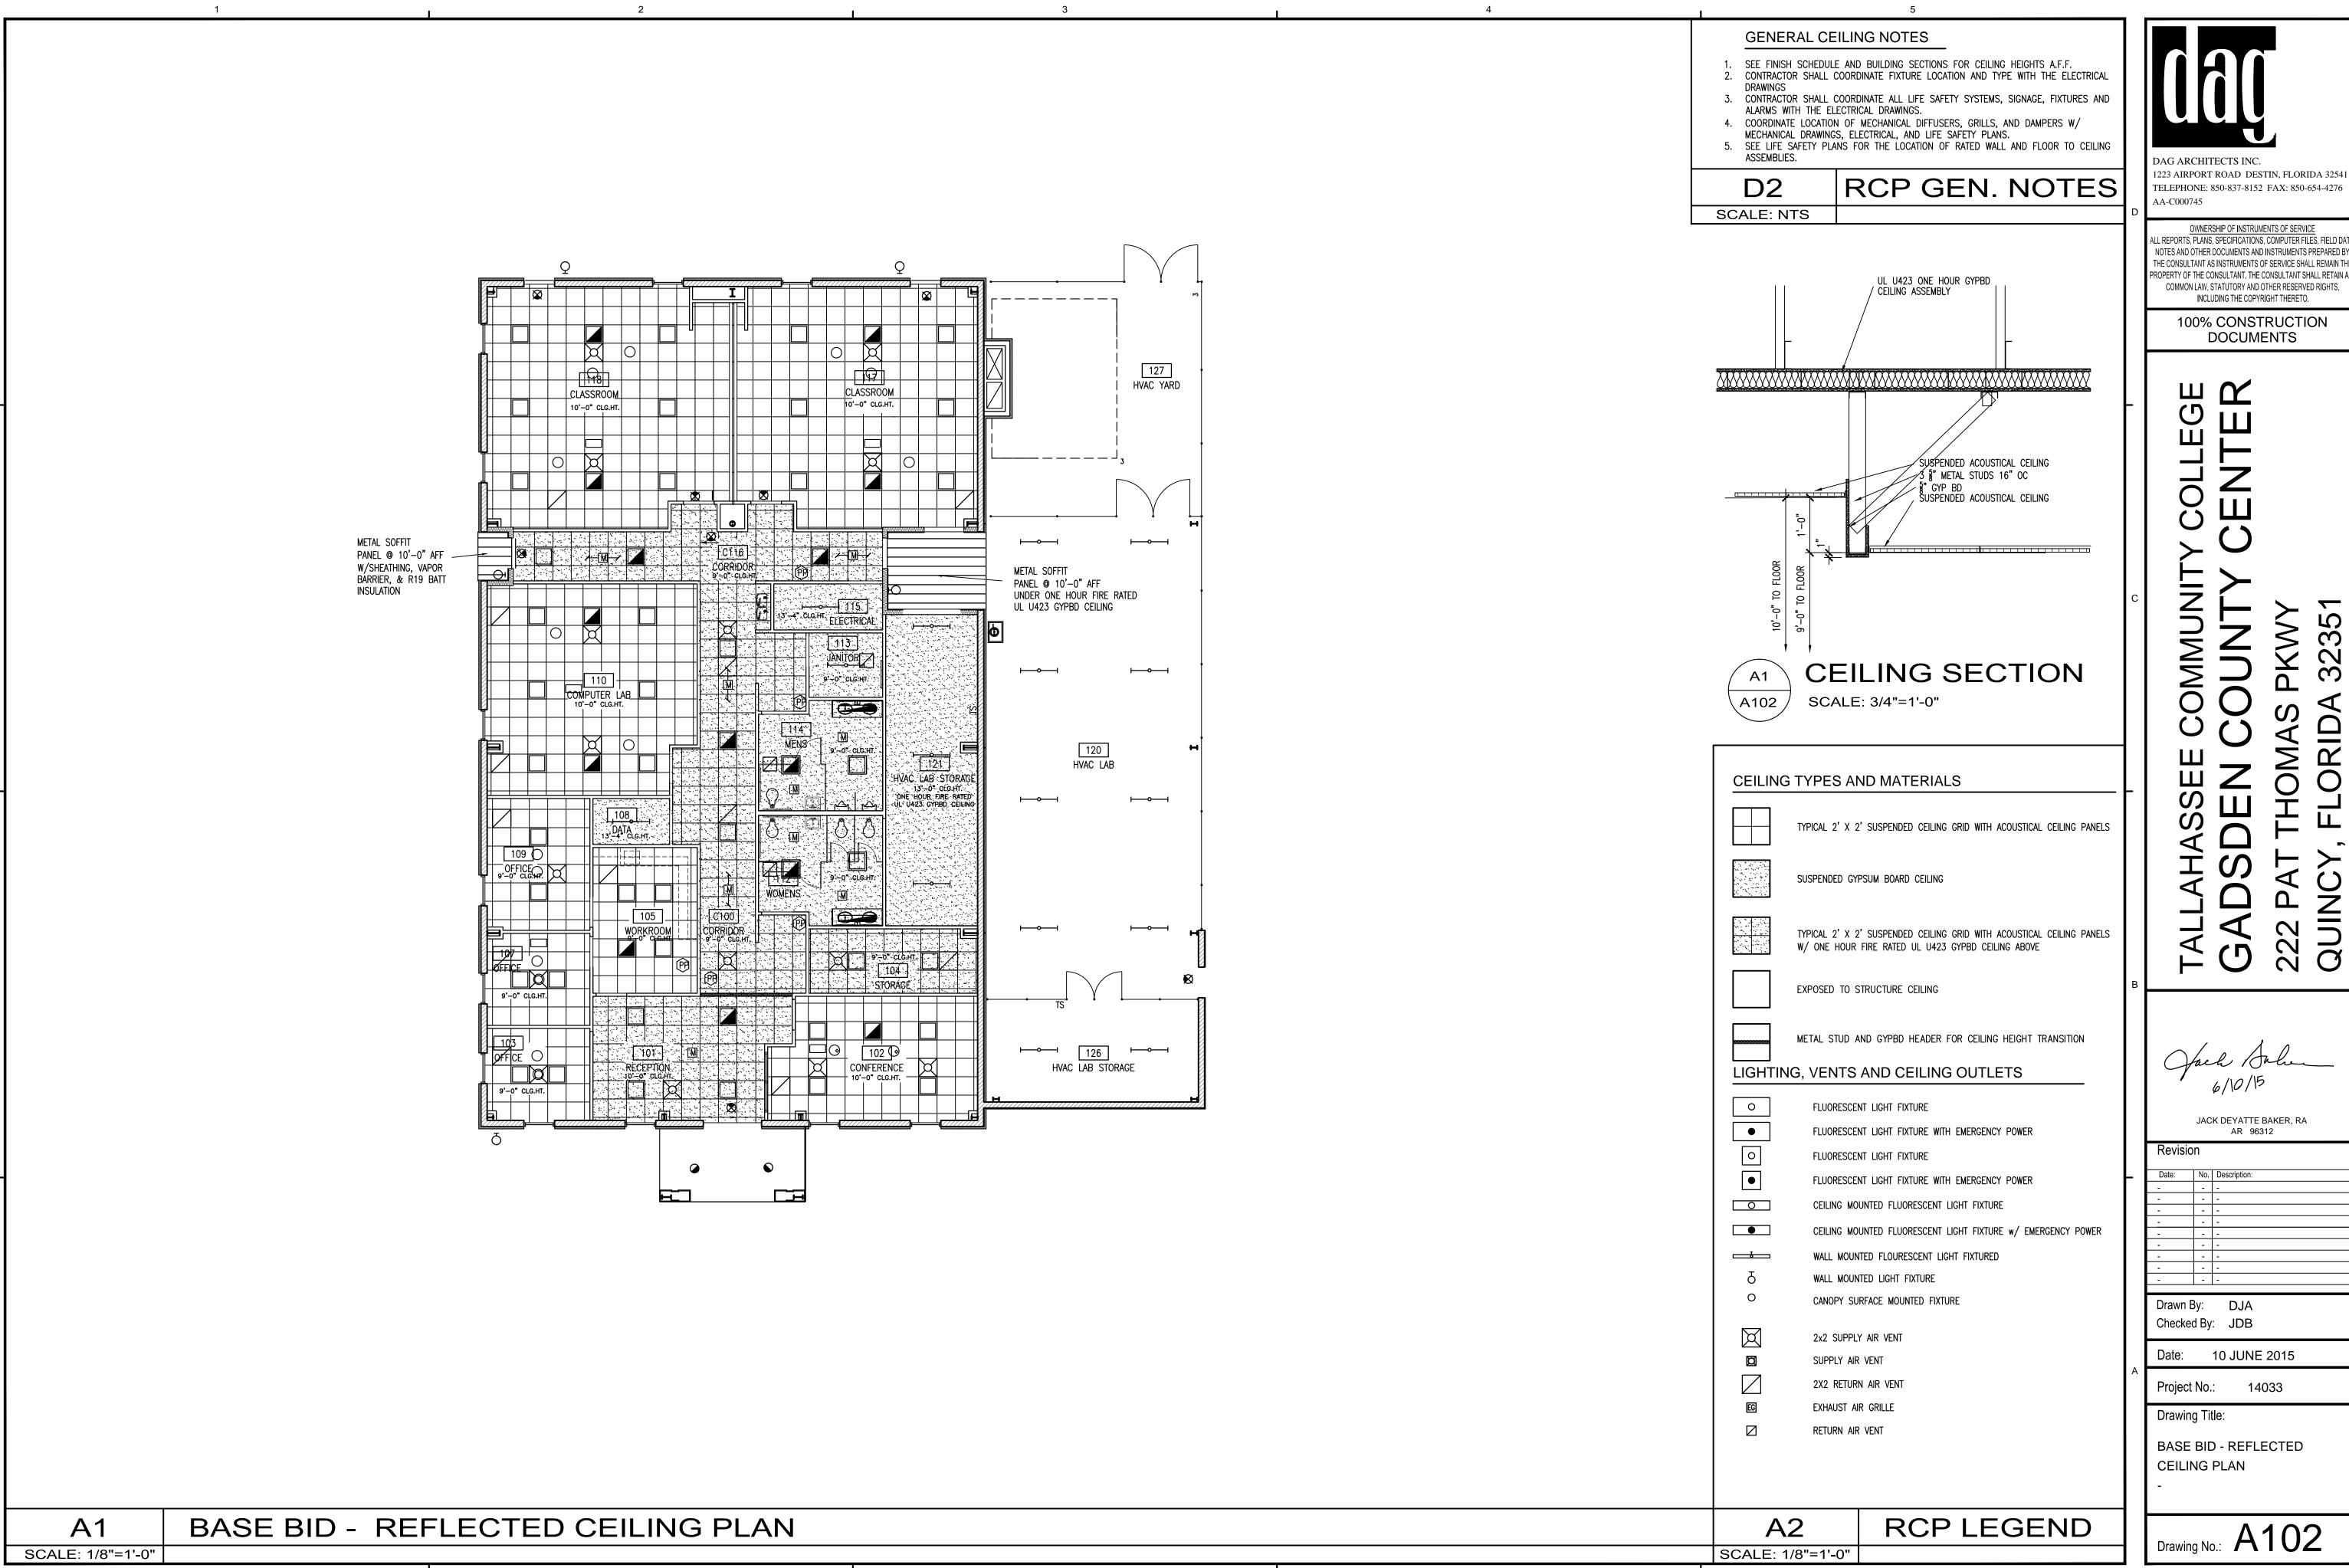

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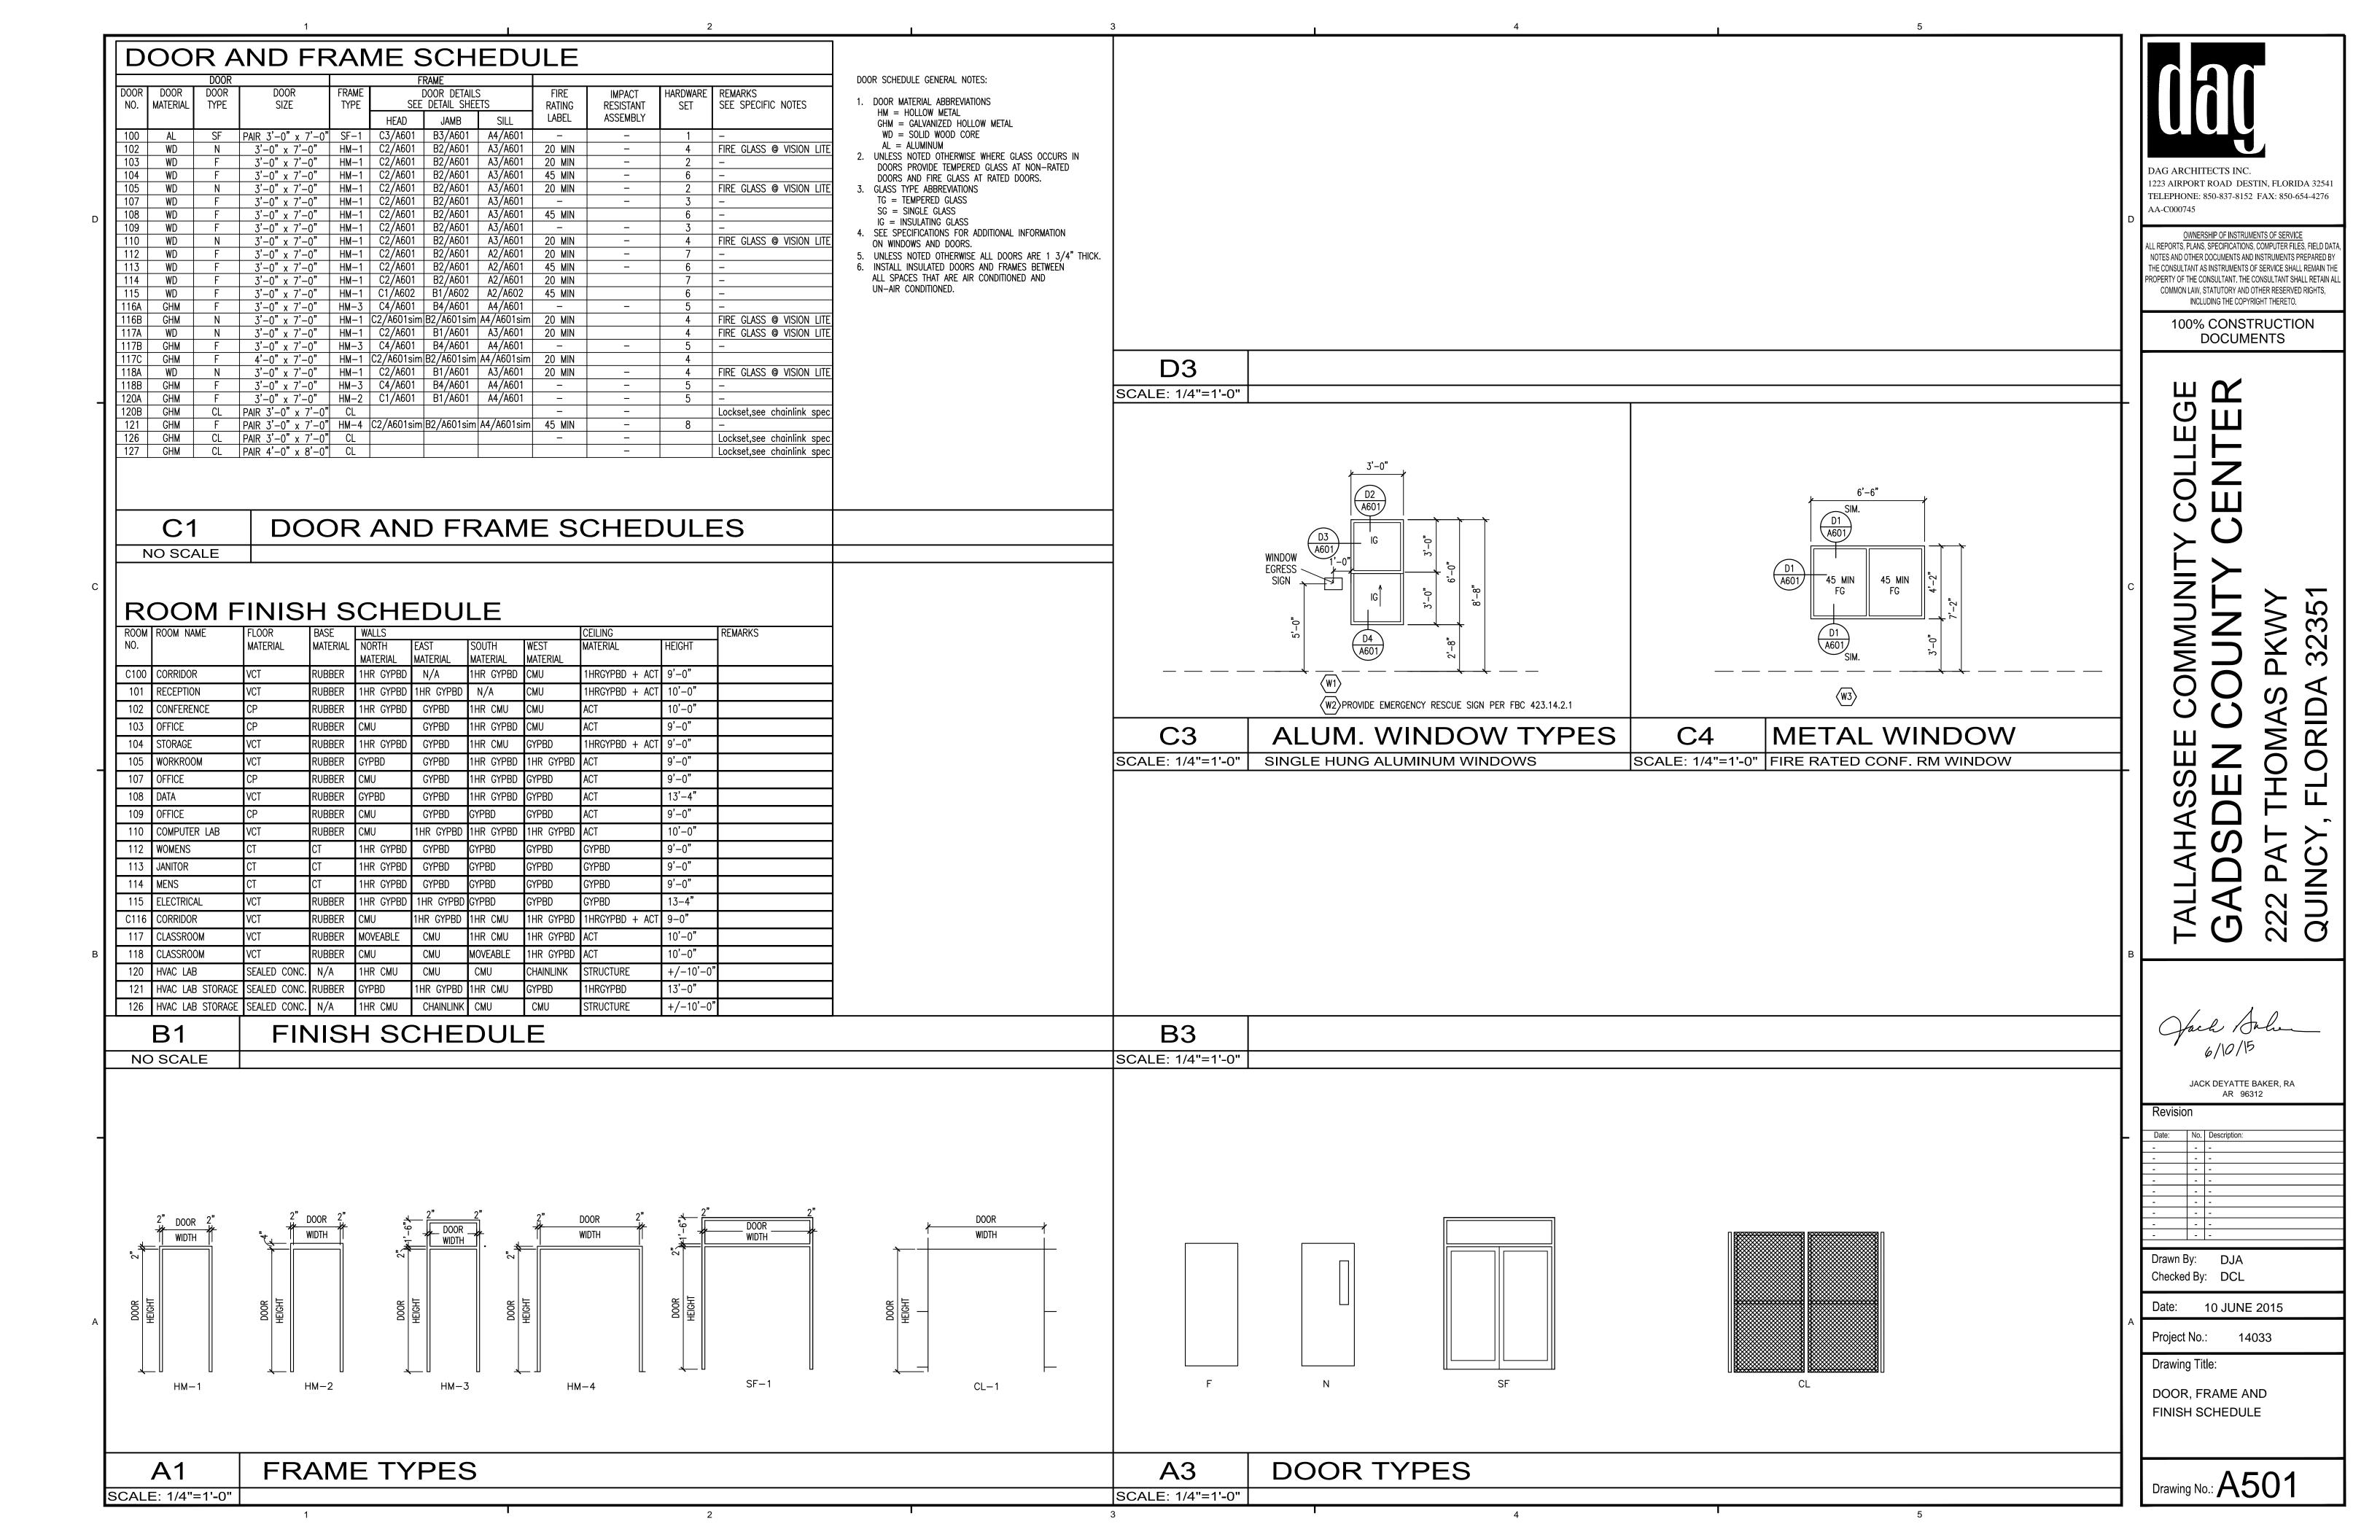
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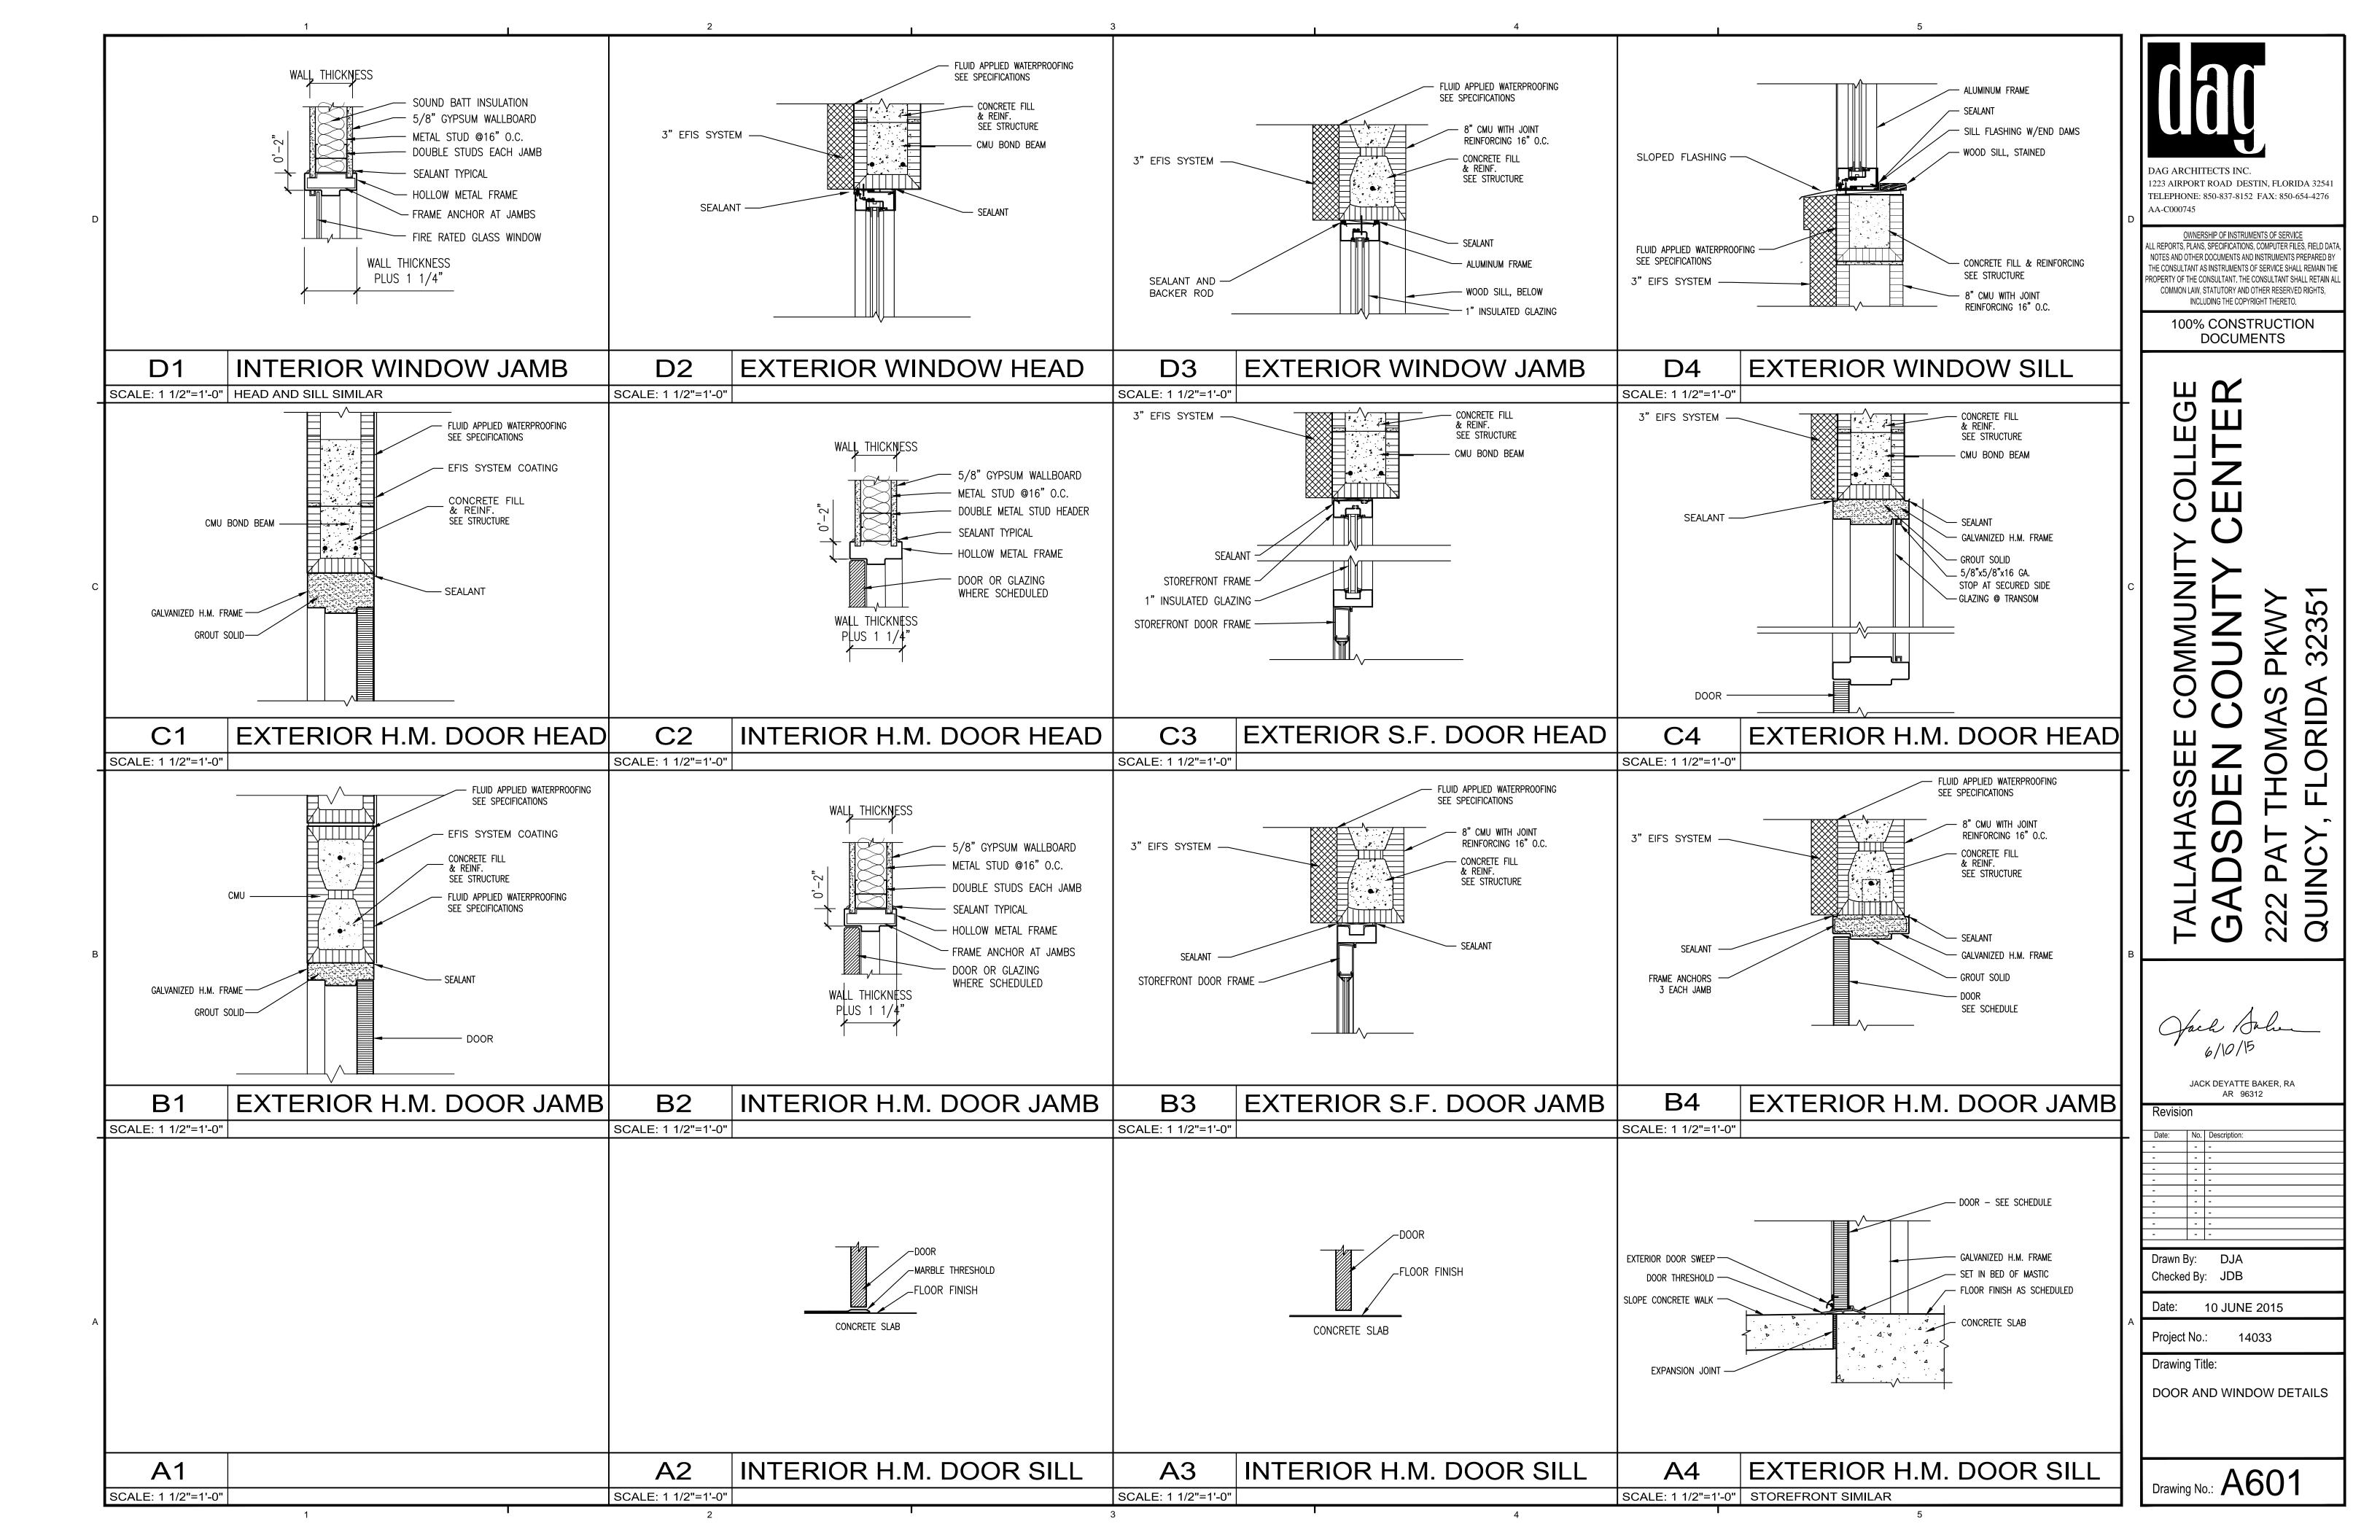
Project No.: 14033
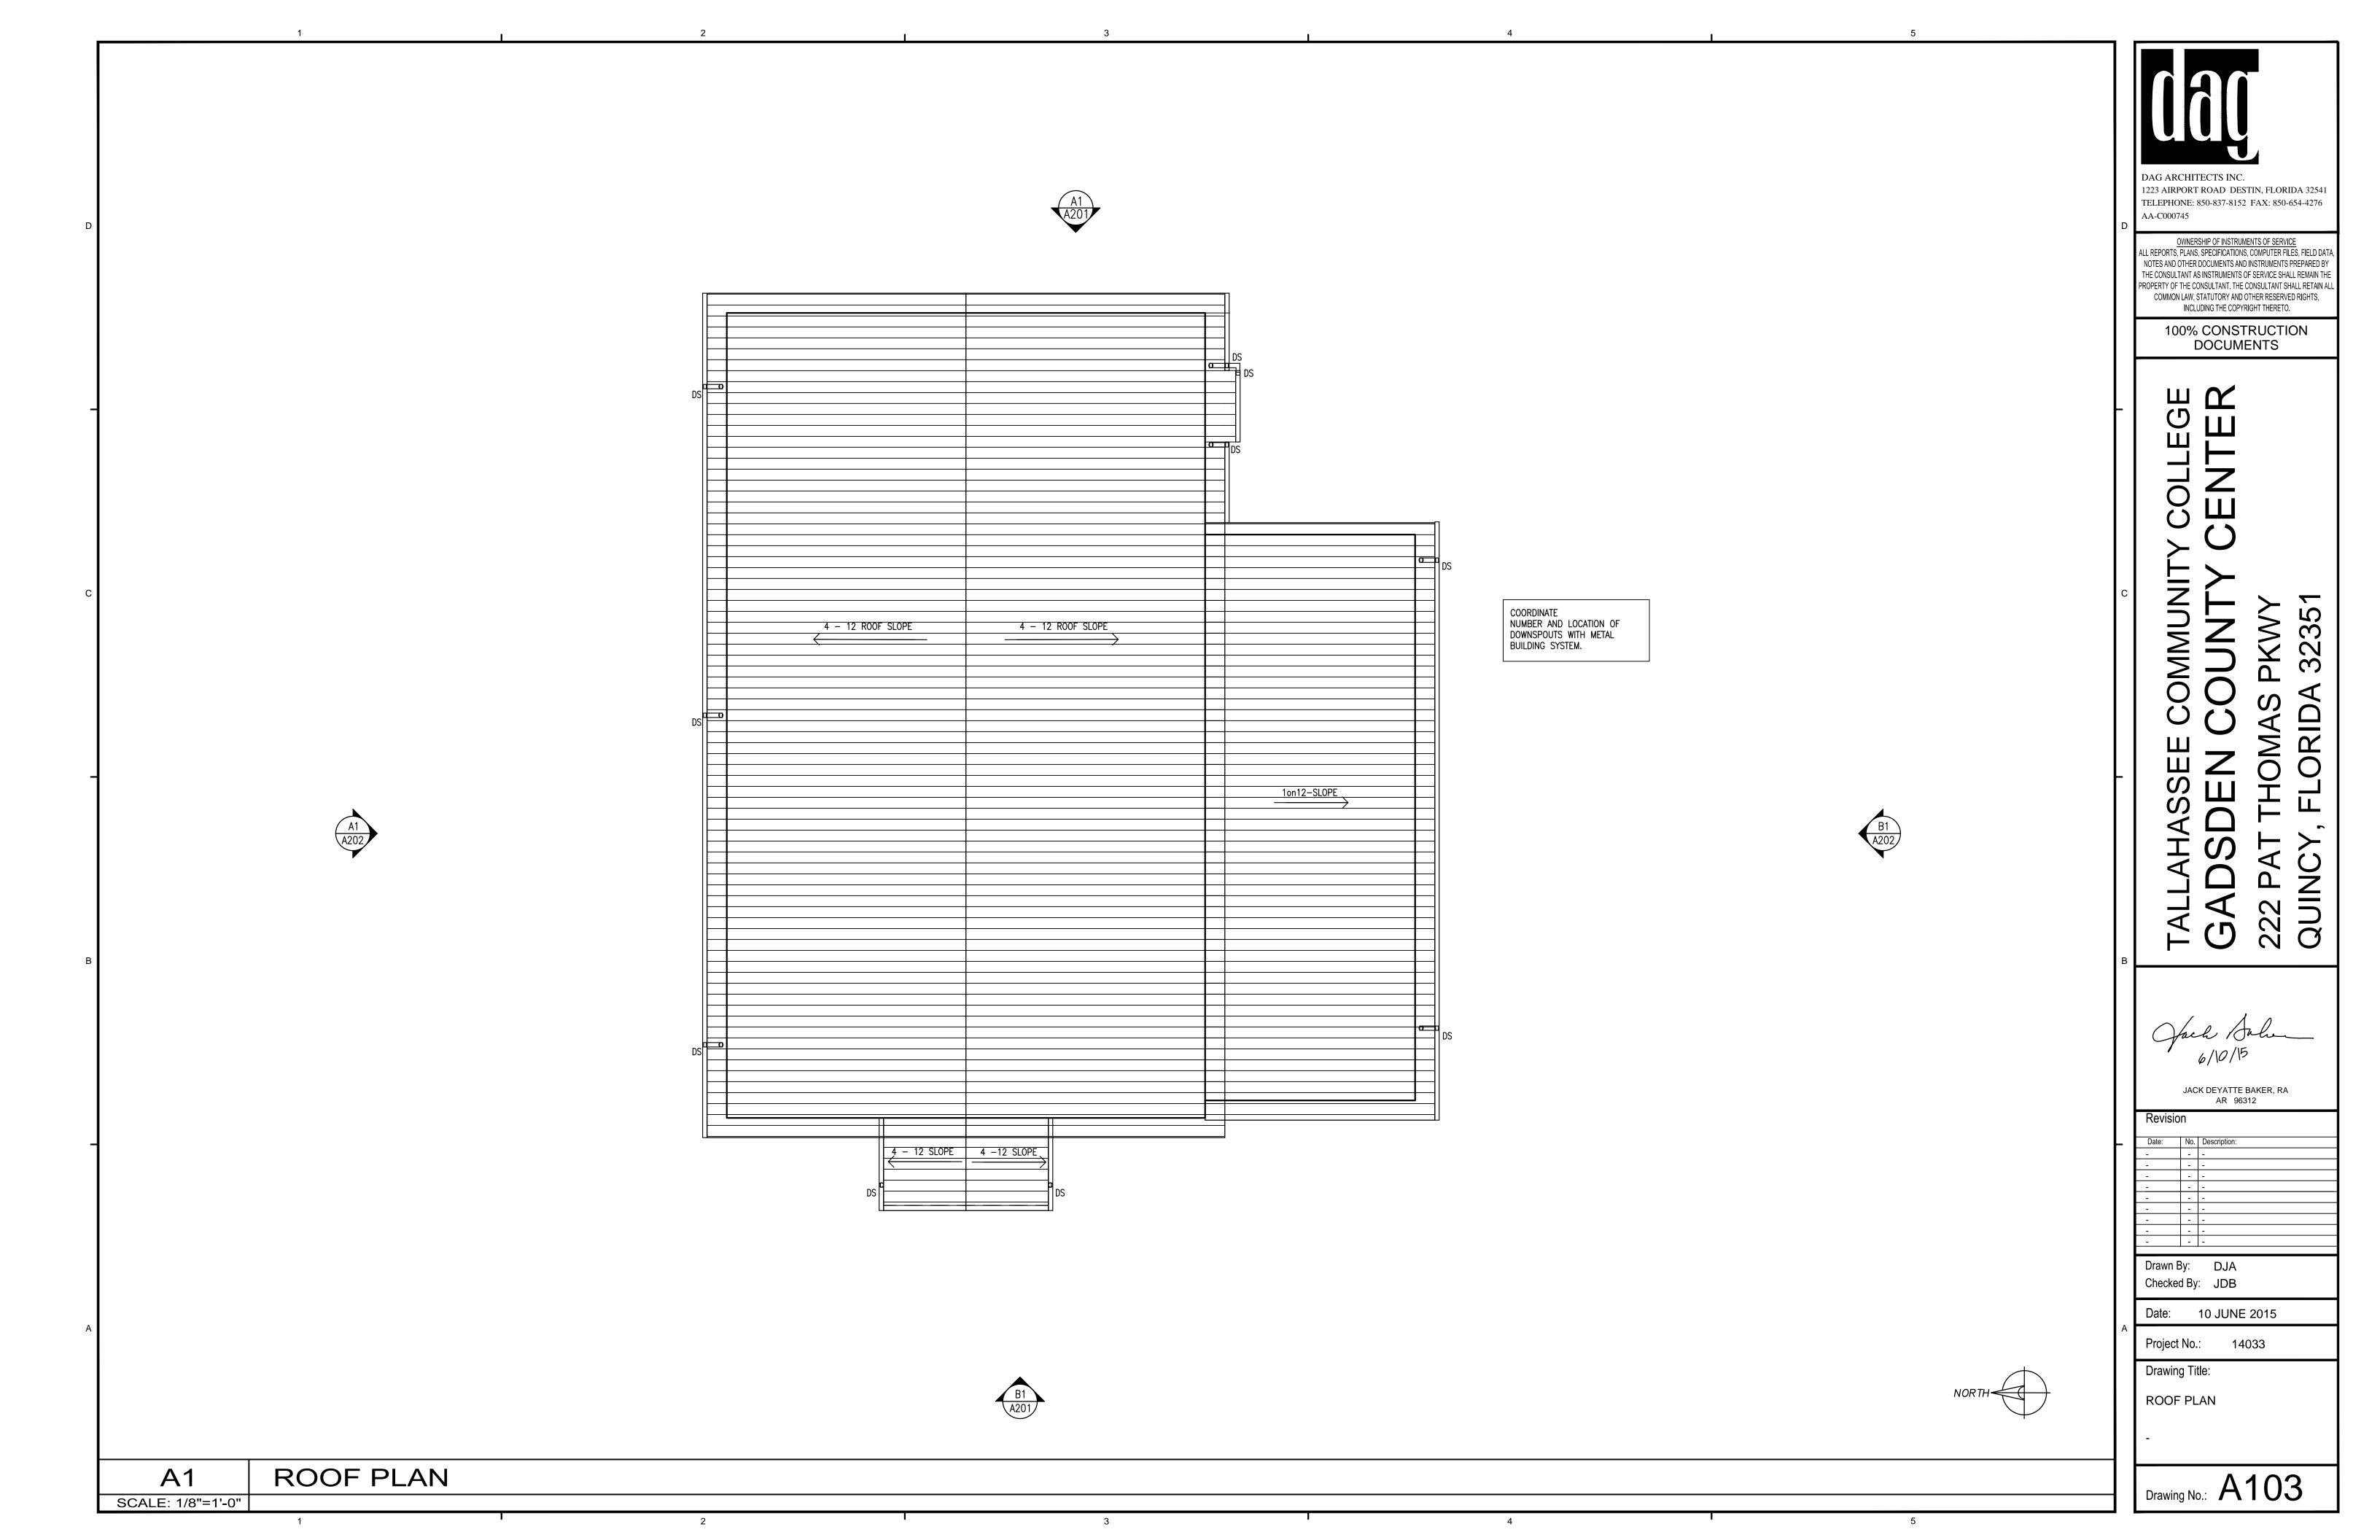
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EXTERIOR ELEVATIONS

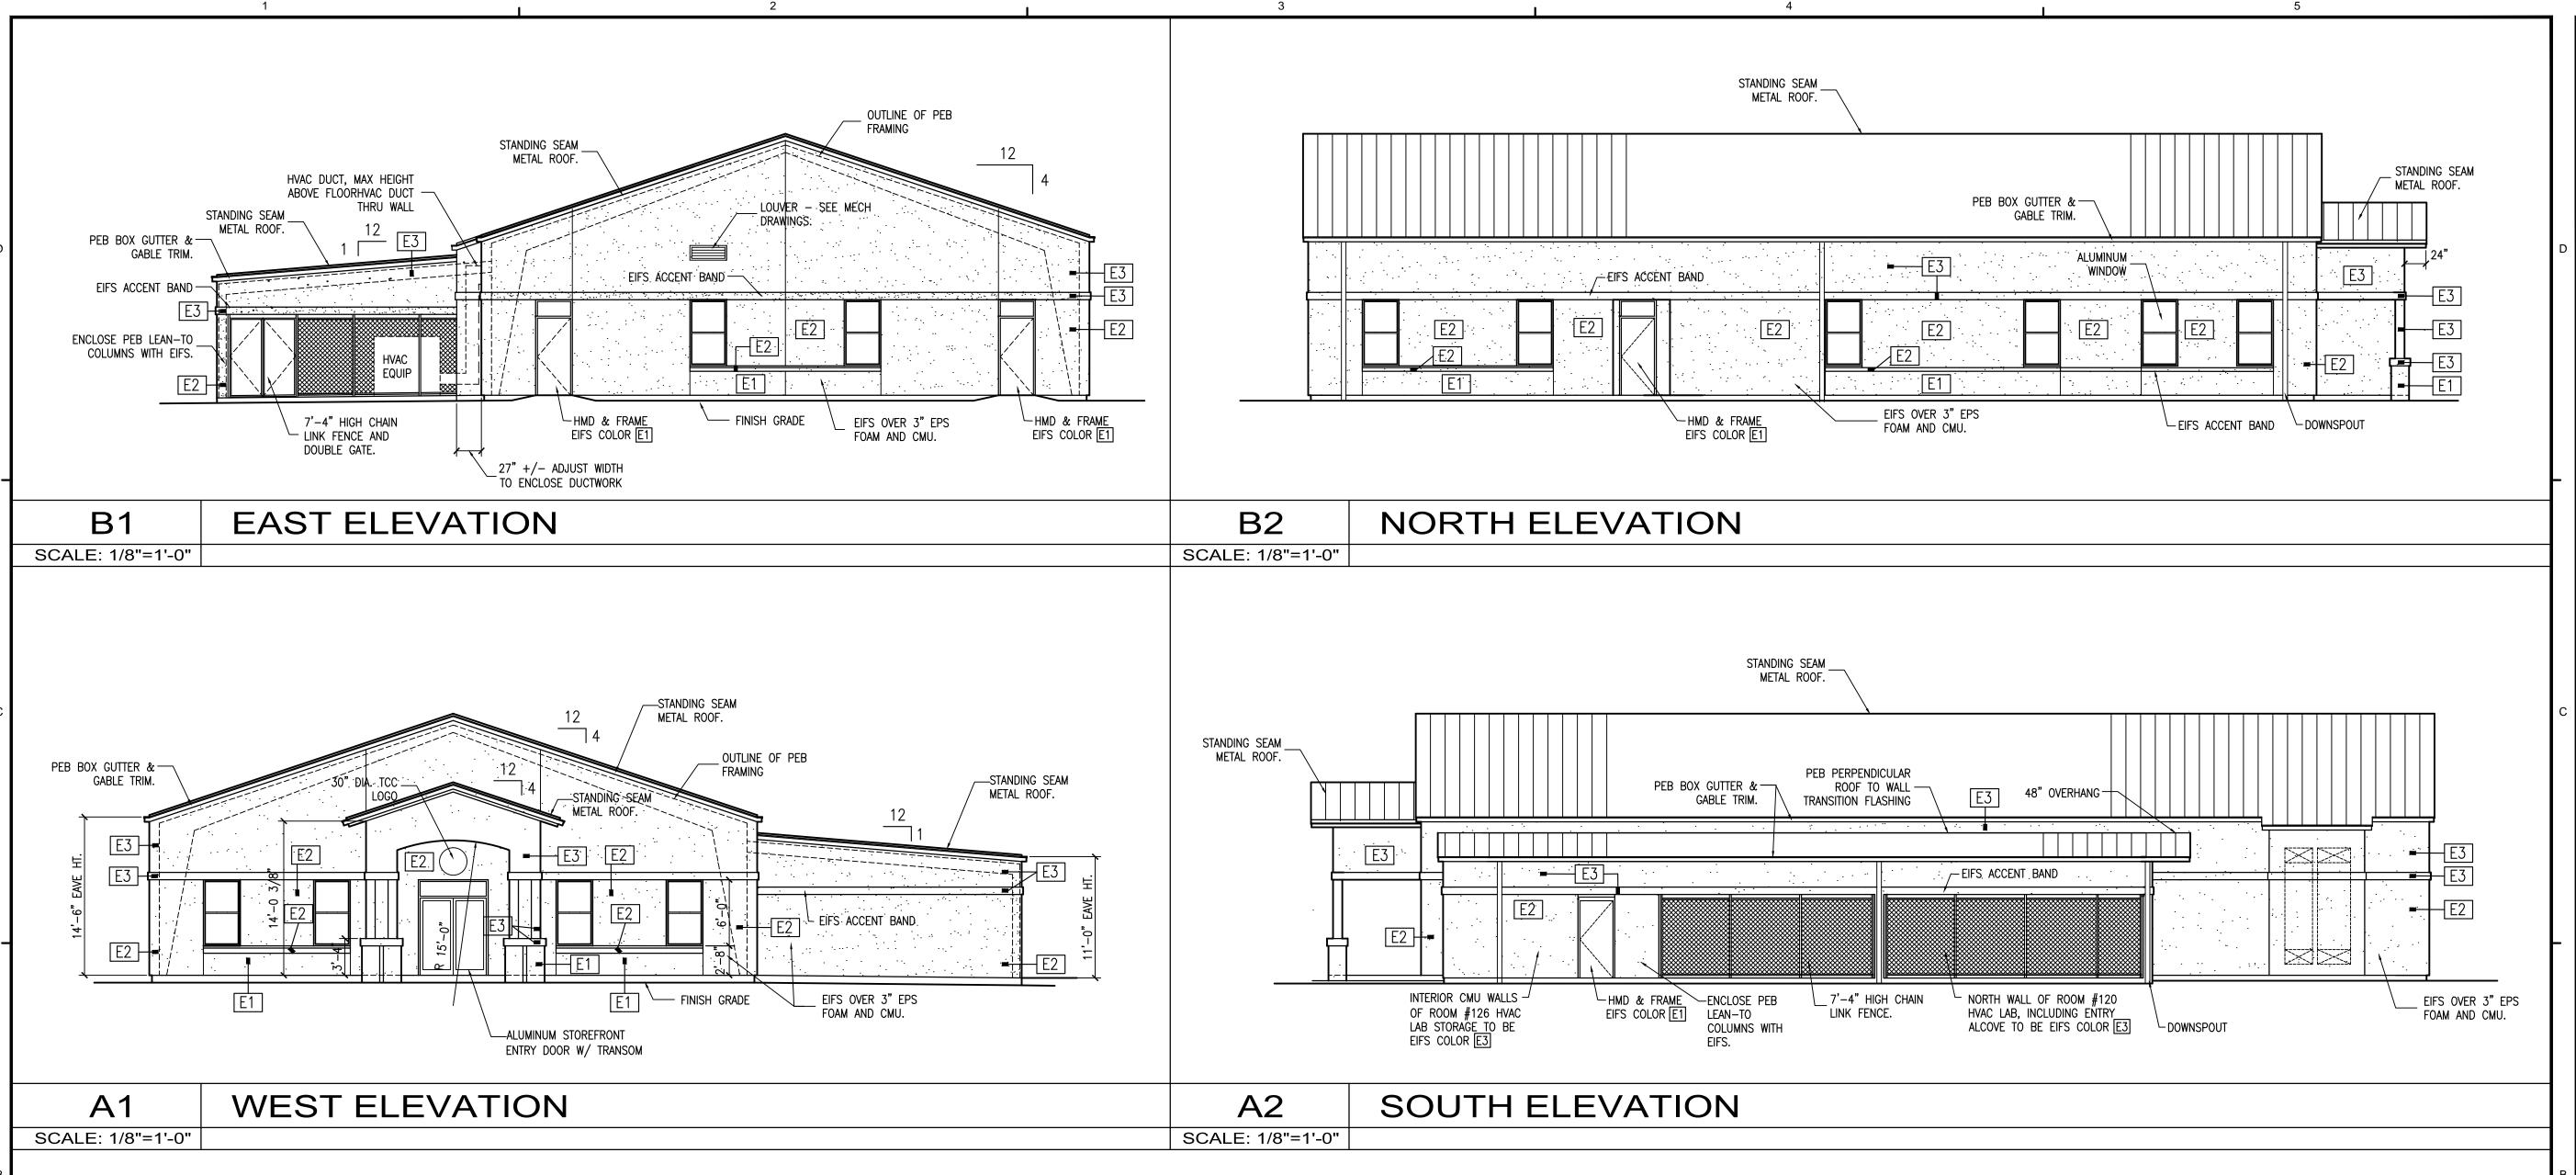Drawing No.: A201







CONSTRUCTION.

PRODUCT DATA AND SAMPLES".

ERROR OR OMISSION ON HIS PART.

- DRAWINGS ARE DIAGRAMMATIC, INDICATIVE OF WORK TO BE FURNISHED AND INSTALLED UNDER THIS CONTRACT. REFER TO ARCHITECTURAL AND STRUCTURAL DRAWINGS FOR DIMENSIONS.
- FIELD VERIFY DIMENSIONS AND CONDITIONS. IF THE CONTRACTOR IS UNABLE TO INTERPRET THE CONTRACT DOCUMENTS, HE IS RESPONSIBLE TO REQUEST CLARIFICATION IN WRITING TO THE ARCHITECT. IF HE PROCEEDS WITH ANY WORK BEFORE OBTAINING CLARIFICATION, HE SHALL BE
- HELD RESPONSIBLE FOR DEFICIENCIES ASSOCIATED THEREWITH. BEFORE SUBMITTING FOR THE WORK, EACH BIDDER WILL BE RESPONSIBLE TO EXAMINE THE PREMISES AND SATISFY HIMSELF AS TO THE EXISTING CONDITIONS UNDER WHICH HE WILL BE OBLIGATED TO OPERATE AND COMPLETE THE WORK UNDER THIS CONTRACT. NO ALLOWANCE
- THE CONTRACTOR SHALL PAY FOR INSPECTION PERMITS, CERTIFICATES, CONNECTION FEES, SYSTEM DEMAND CHARGES AND LICENSE FEES IN CONNECTION WITH HIS WORK.

WILL SUBSEQUENTLY BE MADE IN THIS CONNECTION ON BEHALF OF THE CONTRACTOR FOR ANY


- CONSTRUCTION MANAGER SHALL BE RESPONSIBLE FOR COORDINATING WORK OF SUBCONTRACTORS TO AVOID INTERFERENCES.
- WORK SHALL COMPLY WITH APPLICABLE O.S.H.A. AND E.P.A. REGULATIONS AND GUIDELINES.
- ERECT AND MAINTAIN REASONABLE PRECAUTIONS FOR SAFETY AND HEALTH INCLUDING POSTING DANGER SIGNS AND OTHER WARNINGS AGAINST HAZARDS INCLUDING PROMULGATING SAFETY REGULATIONS. PROVIDE SAFETY PRECAUTIONS AND BARRICADES FOR PEDESTRIANS AT CONSTRUCTION VEHICLE ACCESS AND EGRESS LOCATIONS.
- COORDINATE AND SEQUENCE CLEANING AND CONSTRUCTION WORK. SUBMIT A COMPLETELY DETAILED CONSTRUCTION SCHEDULE PRIOR TO PRE-CONSTRUCTION CONFERENCE.
- THE CONTRACTOR SHALL STRICTLY BE HELD TO THE PROJECT SCHEDULE. HE SHALL PROVIDE SUFFICIENT MANPOWER AND EQUIPMENT TO FULLY MOBILIZE, PROCEED WITH AND COMPLETE THE
- THE CONTRACTOR SHALL BE RESTRICTED TO AREAS SPECIFIED BY THE OWNER FOR ON-SITE STORAGE OF CONSTRUCTION MATERIALS. THE CONTRACTOR IS RESPONSIBLE FOR THE
- PROTECTION AND SECURITY OF EQUIPMENT AND MATERIALS. THE CONTRACTOR SHALL MAINTAIN A CLEAN WORK ENVIRONMENT AT ALL TIMES AND SHALL
- CLEAN CONSTRUCTION SITE OF DEBRIS AT COMPLETION OF THE JOB AND BEFORE FINAL

12. THE CONTRACTOR SHALL FURNISH "AS-BUILT" DRAWINGS TO THE ARCHITECT AT COMPLETION OF

- CONTRACTOR'S USE OF AN APPROVAL STAMP ON DOCUMENTS SUBMITTED AS SHOP DRAWINGS, PRODUCT DATA, SAMPLES AND SIMILAR SUBMITTALS CERTIFIES THAT THE CONTRACTOR HAS COMPLIED WITH THE CONTRACT DOCUMENT REQUIREMENTS RELATED TO "SHOP DRAWINGS,
- THE CONTRACTOR SHALL NOT BE RELIEVED OF RESPONSIBILITY FOR DEVIATIONS FROM REQUIREMENTS OF THE CONTRACT DOCUMENTS BY THE ARCHITECT/ ENGINEER'S APPROVAL OF SHOP DRAWINGS, PRODUCT DATA, SAMPLES OR SIMILAR SUBMITTALS UNLESS THE CONTRACTOR HAS SPECIFICALLY INFORMED THE ARCHITECT/ENGINEER IN WRITING OF SUCH DEVIATION AT THE TIME OF SUBMITTAL AND THE ARCHITECT/ENGINEER HAS GIVEN WRITTEN APPROVAL TO THE SPECIFIC DEVIATION. THE CONTRACTOR SHALL NOT BE RELIEVED OF RESPONSIBILITY FOR ERRORS OR OMISSIONS IN SHOP DRAWINGS, PRODUCT DATA, SAMPLES OR SIMILAR SUBMITTALS BY THE ARCHITECT/ENGINEER'S APPROVAL THEREOF.
- PRIOR TO INSTALLATION, COORDINATE AND ADJUST THE FINAL LOCATION OF WALL MOUNTED DEVICES AND EQUIPMENT WITH ALL CASEWORK, SHELVING, MARKERBOARDS, BULLETIN BOARDS OR OTHER WALL MOUNTED FURNISHINGS.
- NOTE ANY SPECIAL REQUIREMENTS INVOLVED IN INSTALLING THE EQUIPMENT IN THE BUILDING. DISMANTLING AND REASSEMBLING OF ANY EQUIPMENT SHALL BE DONE AS REQUIRED FOR ENTRY INTO THE BUILDING AND EQUIPMENT ROOMS.
- 17. PROTECT THE ROOF FROM DAMAGE WHENEVER ANY WORK ON THE ROOF IS REQUIRED.
- 18. SUPPORTS AND HANGERS SHALL PRESENT A NEAT, ORDERLY APPEARANCE.
- ROOF MOUNTED EQUIPMENT SHALL BE SECURED TO STRUCTURE TO RESIST A 130 MPH WIND
- 20. CONTRACTOR SHALL MAINTAIN THE INTEGRITY OF ALL FIRE, SMOKE, AND ACOUSTICAL WALL
- BEAM AND FLOOR PENETRATIONS SHALL BE APPROVED BY THE STRUCTURAL ENGINEER. BEAM SLEEVES AND BEAM REINFORCING APPROVED BY STRUCTURAL ENGINEER SHALL BE FURNISHED AND INSTALLED BY THIS CONTRACTOR
- 22. CONTRACTOR SHALL FURNISH U.L. APPROVED DRAWINGS FOR EACH TYPE OF FIRE RATED ASSEMBLY PENETRATION BY DUCTS, PIPES OR CONDUITS. THESE DRAWINGS SHALL BE DISPLAYED ON THE JOB SITE AT ALL TIMES DURING CONSTRUCTION. SEE SPECIFICATIONS.
- CONTRACTOR SHALL GUARANTEE THE WORK AND MATERIALS FOR A PERIOD OF ONE YEAR FROM DATE OF FINAL ACCEPTANCE. THIS GUARANTEE SHALL BE IN ADDITION TO THE WARRANTIES PROVIDED BY MATERIAL SUPPLIERS AND MANUFACTURERS.

DRAWING INDEX

- GENERAL NOTES, LEGENDS AND SCHEDULES HVAC
- SCHEDULES HVAC FLOOR PLAN - HVAC
- DETAILS HVAC

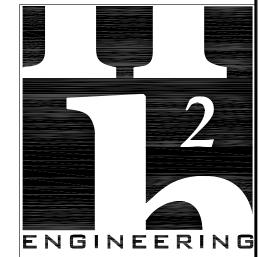

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10 JUNE 2015 Date:

Project No. 14033

Drawing Title:

GENERAL NOTES, LEGENDS AND

LEGENDS NO

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SCHEDULES

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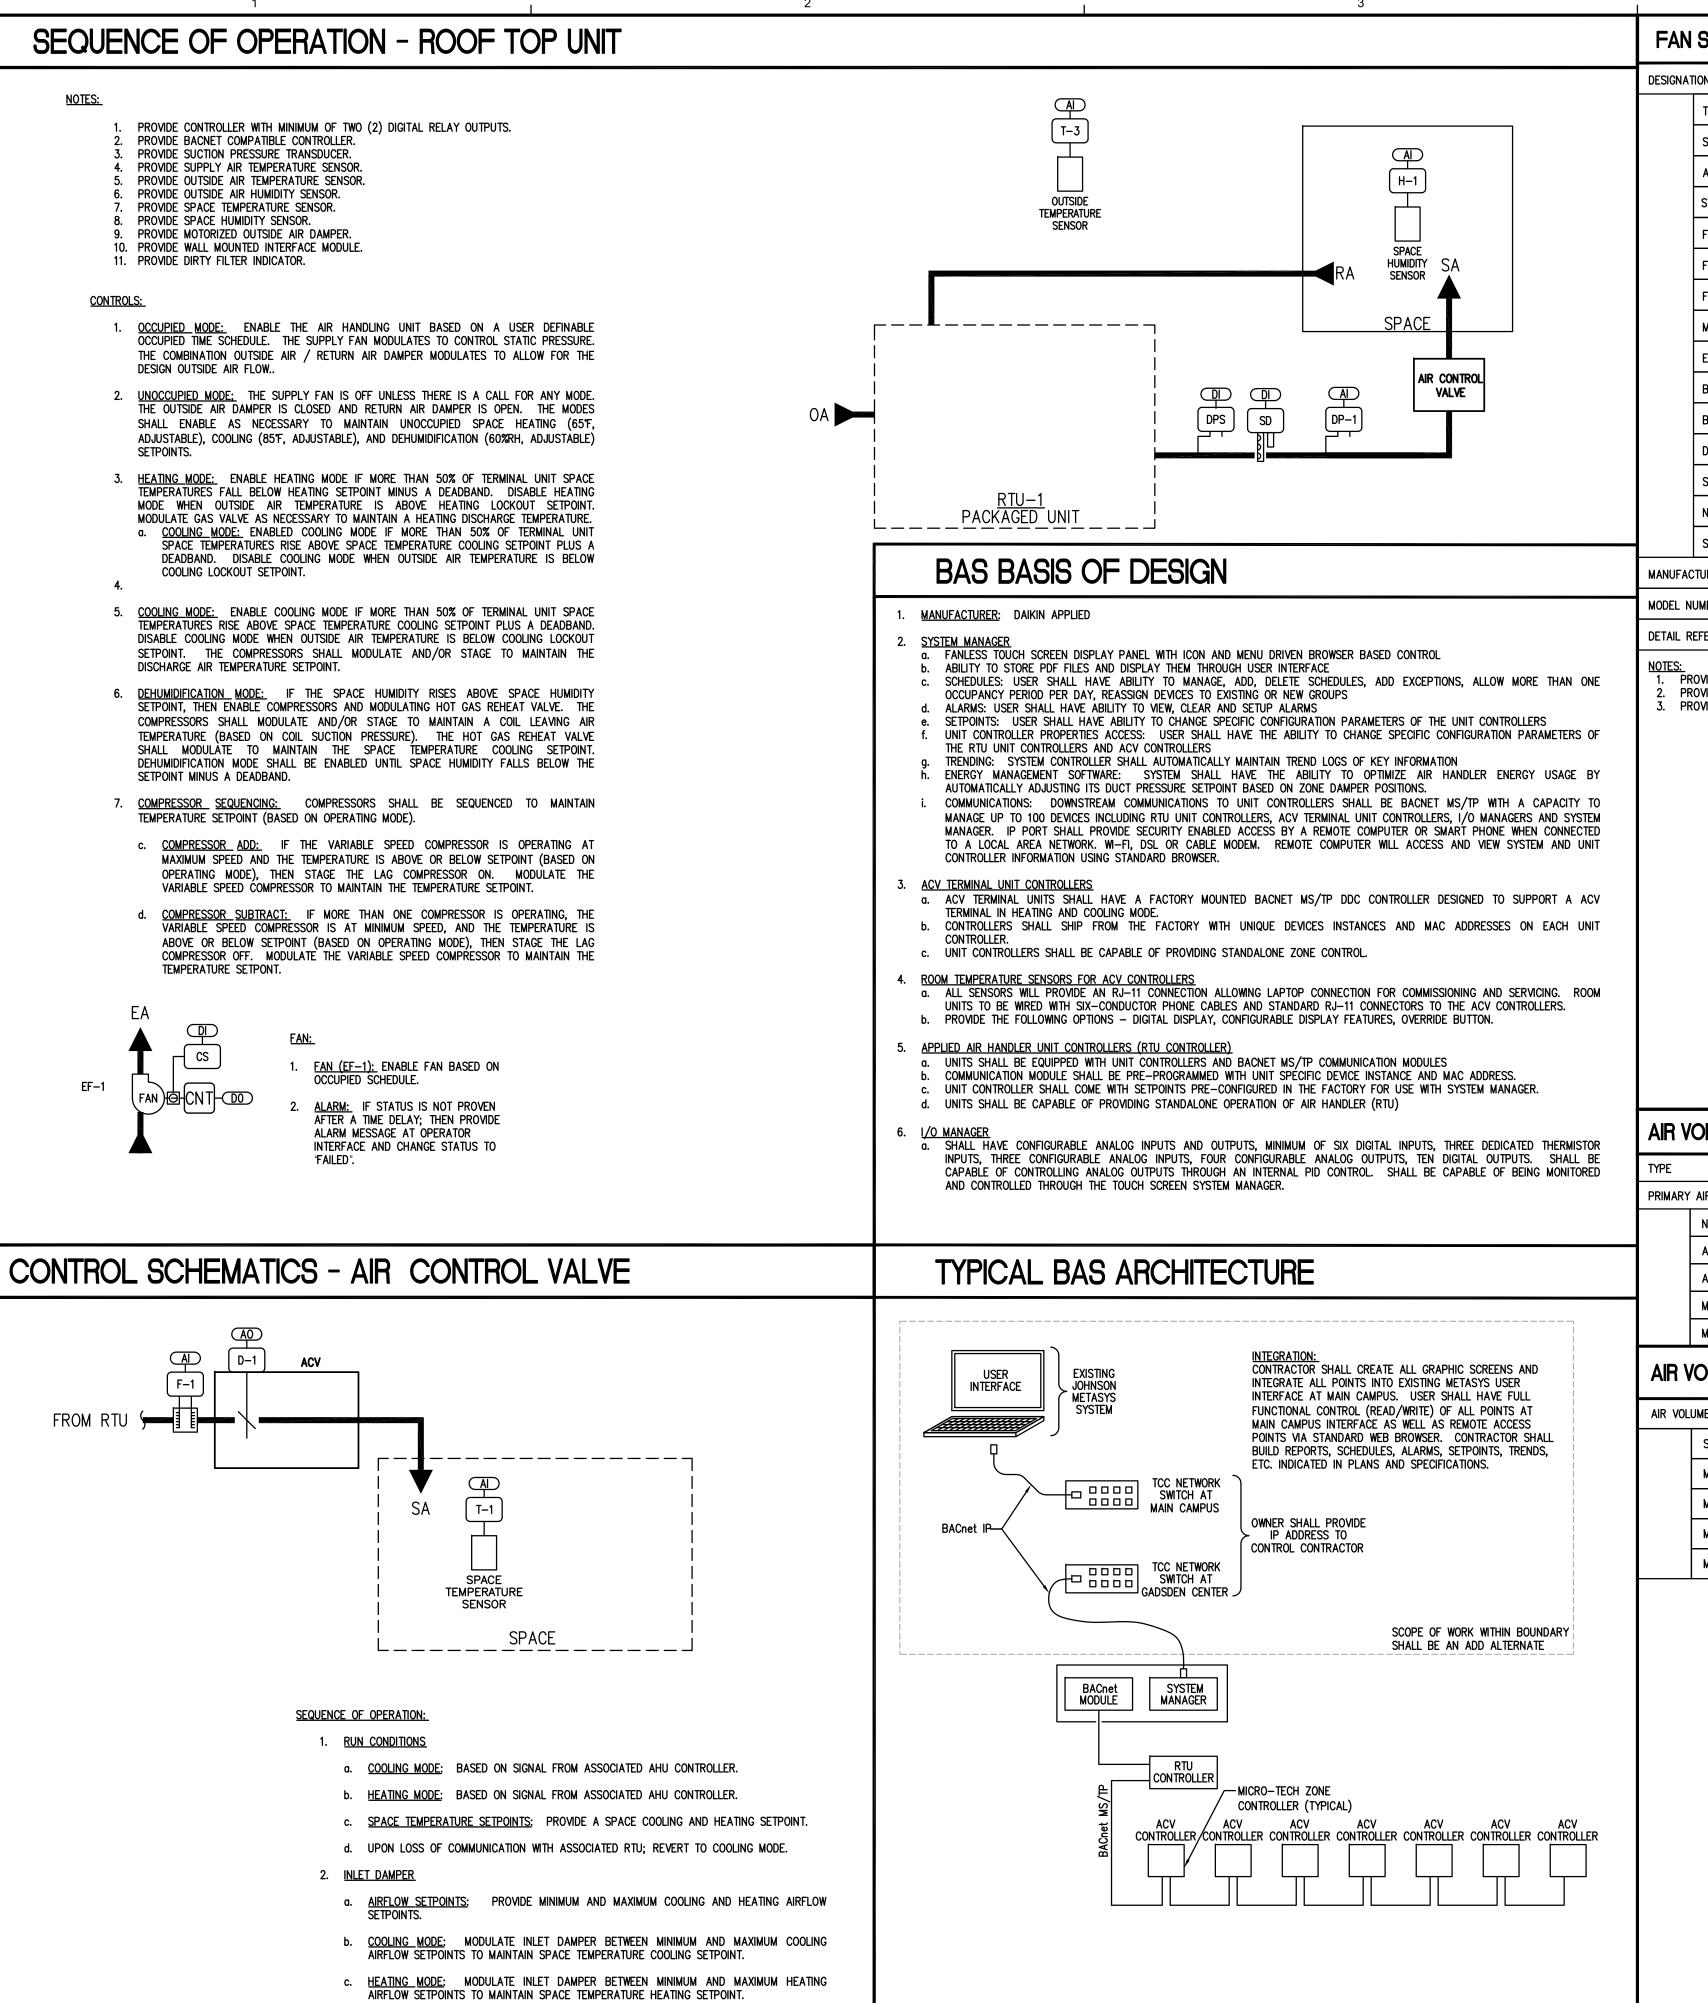
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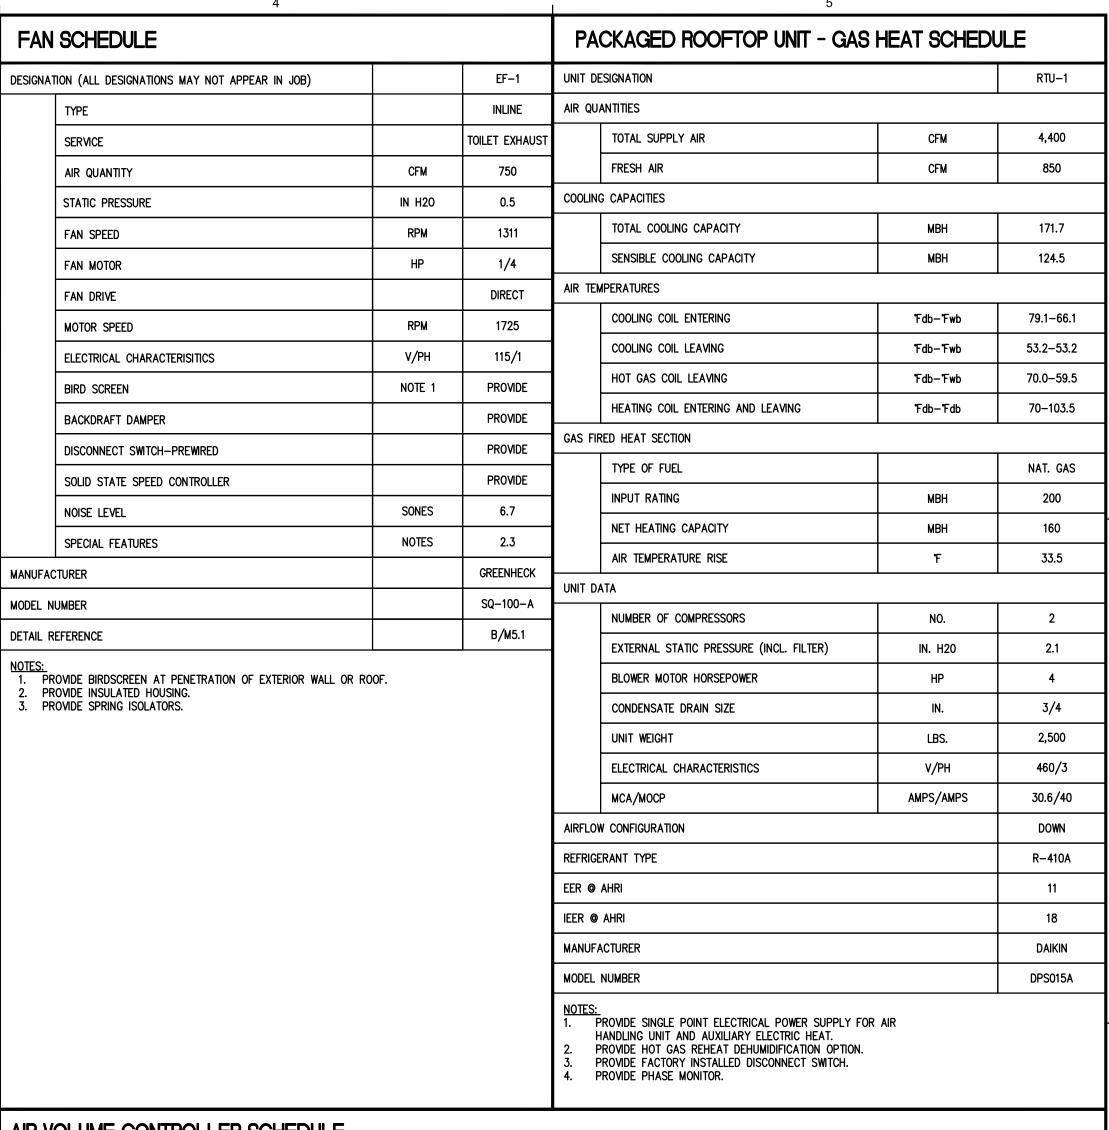
SCHEDULES - HVAC

Drawing No...



SCHEDULES

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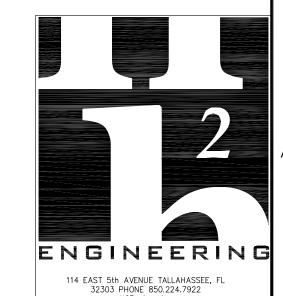


AIR VOLUME CONTROLLER SCHEDULE

TYPE			A	В	С				
PRIMARY	PRIMARY AIR VALVE								
	NOMINAL AIR VALVE DIAMETER	IN.	6	8	10				
	AIR VALVE MAXIMUM AIR FLOW CAPACITY	CFM	390	700	1,100				
	AIR VALVE MINIMUM AIR FLOW LIMIT	CFM	80	150	250				
	MANUFACTURER		Ruskin	Ruskin	Ruskin				
	MODEL		CDRAMS	CDRAMS	CDRAMS				

AIR VOLUME CONTROLLER DESIGNATION AND BALANCE CHART

										ĺ
AIR VOL	UME CONTROLLER DESIGNATION (AVC-)		102	103	108	110	116	117	118	
	SCHEDULED TYPE		В	С	A	С	В	В	В	
	MAXIMUM COOLING AIRFLOW	CFM	580	910	270	840	420	600	600	
	MINIMUM COOLING AIRFLOW	CFM	240	360	0	340	170	240	240	
	MAXIMUM HEATING AIRFLOW	CFM	580	910	0	840	420	600	600	
	MINIMUM HEATING AIRFLOW	CFM	240	360	0	340	170	240	240	
										4



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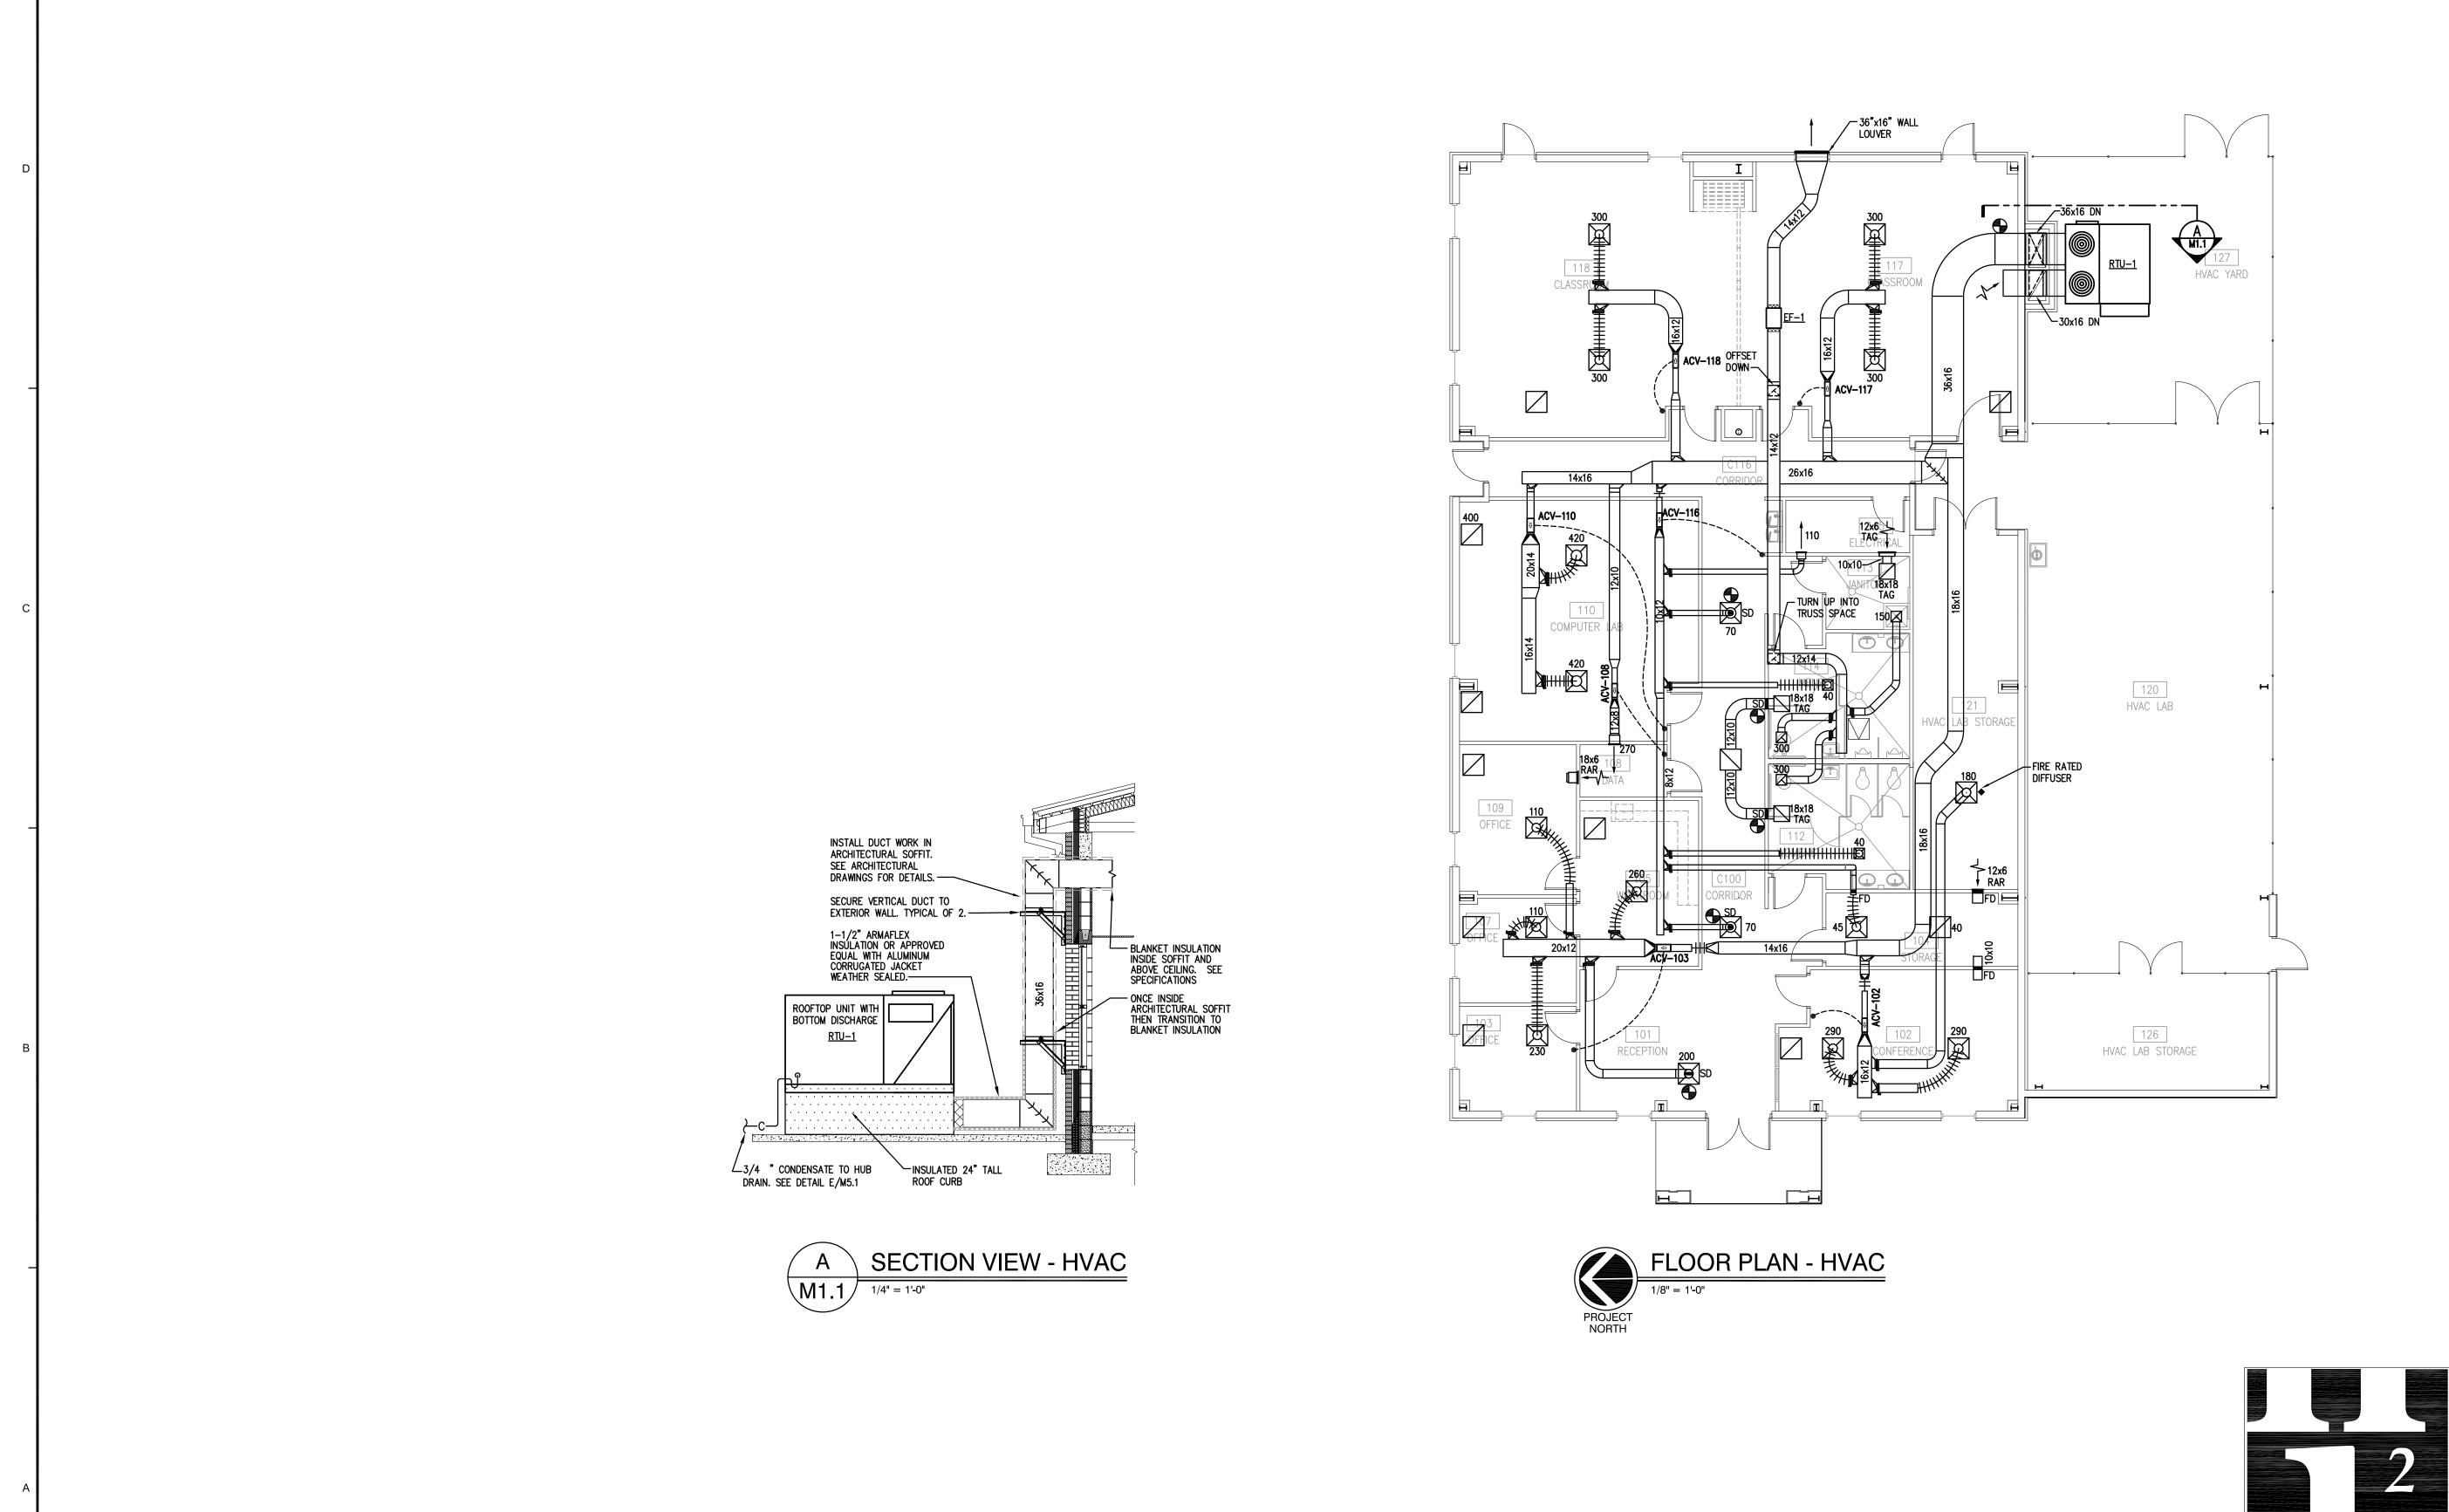
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10 JUNE 2015 Date:

14033 Project No

Drawing Title:

SCHEDULES - HVAC



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Revision Date: No. Description:

Drawn By: DAH/CJB Checked By: DMH

Date: 10 JUNE 2015


Project No.: 14033

Drawing Title:

FLOOR PLAN - HVAC

Drawing No.: M1.1

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M5.1 DETAILS - HVAC

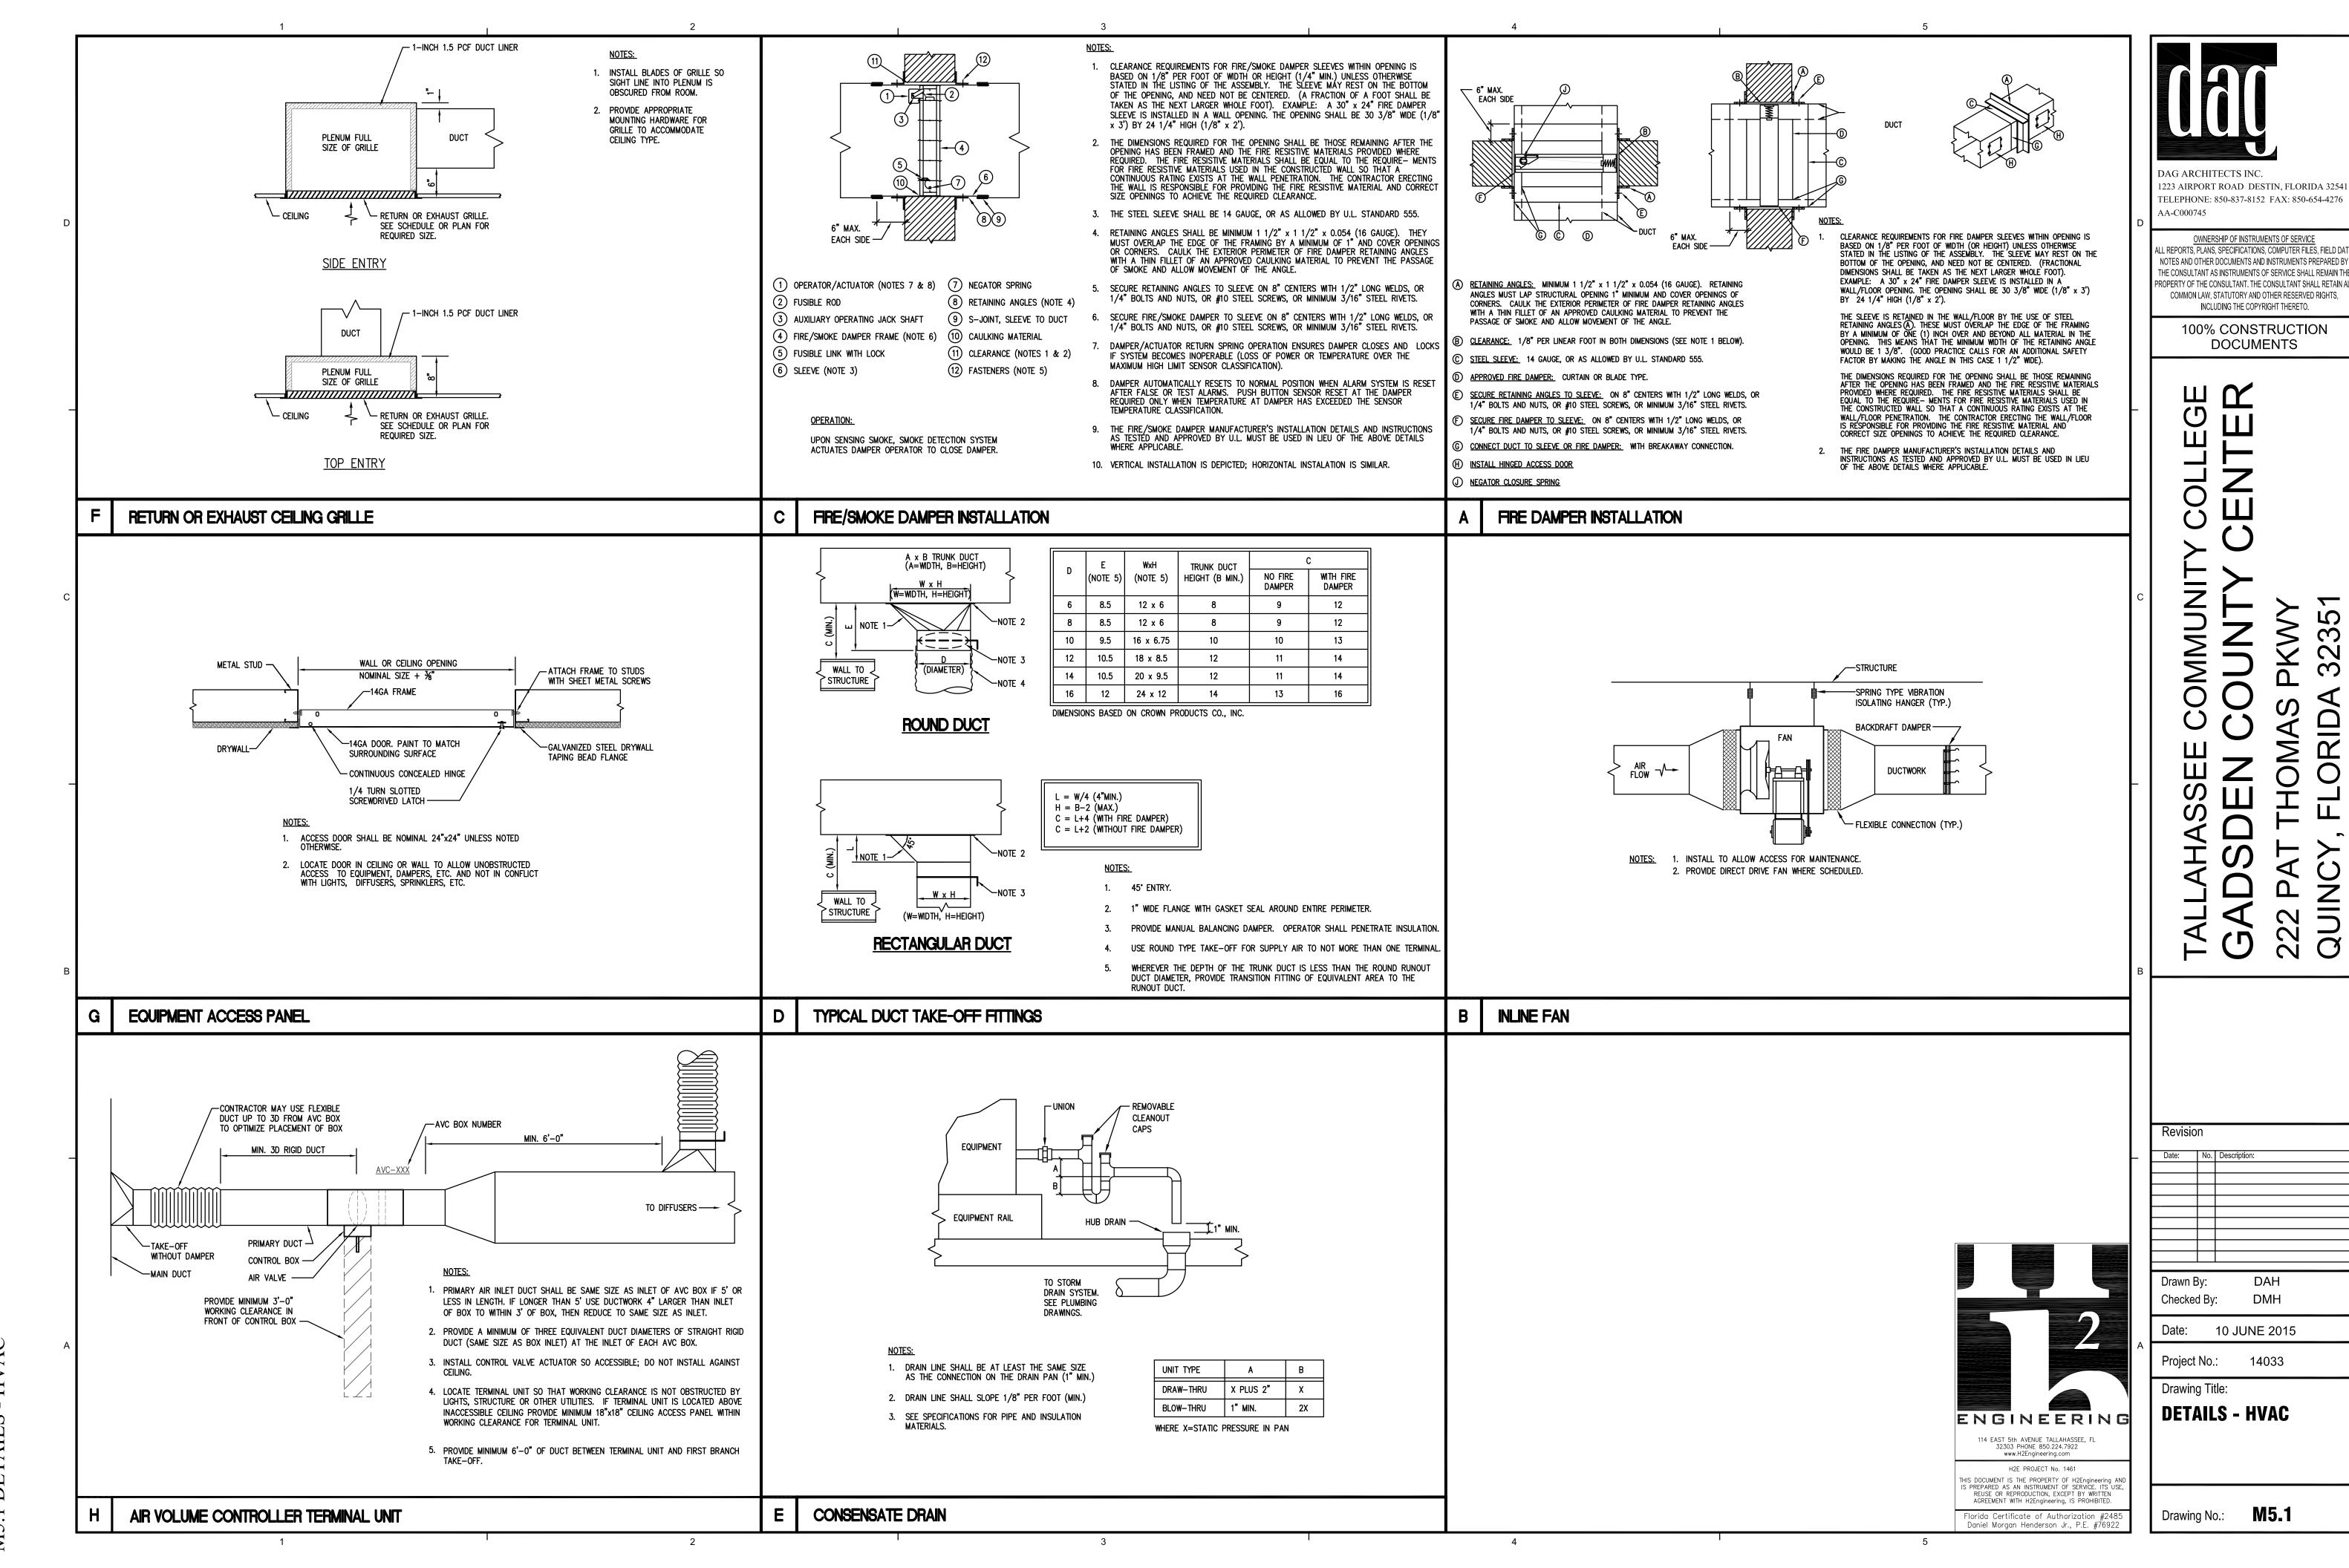1		1	2				3		4	5
ELECTRIC WATER HEATER SCHEDULE	E		PLUMBING FIXTURE SCHEDULE						PLUMBING NOTES	GENERAL NOTES
ESIGNATION	WH-1 WH-2	FIXTURE	FIXTURE DESCRIPTION	A D A LACUNTING LIFTCHT		PIPE SIZES	MANUFACTURER AND FIXTURE MODEL NUMBER	ACCESSORIES: D = DRAIN/STRAINER F = FAUCET	INSTALL ALL WORK IN ACCORDANCE WITH THE FLORIDA PLUMBING CODE AND LOCAL PLUMBING	DRAWINGS ARE DIAGRAMMATIC, INDICATIVE OF WORK TO BE FURNISHED AND INSTALLED UNDER THIS CONTRACT. REFER TO ARCHITECTURAL AND STRUCTURAL DRAWINGS FOR DIMENSIONS.
STORAGE GAL	20 NA	NUMBER		SUPPLY	HOT WATER SUPPLY	FIXTURE TRAP	DRAIN	V = FLUSH VALVE M = MISCELLANEOUS	CODES. WHERE CONFLICTS OCCUR BETWEEN CODES AND BETWEEN THE CONSTRUCTION DOCUMENTS AND CODES, THE MOST RESTRICTIVE REQUIREMENTS SHALL GOVERN.	
NUMBER OF ELEMENTS NO	1 NA	P-151	LOW-FLOW 1.28 GPF FLUSH VALVE WATER CLOSET, VITREOUS CHINA, SIPHON JET FLUSHING ACTION, ELONGATED RIM, 1½" TOP SPUD, MIN. 2" BALLPASS TRAPWAY. COLOR: WHITE.	YES FLOOR RIM: 16½" 1"		4"	4" AMERICAN STANDARD: 3461.001 ZURN: Z5665 * TOTO: CT705ELN	V-151M M-101	2. ALL MISCELLANEOUS EQUIPMENT TO BE FURNISHED UNDER OTHER SECTIONS OF THE SPECIFICATIONS THAT REQUIRE PIPING OR DUCT CONNECTIONS SHALL BE RECEIVED AND SET WITH ROUGH—IN AND FINAL CONNECTIONS MADE UNDER THESE SECTIONS.	2. FIELD VERIFY DIMENSIONS AND CONDITIONS. IF THE CONTRACTOR IS UNABLE TO INTERPRET CONTRACT DOCUMENTS, HE IS RESPONSIBLE TO REQUEST CLARIFICATION IN WRITING TO THE ARCHITECT. IF HE PROCEEDS WITH ANY WORK BEFORE OBTAINING CLARIFICATION, HE SHALL HELD RESPONSIBLE FOR DEFICIENCIES ASSOCIATED THEREWITH.
SIMULTANEOUS ELEMENTS OPERATION RECOVERY RATE GAL/HR	NO NA	P-152	LOW-FLOW 1.28 GPF FLUSH VALVE WATER CLOSET, VITREOUS CHINA, SIPHON JET FLUSHING ACTION, ELONGATED RIM, 1½" TOP SPUD, MIN. 2" BALLPASS TRAPWAY. COLOR: WHITE.	FLOOR RIM: 15" 1"		4"	AMERICAN STANDARD: 3451.001 ZURN: Z5655 * TOTO: CT705EN	V-151M M-101	3. PRESSURE TEST ALL WATER PIPING SYSTEMS AT 150% OF NORMAL WORKING PRESSURE. 4. ALL COPPER PRESSURE PIPE SHALL BE SOLDERED ENTIRELY WITH LEAD—FREE SOLDER.	3. BEFORE SUBMITTING FOR THE WORK, EACH BIDDER WILL BE RESPONSIBLE TO EXAMINE THE PREMISES AND SATISFY HIMSELF AS TO THE EXISTING CONDITIONS UNDER WHICH HE WILL BE OBLIGATED TO OPERATE AND COMPLETE THE WORK UNDER THIS CONTRACT. NO ALLOWANCE WILL SUBSEQUENTLY BE MADE IN THIS CONNECTION ON BEHALF OF THE CONTRACTOR FOR AI
TEMPERATURE RISE F	60 56	<u> </u>	1/8 GPF FLUSH VALVE URINAL, VITREOUS CHINA, HIGH EFFICIENCY WASHOUT FLUSHING ACTION, ¾ TOP SPUD. COLOR:	YFS WALL RIM: 17" 3/"		- "	AMERICAN STANDARD: 6590.001.020 SLOAN: SU-1009-A		5. INSTALLATION OF EQUIPMENT AND PIPING SHALL PROVIDE CONVENIENT ACCESS FOR MAINTENANCE.	ERROR OR OMISSION ON HIS PART. 4. THE CONTRACTOR SHALL PAY FOR INSPECTION PERMITS, CERTIFICATES, CONNECTION FEES, SYSTEM DEMAND CHARGES AND LICENSE FEES IN CONNECTION WITH HIS WORK.
LEAVING WATER TEMPERATURE F	120 110 208/1 208/1	P-251	1/8 GPF FLUSH VALVE URINAL, VITREOUS CHINA, HIGH	" YES WALL RIM: 17" ¾"		2"	ZURN: Z5755-U AMERICAN STANDARD: 6590.001.020	V-251M	6. ALL FLOOR DRAINS SHALL HAVE MINIMUM 3" DRAIN LINES, DEEP SEAL TRAPS AND AUTOMATIC TRAP PRIMERS (MANUFACTURER: PRECISION PLUMBING PRODUCTS).	5. CONSTRUCTION MANAGER SHALL BE RESPONSIBLE FOR COORDINATING WORK OF SUBCONTRACTORS TO AVOID INTERFERENCES.
ELECTRICAL CHARACTERISTICS VOLT/Ø MANUFACTURER	A.O. SMITH EEMAX	P-252	EFFICIENCY WASHOUT FLUSHING ACTION, 3/4 TOP SPUD. COLOR: WHITE.	RIM: 24" 34"		2"	2" SLOAN: SU-1009-A ZURN: Z5755-U	V-251M	7. WATER HAMMER ARRESTERS SHALL BE INSTALLED IN ACCORDANCE WITH PDI—WH201, AS MANUFACTURED BY WADE.	 WORK SHALL COMPLY WITH APPLICABLE O.S.H.A. AND E.P.A. REGULATIONS AND GUIDELINES. ERECT AND MAINTAIN REASONABLE PRECAUTIONS FOR SAFETY AND HEALTH INCLUDING POST
MODEL NUMBER NOTES:	DEL-20 SP4208	P-409	LAVATORY, 20"x18", VITREOUS CHINA, FAUCET HOLES ON 4" CENTERS, ANTI-SPLASH RIM AND HIGH BACK. COLOR: WHITE.	YES WALL RIM: 34" ½"		1火"	AMERICAN STANDARD 0355.012 KOHLER: K-2005-0 ZURN Z5344	D-401 F-404 M-201	8. ALL HOSE BIBBS, SILL COCKS AND/OR FAUCETS WITH HOSE CONNECTIONS SHALL HAVE A VACUUM BREAKER.	DANGER SIGNS AND OTHER WARNINGS AGAINST HAZARDS INCLUDING PROMULGATING SAFETY REGULATIONS. PROVIDE SAFETY PRECAUTIONS AND BARRICADES FOR PEDESTRIANS AT CONSTRUCTION VEHICLE ACCESS AND EGRESS LOCATIONS.
PROVIDE HIGH TEMPERATURE LIMIT SWITCH			LAVATORY, 20"x17" OVAL, VITREOUS CHINA, FAUCET HOLES OF 4" CENTERS, SELF-RIMMING. COLOR: WHITE.			1½"	AMERICAN STANDARD: 0419.444EC.020	D-402	 9. GRAVITY FLOW SYSTEMS HAVE SPACE PRIORITY FOR SLOPING PIPES, HOWEVER SLOPE MUST BE STARTED AT HIGHEST POINT POSSIBLE. 10. ALL WATER PIPING SUBJECT TO FREEZING SHALL BE FREEZE PROTECTED. THIS INCLUDES ALL 	 8. COORDINATE AND SEQUENCE CLEANING AND CONSTRUCTION WORK. SUBMIT A COMPLETELY DETAILED CONSTRUCTION SCHEDULE PRIOR TO PRE-CONSTRUCTION CONFERENCE. 9. THE CONTRACTOR SHALL STRICTLY BE HELD TO THE PROJECT SCHEDULE. HE SHALL PROVI
WATER HAMMER ARRESTER SCHEDULE		P-436	SINGLE COMPARTMENT SINK, SELF-RIMMING, 20"x19",	PLANS		1/4	Z KOHLER K-2196-4 ZURN Z5814 ELKAY LRAD1919-55	F-404 M-201	PIPING IN UNHEATED SPACES SUCH AS EQUIPMENT ROOMS, SOFFITS, EXTERIOR WALLS, CEILINGS, ETC.	SUFFICIENT MANPOWER AND EQUIPMENT TO FULLY MOBILIZE, PROCEED WITH AND COMPLETE WORK. 10. THE CONTRACTOR SHALL BE RESTRICTED TO AREAS SPECIFIED BY THE OWNER FOR ON-SITI
ART A - FOR CHART B - FOR LONG PIPE R	RUNS	P-501	16"x13½"x6" DEEP BOWL, 18 GAGE TYPE 304 STAINLESS STEEL, 2 FAUCET HOLES (ONE CENTERED, ONE 4" OFF CENTER), SOUND DEADENING COATING ON BOTTOM OF SINK.	YES COUNTER ARCH. 1/2" PLANS	½"	1½"	2" JUST SL-ADA-1921 -AHR-55	D-403 F-406 M-202	11. DO NOT LOCATE FLOOR DRAINS UNDER EQUIPMENT. COORDINATE EXACT LOCATION OF DRAINS WITH EQUIPMENT FURNISHED.	STORAGE OF CONSTRUCTION MATERIALS. THE CONTRACTOR IS RESPONSIBLE FOR THE PROTECTION AND SECURITY OF EQUIPMENT AND MATERIALS. 11 THE CONTRACTOR SHALL MAINTAIN A CLEAN WORK ENVIRONMENT AT ALL TIMES AND SHALL
I. FIXTURE UNITS P.D.I. WATER HAMMER ARREST		P-520	MOP SERVICE BASIN, 24"x24"x12" HIGH x 2" WIDE SHOULDERS ½" PITCH TOWARD INSIDE, PRECAST TERRAZZO (MIN. 3000 PSI AT 7 DAYS), SURFACE GROUND & POLISHED WITH ALL AIR HOLES/PITS GROUTED AND EXCESS REMOVED. COLOR: BLACK & WHITE MARBLE CHIPS IN GRAY PORTLAND CEMENT.	SI NO FLOOR N/A 1 3"	<i>1</i> 2"	3"	FIAT TSB-200 WILLIAMS SB-800	F-407 M-502 M-503 M-504	 12. ALL PLUMBING VENTS SHALL BE 2" MINIMUM, UNLESS NOTED OTHERWISE. 13. PROVIDE ACCESS PANEL AT EACH LOCATION WHERE A VALVE OR OTHER DEVICE REQUIRING SERVICE IS LOCATED ABOVE AN INACCESSIBLE CEILING OR INSIDE A WALL. ACCESS PANEL 	CLEAN CONSTRUCTION SITE OF DEBRIS AT COMPLETION OF THE JOB AND BEFORE FINAL PAYMENT IS MADE. 12. THE CONTRACTOR SHALL FURNISH "AS-BUILT" DRAWINGS TO THE ARCHITECT AT COMPLETION
33-60 25' A A B C		P-561	SINGLE COMPARTMENT LAUNDRY SINK, 23"x22" MOLDED STONE		1/2"	1½"	FIAT FL-1 OR APPROVED EQUAL	F-413 D-404	SHALL BE FIRE RATED IF INSTALLED IN A FIRE RATED CEILING OR WALL. 14. ANY PIPE THAT PASSES UNDER A FOOTING OR THROUGH A FOUNDATION WALL SHALL BE PROVIDED WITH A RELIEVING ARCH, OR A PIPE SLEEVE. SLEEVE SHALL BE BUILT INTO THE	CONSTRUCTION. 13. CONTRACTOR'S USE OF AN APPROVAL STAMP ON DOCUMENTS SUBMITTED AS SHOP DRAWN-PRODUCT DATA, SAMPLES AND SIMILAR SUBMITTALS CERTIFIES THAT THE CONTRACTOR HAS
50' A B C D 75' B C D AE 114–154 100' C D E F	F EF CF FF	P-601	DRINKING FOLINTAIN HIGH-LOW BARRIER-FREE TYPE 304	MINIMUM SPOLIT		1½"	ELKAY EDFP217C OR APPROVED EQUAL	M-202	FOUNDATION WALL. THE SLEEVE SHALL BE TWO PIPE SIZES GREATER THAN THE PIPE PASSING THROUGH THE WALL.	COMPLIED WITH THE CONTRACT DOCUMENT REQUIREMENTS RELATED TO "SHOP DRAWINGS, PRODUCT DATA AND SAMPLES".
155-330 125' C D F AF 155-330 150' D E F DF	EF EFF FF FFF		STAINLESS STEEL W/ SATIN FINISH, BACK PANEL AND ADA APRON. LEAD FREE. ICE MAKER HOOK-UP BOX, 18 GAUGE STEEL, EPOXY FINISH, COLD WATER SUPPLY VALVE WITH 5/8" OD COPPER SWEAT	36"/30"		174	GUY GRAY BIM875 OR			14. THE CONTRACTOR SHALL NOT BE RELIEVED OF RESPONSIBILITY FOR DEVIATIONS FROM REQUIREMENTS OF THE CONTRACT DOCUMENTS BY THE ARCHITECT/ ENGINEER'S APPROVAL SHOP DRAWINGS, PRODUCT DATA, SAMPLES OR SIMILAR SUBMITTALS UNLESS THE CONTRACT HAS SPECIFICALLY INFORMED THE ARCHITECT/ENGINEER IN WRITING OF SUCH DEVIATION AT
WATER HAMMER ARRESTERS SHALL BE INSTALLED IN ACCORDANCE W	WITH STANDARD PDI-WH201.	P-650	INLET AND ¼" OD COMPRESSION OUTLET.	WALL RECESSED ½"			BRADLEY S19-270JW OR		MEASUREMENTS AND CONTROLS THERMOMETER	TIME OF SUBMITTAL AND THE ARCHITECT/ENGINEER HAS GIVEN WRITTEN APPROVAL TO THE SPECIFIC DEVIATION. THE CONTRACTOR SHALL NOT BE RELIEVED OF RESPONSIBILITY FOR ERRORS OR OMISSIONS IN SHOP DRAWINGS, PRODUCT DATA, SAMPLES OR SIMILAR SUBMITTA
		P-752	EMERGENCY EYE/FACE WASH, SWING DOWN DESIGN, WITH DUAL SOFT FLOW ABS PLASTIC ANTI-SURGE SPRAY HEADS. CONTRACTOR SHALL COORDINATE MOUNTING LOCATION WITH ARCHITECTURAL EQUIPMENT LAYOUT.	WALL HOUNTED 1/2"			APPROVED EQUAL		THERMOME IER	BY THE ARCHITECT/ENGINEER'S APPROVAL THEREOF. 15. PRIOR TO INSTALLATION, COORDINATE AND ADJUST THE FINAL LOCATION OF WALL MOUNTED DEVICES AND EQUIPMENT WITH ALL CASEWORK, SHELVING, MARKERBOARDS, BULLETIN BOAR
									PIPING AND FITTINGS	OR OTHER WALL MOUNTED FURNISHINGS. 16. NOTE ANY SPECIAL REQUIREMENTS INVOLVED IN INSTALLING THE EQUIPMENT IN THE BUILDIN
			PLUMBING FIXTURE ACCESSORY SCHE	EDULE .					————O ELBOW TURNED UP	DISMANTLING AND REASSEMBLING OF ANY EQUIPMENT SHALL BE DONE AS REQUIRED FOR EINTO THE BUILDING AND EQUIPMENT ROOMS. 17. PROTECT THE ROOF FROM DAMAGE WHENEVER ANY WORK ON THE ROOF IS REQUIRED.
		ACCESSOR NUMBER	Y	ACCECCODY DECODINATION			MANUFACTUR MODEL NU	ER AND		18. SUPPORTS AND HANGERS SHALL PRESENT A NEAT, ORDERLY APPEARANCE.
				ACCESSORY DESCRIPTION					TEE, OUTLET DOWN SANITARY, SOIL OR WASTE PIPING	19. ROOF MOUNTED EQUIPMENT SHALL BE SECURED TO STRUCTURE TO RESIST A 130 MPH WIN LOAD. 20. CONTRACTOR SHALL MAINTAIN THE INTEGRITY OF ALL FIRE, SMOKE, AND ACOUSTICAL WALI
			EXPOSED MANUAL WATER CLOSET FLUSH VALVE, A.D.A. COMPL STOP, VACUUM BREAKER, CAST WALL FLANGE.				ZURN:	6047.121.002 111–1.28 Z6000AV–HET	——————————————————————————————————————	ASSEMBLIES. 21 REAM AND FLOOR PENETRATIONS SHALL BE APPROVED BY THE STRUCTURAL ENGINEER.
		V-251M	EXPOSED MANUAL URINAL FLUSH VALVE, A.D.A. COMPLIANT, P VACUUM BREAKER, CAST WALL FLANGE.	OLISHED CHROME PLATED, HIGH EFFICIENCY (1/	/8 GPF), ¾	4" SCREWDF	VER ANGLE STOP, AMERICAN STANDARD: SLOAN: ZURN:	6045.013.002 186-0.125 Z6003AV-ULF		SLEEVES AND BEAM REINFORCING APPROVED BY STRUCTURAL ENGINEER SHALL BE FURNIS AND INSTALLED BY THIS CONTRACTOR. 22. CONTRACTOR SHALL FURNISH U.L. APPROVED DRAWINGS FOR EACH TYPE OF FIRE RATED
		F-404	SINGLE INLET FAUCET, POLISHED CHROME PLATED BRASS, SEN PROVIDE AUTOMATIC SENSOR ADJUSTMENT WITH 10 SECOND C				LOW CONTROL. D.C. COVER PLATE. ZURN SLOAN	Z6915-F EBF-187-4 TEL3GSC-10/TN71V100	——————————————————————————————————————	ASSEMBLY PENETRATION BY DUCTS, PIPES OR CONDUITS. THESE DRAWINGS SHALL BE DISPLAYED ON THE JOB SITE AT ALL TIMES DURING CONSTRUCTION. SEE SPECIFICATIONS
		F-406	SINGLE LEVER DECK MOUNTED FAUCET, POLISHED CHROME PLA SOFT-CLOSING VALVE WITH INTEGRAL FLOW CONTROL AND AD-			TOR, HOSE	AND SPRAY, CHICAGO FAUCET T&S BRASS	2301-CP B-2730	HOSE BIBB WITH VACUUM BREAKER WALL HYDRANT WITH VACUUM BREAKER	23. CONTRACTOR SHALL GUARANTEE THE WORK AND MATERIALS FOR A PERIOD OF ONE YEAR DATE OF FINAL ACCEPTANCE. THIS GUARANTEE SHALL BE IN ADDITION TO THE WARRANT PROVIDED BY MATERIAL SUPPLIERS AND MANUFACTURERS.
		F-407	SERVICE SINK FAUCET, POLISHED CHROME PLATED BRASS, BUI	LT-IN STOPS, VACUUM BREAKER, LEVER HANDI	DLES, WALL	BRACE, ¾"	HOSE OUTLET. CHICAGO FAUCET	B-0665-BSTP	WATER HAMMER ARRESTER ——⊚CO CLEAN OUT — SEE DETAIL B/P5.1	A DDDEV//A TIONO
		F-413	CHROME PLATED BRASS, SINGLE VALVE FAUCET WITH 5 1/2" FLOW CONTROL ADJUSTABLE STOP, PROVIDE POLISHED CHROMI		FT-CLOSING	G TYPE WITH	INTEGRAL 1.5 GPM T&S BRASS CHICAGO FAUCET	Z842M1-RC B-2731 2300-8	FLOOR DRAIN - SEE DETAIL C/P5.1	BFF BELOW FINISHED FLOOR PDI PLUMBING DRAINAGE INSTITUTE
		D-401	1¼" CHROME PLATED BRASS OFFSET DRAIN WITH TAIL PIECE. PROTECTED WITH "TRAP WRAP" OR APPROVED EQUAL) BRASS ST	TRAINER, SU	PPLY LINES CHICAGO FAUCET KOHLER	337 K-7131-A		CO CLEANOUT PH PHASE CWS COLD WATER SUPPLY SAN SANITARY CDV COMBINATION DRAIN AND VENT TYP TYPICAL
		D-402	11/4" CHROME PLATED BRASS DRAIN WITH TAIL PIECE. PROVIDE	A PERFORATED FLAT CHROME PLATED BRASS	STRAINER.		CHICAGO FAUCET	LKAD174 327–X K–7715	- VALVES	DN DOWN V VOLTAGE ECO EXTERIOR CLEANOUT VTR VENT THROUGH ROOF HWS HOT WATER SUPPLY WH WATER HEATER
		D-403	TYPE 304 STAINLESS STEEL DRAIN, 3" STRAINER, 1½" CHROME	PLATED BRASS OFFSET TAILPIECE, WITH "TRAI	AP WRAP" (OR EQUAL.	ELKAY	LKAD-18 J-ADA-35-FS	N.O O O - N.C. BALL VALVE - SWING CHECK VALVE	N/A NOT APPLICABLE
		D-404	TYPE 304 STAINLESS STEEL DRAIN, REMOVEABLE CONICAL STR	AINER BASKET, 11/2" STAINLESS STEEL OFFSET	TAILPIECE.			LK35/LK53 J-35/J-53-S	RELIEF VALVE	
		M-101	EXTRA HEAVY DUTY, OPEN FRONT, ELONGATED SEAT, WITHOUT SEAT COLOR, S.S. POSTS FITTED WITH S.S. WASHERS AND NUT	COVER, SOLID PLASTIC, SELF SUSTAINING CHECTS.	ECK TYPE H	HINGE. HING	BENEKE:	1655SSC 527SS 1500STSCCSS	VALVE ACTUATORS: C QUARTER TURN LEVER	DRAWING INDEX
		M-201	LAVATORY P-TRAP: CAST BRASS ADJUSTABLE P-TRAP, TUBI	ING OUTLET, 11/4" x 11/2", CLEANOUT PLUG, POLIS	ISHED CHRO	OME PLATED	FINISH. KOHLER	K-8999-CP Z8701		P0.1 GENERAL NOTES, LEGENDS AND SCHEDULES — PLUMBING P1.1 FLOOR PLAN — PLUMBING
		M-202	SINK P-TRAP: CAST BRASS ADJUSTABLE P-TRAP, TUBING O	UTLET, 1½" x 1½", CLEANOUT PLUG, POLISHED	CHROME P	PLATED FINIS	I. KOHLER	K-9000-CP Z8702	MISCELLANEOUS	P5.1 DETAILS — PLUMBING
		M-502	ALUMINUM RIM GUARD FOR 24"x24" MOP SERVICE BASIN.				FIAT	239BB A-20	HINGED CEILING ACCESS PANEL	
		M-503	HOSE AND BRACKET FOR MOP SERVICE BASIN: HEAVY DUTY, I TYPE 302 STAINLESS STEEL WITH RUBBER GRIP.	FLEXIBLE, %" RUBBER, CLOTH REINFORCED, ¾"	BRASS CO	OUPLING. E	RACKET SHALL BE FIAT	832AA T-35	MIN. I.E. = MINIMUM INVERT ELEVATION BELOW REFERENCE ELEVATION]
		M-504	MOP HANGER FOR MOP SERVICE BASIN: STAINLESS STEEL WITH	H THREE RUBBER TOOL GRIPS.			FIAT	889CC T-40	POINT OF CONNECTION, PLUMBING TO CIVIL	
							WILLIAWS	1-40	1 HOUR FIRE RATED WALL	
			FIXTURE UNIT CALCULATIONS						MINIMUM REQUIRED SLOPE	
		FIXTURE	TYPE QUANTITY	DRAINAGE FIXTURE UNITS	ı		WATER SUPPLY FIXTURE UNITS	<u> </u>	ALL DRAINAGE PIPING	
			WATER CLOSETS 4	PER FIXTURE TOTAL COLD 6 24 10	SI	UBTOTAL 40	HOT SUBTOTAL HOT & C	OLD SUBTOTAL 40	PIPE SIZE, INCHES MIN. SLOPE, INCHES/FOOT 2"	
			URINALS 2	4 8 5		10	0 0 5	10	3" 1/8"	
			LAVATORIES (CW) 6 DRINKING FOUNTAIN 1	1 6 1.5 0.5 .5 0.25	-	9	0 0 1.5 0 0 0.25		4"	ENGINEERI
			SERVICE SINKS 1	2 2 2.25		2.25	2.25 2.25 3	3	1. COMBINATION DRAIN AND VENT PIPING SHALL BE RUN AT A MAXIMUM SLOPE OF 1/2" PER FOOT.	114 EAST 5th AVENUE TALLAHASSEE, F 32303 PHONE 850.224.7922 www.H2Engineering.com
			FLOOR DRAIN 4	2 8 0		0	0 0 0	0		H2E PROJECT No. 1461 THIS DOCUMENT IS THE PROPERTY OF H2Enging prepared as an instrument of service.
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LEGENDS AND SCHEDULES - PLUMBING

P0.1 GENERAL NOTES

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Revision

DAH Drawn By: Checked By: DMH

Date: 10 JUNE 2015


Project No.: 14033


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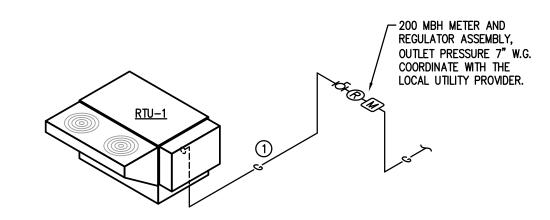
GENERAL NOTES, LEGENDS AND | SCHEDULES - PLUMBING

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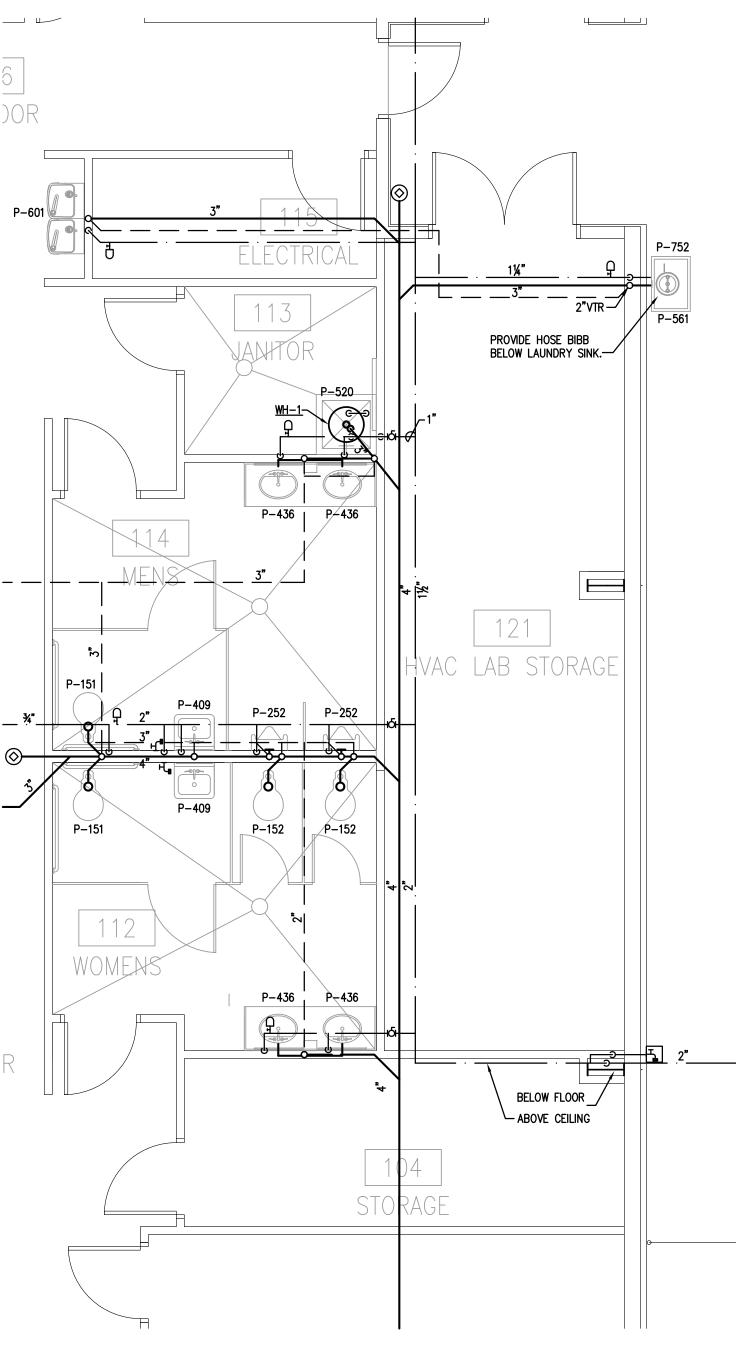
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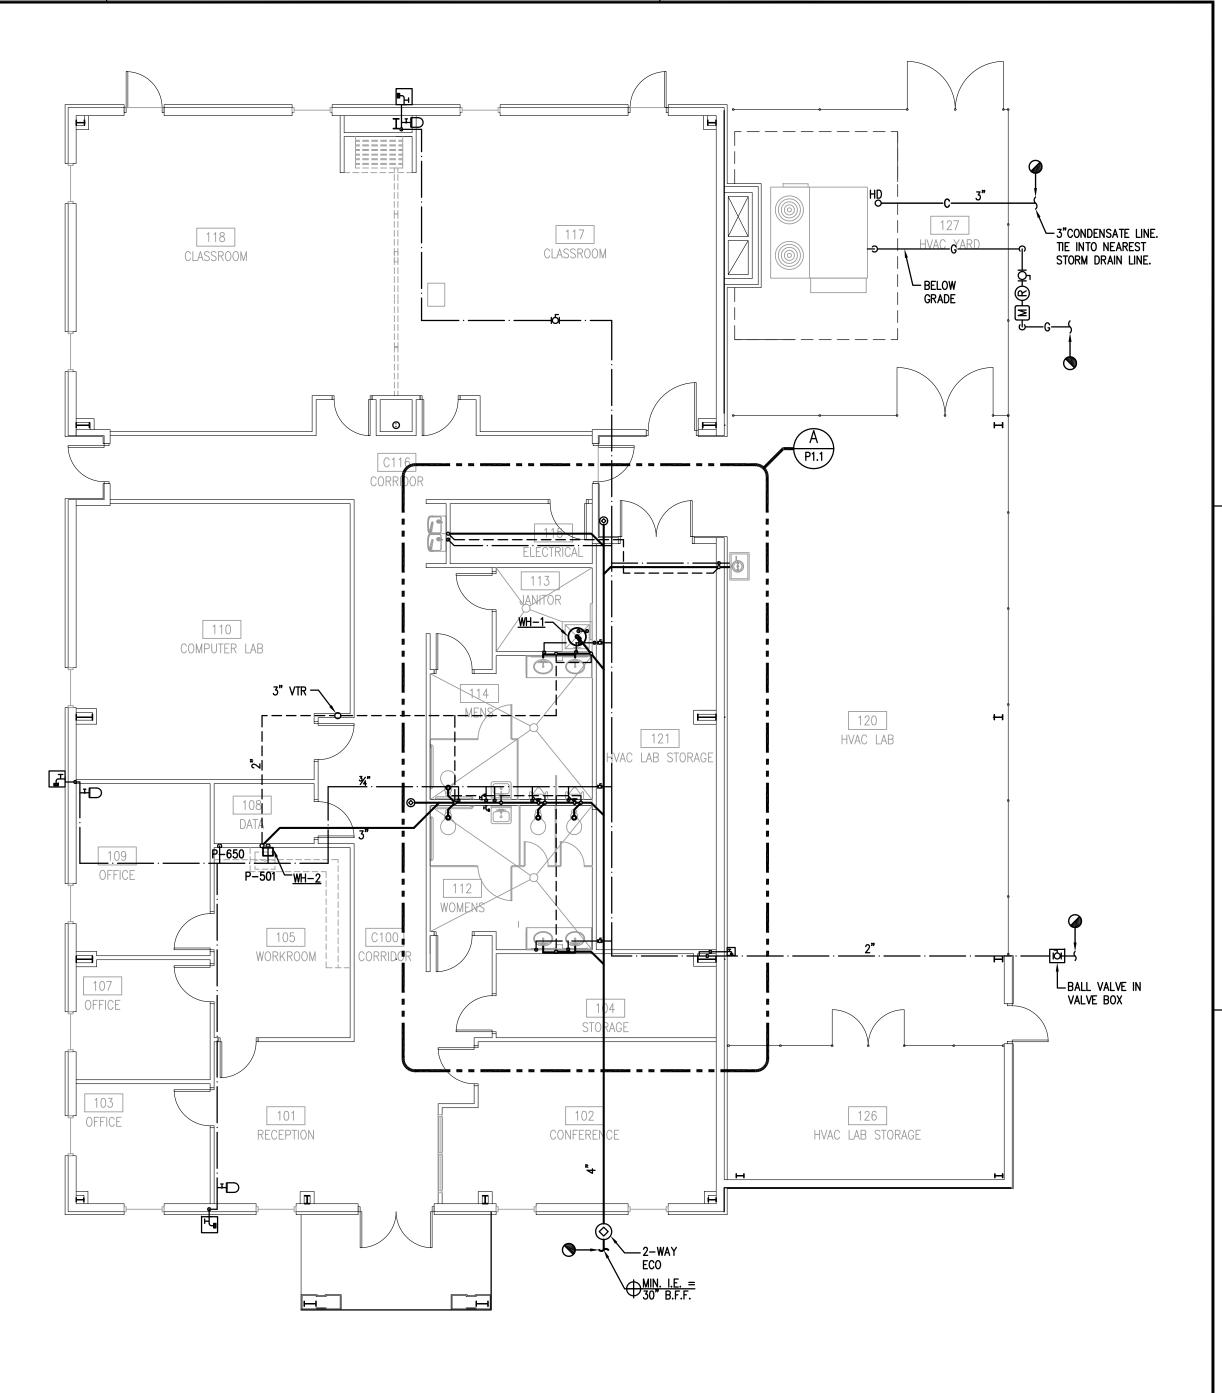





GAS SYSTEM RISER DIAGRAM

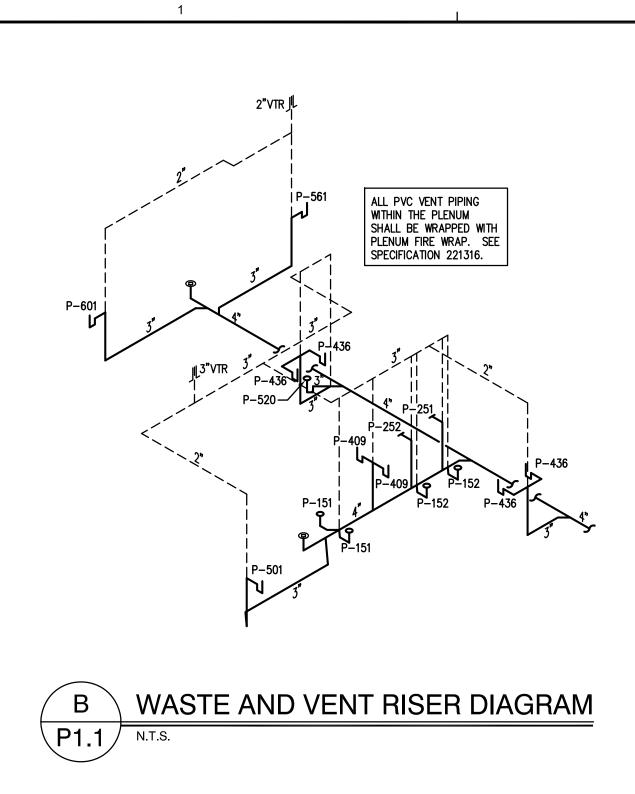

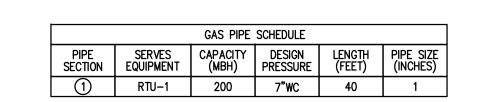





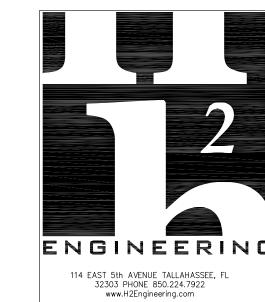

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Drawing No.: P1.1

Drawn By: DAH/CJB Checked By: DMH

Project No.: 14033

FLOOR PLAN -

PLUMBING

Drawing Title:

10 JUNE 2015

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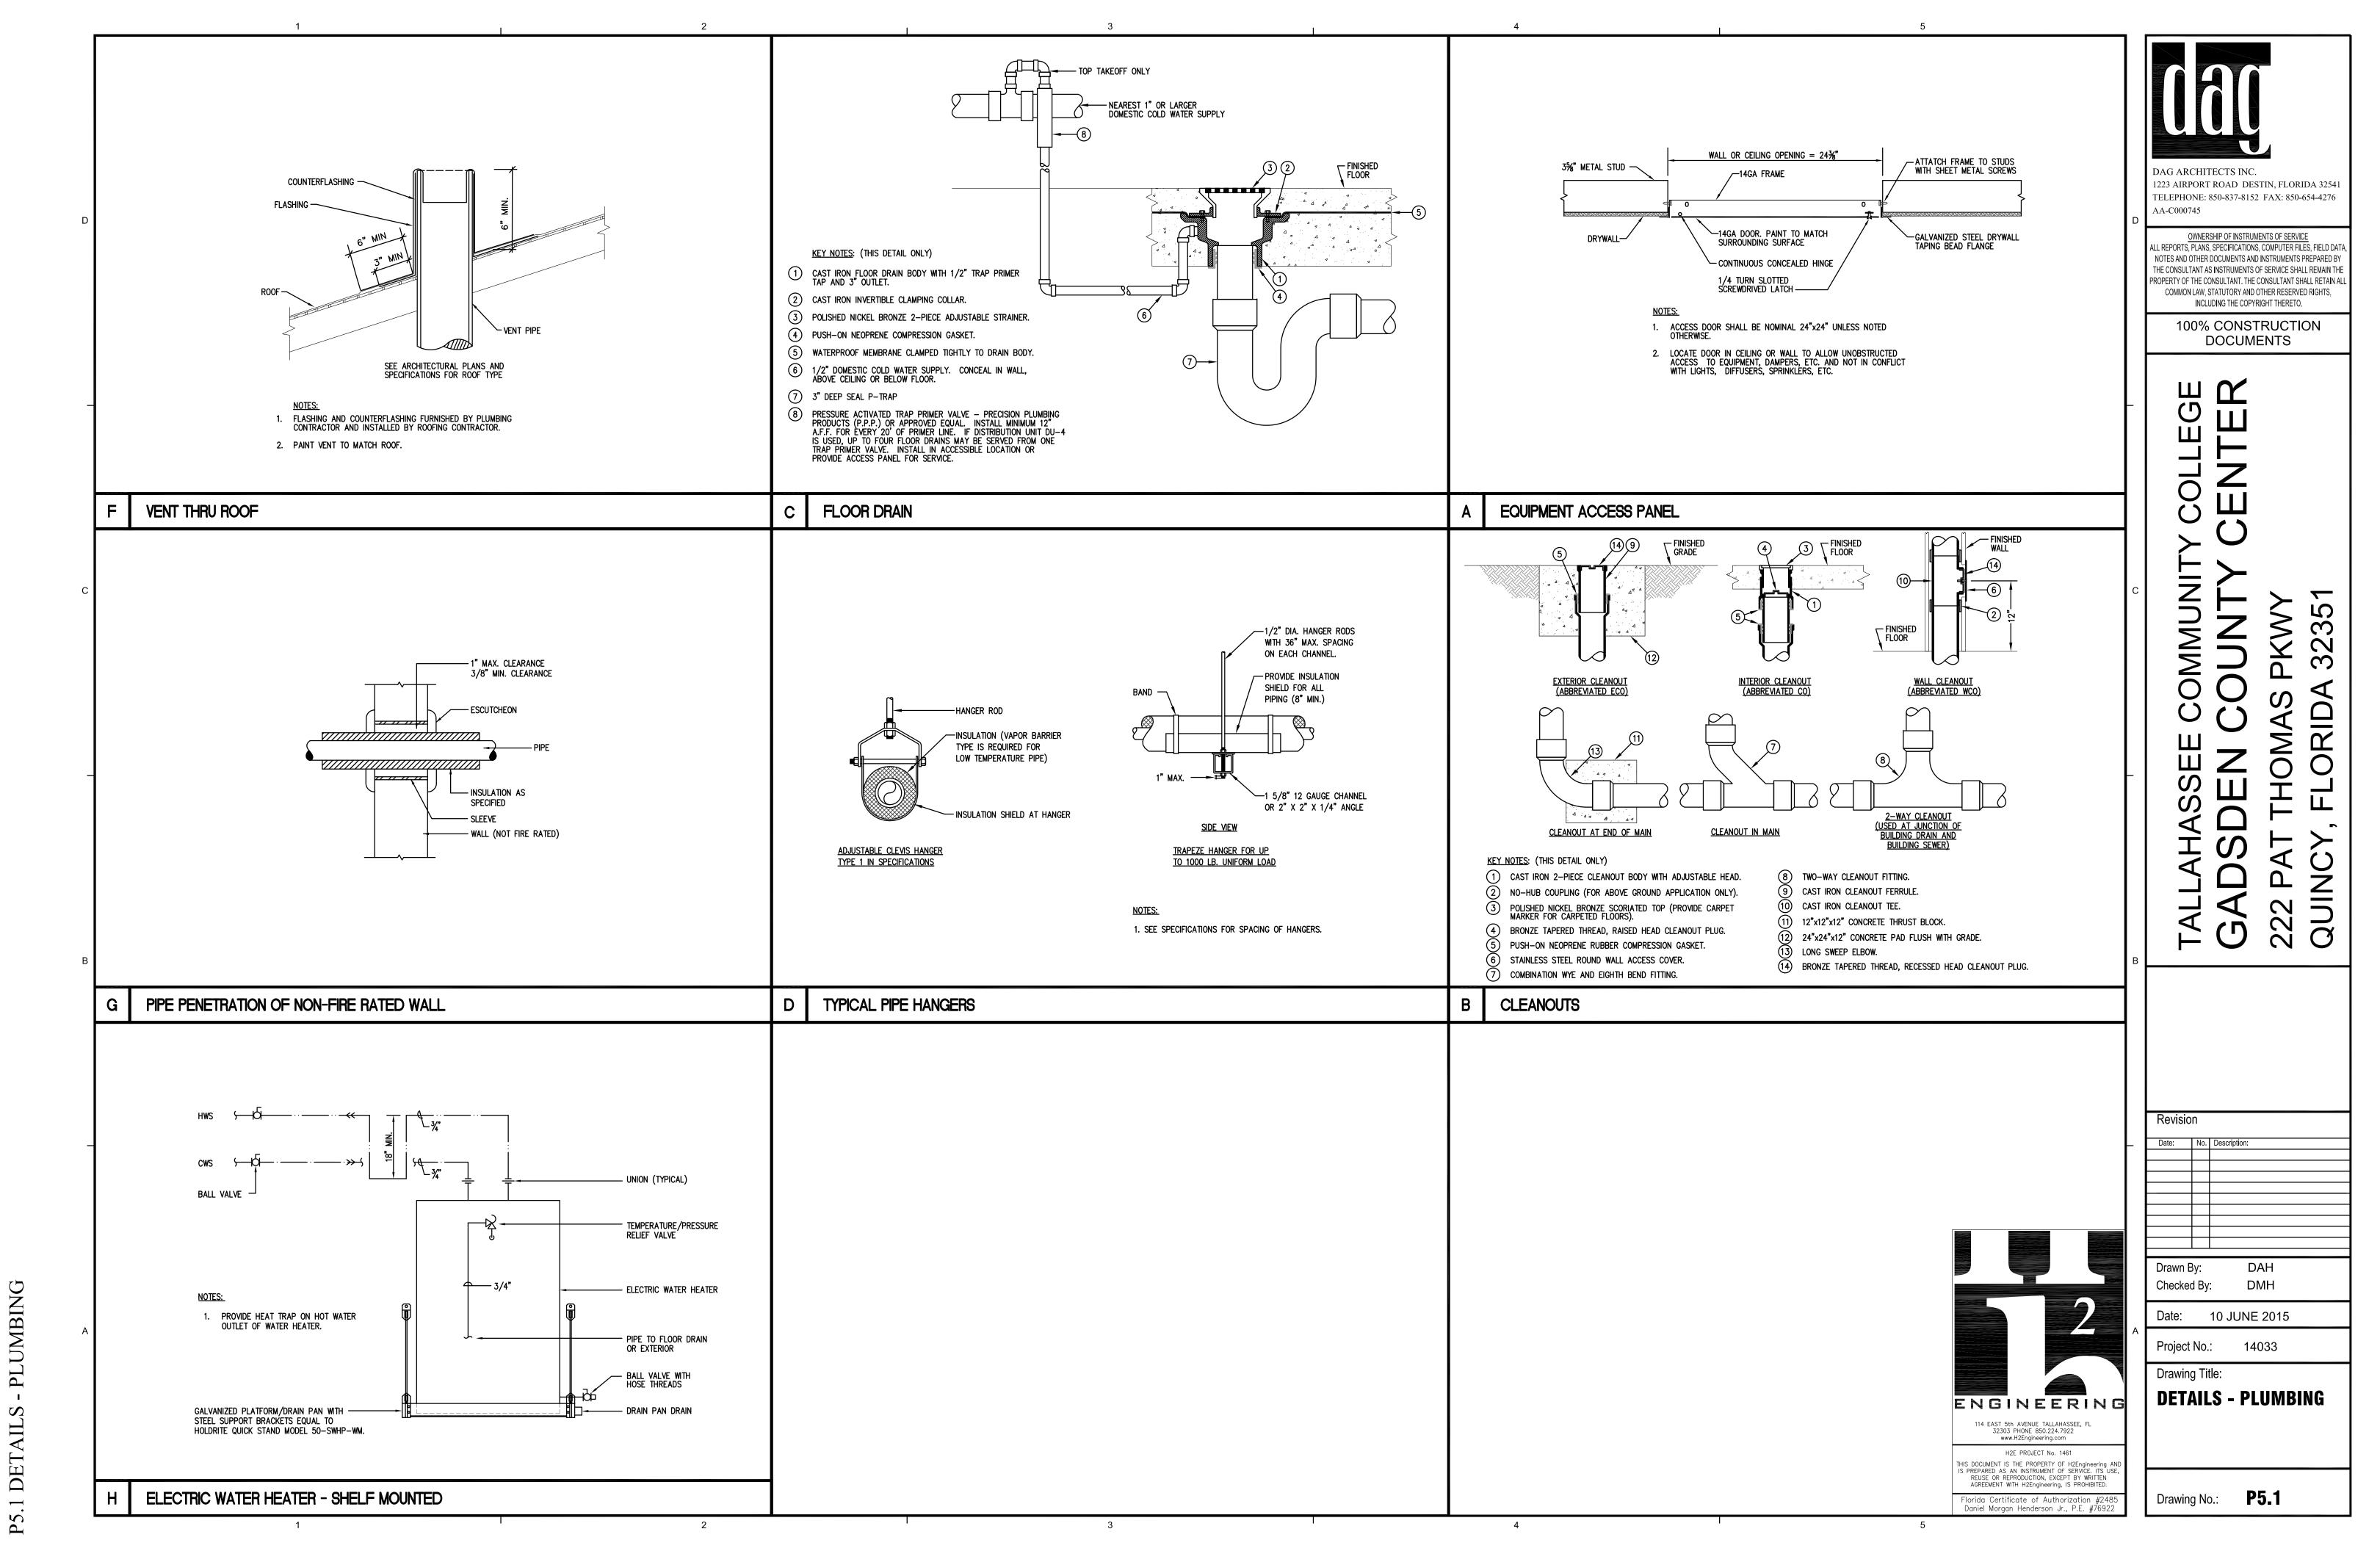
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	DUPLEX RECEPTACLE - 120 VOLT, 20 AMP, 3 POLE GROUNDING TYPE,	A##	LIGHT FIXTURE — CAPITAL LETTER INDICATES FIXTURE TYPE	FAAP	FIRE ALARM ANNUNCIATOR PANEL
	MOUNT 18" AFF UNLESS NOTED OTHERWISE	_		FACP	FIRE ALARM CONTROL PANEL
	DUPLEX RECEPTACLE - 120 VOLT, 20 AMP, 3 POLE GROUNDING TYPE, MOUNT ABOVE COUNTERTOP		LIGHT FIXTURE WITH EMERGENCY BATTERY BALLAST STRIP FIXTURE	Ē	MANUAL FIRE ALARM PULL STATION — MOUNT 48" AFF UNLESS NOTED OTHERWISE
	DUPLEX RECEPTACLE — SPLIT WIRED — 120 VOLT, 20 AMP, 3 POLE GROUNDING TYPE, MOUNT 18" AFF UNLESS NOTED OTHERWISE	0	RECESSED FIXTURE	Ē□	FIRE ALARM HORN/STROBE — MOUNT 80" AFF TO BOTTOM OF STROBE UNLESS NOTED OTHERWISE
	DUPLEX RECEPTACLE SERVING TV — 120 VOLT, 20 AMP, 3 POLE GROUNDING TYPE, MOUNT 78" AFF (U.N.O.).	•	RECESSED FIXTURE WITH NICKEL CADMIUM BATTERY CAPABLE OF POWERING LAMPS AT 66 -80% INITIAL LUMENS FOR 90 MINUTES	ŀĒ	ADA COMPLIANT FLASHING STROBE — MOUNT 80" AFF TO BOTTOM OF STROBE UNLESS NOTED OTHERWISE
	QUADRAPLEX RECEPTACLE — 120 VOLT, 20 AMP, 3 POLE GROUNDING TYPE, MOUNT 18" AFF UNLESS NOTED OTHERWISE	- ⊠	EXIT LIGHT FIXTURE — PROVIDE ARROWS WHERE SHOWN. PROVIDE DOUBLE—FACE EXIT LIGHT WHERE INDICATED (POWERED EXIT SIGNS	\$	SMOKE DETECTOR — CEILING MOUNTED — CONNECT TO FIRE ALARM SYSTEM
	SPECIAL PURPOSE RECEPTACLE - PROVIDE RECEPTACLE TO MATCH	- <u> </u>	SHALL BE WIRED "UNSWITCHED")	Θ	HEAT DETECTOR — CEILING MOUNTED, 135° TYPE UNLESS NOTED OTHERWISE
	EQUIPMENT TO BE SERVED, MOUNT 18" AFF UNLESS NOTED OTHERWISE	<u>г</u>	LED POLE MOUNTED FIXTURE — CAPITOL LETTER INDICATES FIXTURE TYPE PHOTO CELL — MOUNT NEAR TOP OF EXTERIOR WALL WHERE		FIRE SYSTEM TO ACTUATE SOLENOID VALVE (VALVE BY OTHERS)
	FLOOR BOX — QUADRAPLEX POWER OUTLET AND 4 JACK PLATE FOR COMMUNICATIONS. (WALKER #RFB-4/2-DTB-2-2T/RAKMII). ROUTE 1" COMMUNICATION CONDUIT & 3/4" POWER CONDUIT TO CORRIDOR WALL UP WALL TO ABOVE CEILING, THEN TURN INTO CEILING SPACE AND PROVIDE	-	IT IS IN DIRECT SUNLIGHT DENOTES WALL MOUNTED DEVICE	FASR	FIRE ALARM SYSTEM RELAY
	BUSHING. QUADRAPLEX RECEPTACLE — 120 VOLT, 20 AMP, 3 POLE GROUNDING	[LC] _{LC}	LIGHTING CONTACTOR	•	DUCT MOUNTED SMOKE DETECTOR — CONNECTED TO FIRE ALARM SYSTEM
	TYPE, FLUSH MOUNTED IN FLOOR (WALKER #RFB-4SS/ TWO RFB-DR/ RAKMII).	\$	SINGLE-POLE TOGGLE SWITCH - 120/277 VOLT, 20 AMP, MOUNT 48" AFF	SECURITY	
	DUPLEX RECEPTACLE — 120 VOLT, 20 AMP, 3 POLE GROUNDING TYPE, IN CEILING UNLESS NOTED OTHERWISE	\$ ₃	THREE-WAY SWITCH - 120/277 VOLT, 20 AMP, MOUNT 48" AFF	CR	SECURITY SYSTEM — CARD READER, PROVIDE ROUGH—IN ONLY. SEE DETAIL ON SHEET E5.2.
	12"x12"x4" DEEP PULL/JUNCTION BOX W/SCREW COVER (UNO)	\$ _D	0-10V DIMMER SWITCH, 48" AFF	DL	SECURITY SYSTEM — ELECTRIC DOOR LATCH, PROVIDE ROUGH—IN ONLY. SEE DETAIL ON SHEET E5.2.
	JUNCTION BOX - 4" SQUARE UNLESS NOTED OTHERWISE ADO = AUTOMATIC DOOR OPERATOR	\$ _M	MOTOR RATED TOGGLE SWITCH (20A/1P U.N.O.) OCCUPANCY SENSOR — LINE VOLTAGE, WALL MOUNTED, DUAL	[RX]	REQUEST TO EXIT DEVICE
	ELECTRICAL CONNECTION TO EQUIPMENT	\$ _{os}	TECHNOLOGY - MOUNT 48" AFF OCCUPANCY SENSOR - LOW VOLTAGE, WALL MOUNTED, DUAL	CXX)(SECURITY CAMERA
	WIRE IN CONDUIT - CONCEALED IN WALL OR CEILING	<u>M</u>	TECHNOLOGY OCCUPANCY SENSOR — LOW VOLTAGE, CEILING MOUNTED, DUAL TECHNOLOGY.	ADO	VIATIONS
	WIRE IN CONDUIT — CONCEALED IN FLOOR OR UNDERGROUND CONDUIT — STUB OUT AND CAP	<u>M</u>	OCCUPANCY SENSOR —LOW VOLTAGE, CEILING MOUNTED, ULTRASONIC — COVERAGE FOR LONG NARROW APPLICATIONS (CORRIDORS, ETC.)		
	HOMERUN TO PANEL — ARROWS INDICATE NUMBER OF CIRCUITS. SLASH MARKS INDICATE NUMBER OF CONDUCTORS, NO SLASH MARKS INDICATE 1	(P)	POWER/SWITCH PACK — MATCH VOLTAGE OF LIGHTS — LOCATE ABOVE ACCESSIBLE CEILING WHERE POSSIBLE		OVE COUNTERTOP OMATIC DOOR OPERATOR
	PHASE CONDUCTOR, 1 NEUTRAL CONDUCTOR, U.N.O. NOTE THAT THE GREEN GROUND WIRE IS NOT SHOWN BUT IS REQUIRED IN EACH FEEDER, LIGHTING, RECEPTACLE, AND POWER BRANCH CIRCUIT. THERE SHALL BE	TS	DIGITAL TIME SWITCH W/ AUDIBLE OR VISUAL ALERT BEFORE LIGHTS TURN OFF — MOUNT 48" AFF		OVE FINISHED FLOOR
	NO SHARED NEUTRALS BETWEEN MULTIPLE CIRCUITS. ELECTRIC PANEL — 120/208 VOLT	— b	CEILING FAN, CEILING MOUNT AS NOTED ON PLANS. COOK $22\frac{1}{2}$ " AIR CIRCULATOR, COMMERCIAL DUTY, $\frac{1}{8}$ HP, CATALOG #20CAC11W FINISH PER		OVE FINISHED GRADE NDUIT
	MOTOR - NUMBER INDICATES HORSEPOWER	TEL 500 ALAUNIO A	ARCHITECT OR EQUAL. PROVIDE CEILING MOUNT RECEPTACLE.	DN DON EM FIXT	WN TURE WITH EMERGENCY BATTERY BALLAST
	DISCONNECT SWITCH - SEE DRAWING FOR SIZE *	TELECOMMUNICA			CTRICAL CONTRACTOR
	COMBINATION DISCONNECT SWITCH & MAGNETIC MOTOR STARTER — WHEN SERVING MOTOR 15 HP OR LARGER, REDUCED VOLTAGE	<u>CBB</u>	COMMUNICATIONS BACKBOARD — EXTERIOR GRADE PLYWOOD, 8' HIGH X 3/4" THICK X WIDTH SHOWN ON PLANS		JIPMENT GROUNDING CONDUCTOR ERGENCY POWER OFF
	STARTER IS REQUIRED. (SEPARATE ITEMS ACCEPTABLE IN PLACE OF COMBINATION) — SEE DRAWING FOR SIZE *	©	COMMUNICATIONS TERMINAL OUTLET - 4" SQUARE OUTLET BOX, 2 1/8" DEEP WITH 1-GANG PLASTER RING. MOUNT AT 18" AFF. PROVIDE 1" CONDUIT TO ABOVE CEILING.		CTRIC WATER COOLER (GFI TYPE)
*	EQUIPMENT SIZES WILL BE INDICATED AS FOLLOWS: AMP RATING & POLE QTY.	⊙ ^{WAP}	COMMUNICATIONS WIRELESS ACCESS POINT TERMINAL OUTLET - 4" SQUARE OUTLET BOX, 2 1/8" DEEP WITH 1-GANG PLASTER RING MOUNT		DUND FAULT INTERRUPTER
NEMA SHOWN	SIZE 1 30/3 3R NEMA ENCLOSURE TYPE	TELEVISION	ABOVE CEILING.		VANIZED RIGID CONDUIT HT EMITTING DIODE
TITCHES	FUSE AMPS OR NON-FUSED (AS SHOWN)	TELEVISION	TELEVISION OUTLET - MOUNT 78" AFF UNLESS OTHERWISE NOTED. 4"		LESS NOTED OTHERWISE
	GROUNDING BUS BAR. REFER TO SPECIFICATION SECTION 260526 "GROUNDING AND BONDING FOR ELECTRICAL SYSTEMS."	- T √	SQUARE BY 2 1/8" DEEP WITH 1-GANG PLASTER RING. ROUTE 1" CONDUIT TO ABOVE CEILING. MOUNT ADJACENT DUPLEX RECEPTACLE AT 78" AFF.	WP WEA	ATHERPROOF
	LADDER RACK			DRAWI	NG INDEX
/ EME	ERGENCY SHUT-OFF SYSTEM				GEND — ELECTRICAL
	CLASSROOM POWER CIRCUITS EMERGENCY CONTACTOR	1			ENERAL NOTES AND SCHEDULE — ELECTRICAL TE PLAN — ELECTRICAL
	EMERGENCY POWER OFF SWITCH - GLASS BREAK STYLE WITH NORMALLY CLOSED 120V CONTACT. PROVIDE TWO SPARE GLASS SHROUDS PER	1			OOR PLAN - LIGHTING
	LOCATION.	-			OOR PLAN — POWER SER DIAGRAMS — ELECTRICAL
					SER DIAGRAM - SYSTEMS
				E4.1 P/	ANEL SCHEDULES - ELECTRICAL
				E5.1 DE	ETAILS — ELECTRICAL
				E5.2 DE	ETAILS — ELECTRICAL
					ENGINEERING
					114 EAST 5th AVENUE TALLAHASSEE, FL 32303 PHONE 850.224.7922 www.H2Engineering.com
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STRUCTION MENTS

PKWY 32351 **THOMAS**

ORIDA

Revisio	n	
Date:	No.	Description:
		_

ELECTRICAL

GENERAL NOTES INTERFERENCES. EQUIPMENT ROOMS.

ELECTRICAL GENERAL NOTES

- . DRAWINGS ARE DIAGRAMMATIC, INDICATIVE OF WORK TO BE FURNISHED AND INSTALLED UNDER THIS CONTRACT. REFER TO ARCHITECTURAL AND STRUCTURAL DRAWINGS FOR ALL DIMENSIONS.
- 2. FIELD VERIFY ALL DIMENSIONS AND ALL CONDITIONS. IF THE CONTRACTOR IS UNABLE TO INTERPRET THE CONTRACT DOCUMENTS, HE IS RESPONSIBLE TO REQUEST CLARIFICATION IN WRITING TO THE ARCHITECT. IF HE PROCEEDS WITH ANY WORK BEFORE OBTAINING CLARIFICATION, HE SHALL BE HELD RESPONSIBLE FOR ALL DEFICIENCIES ASSOCIATED THEREWITH.
- 3. BEFORE SUBMITTING FOR THE WORK, EACH BIDDER WILL BE RESPONSIBLE TO EXAMINE THE PREMISES AND SATISFY HIMSELF AS TO THE EXISTING CONDITIONS UNDER WHICH HE WILL BE OBLIGED TO OPERATE AND COMPLETE THE WORK UNDER THIS CONTRACT. NO ALLOWANCE WILL SUBSEQUENTLY BE MADE IN THIS CONNECTION ON BEHALF OF THE CONTRACTOR FOR ANY ERROR OR OMISSION ON HIS PART.
- 4. THE CONTRACTOR SHALL PAY FOR ALL INSPECTION PERMITS, CERTIFICATES, CONNECTION FEES, SYSTEM DEMAND CHARGES AND LICENSE FEES IN CONNECTION WITH HIS WORK.
- 5. GENERAL CONTRACTOR SHALL BE RESPONSIBLE FOR COORDINATING WORK OF ALL SUBCONTRACTORS TO AVOID INTERFERENCES
- 6. ALL WORK SHALL COMPLY WITH APPLICABLE O.S.H.A. AND E.P.A. REGULATIONS AND GUIDELINES.
- 7. ERECT AND MAINTAIN ALL REASONABLE PRECAUTIONS FOR SAFETY AND HEALTH INCLUDING POSTING DANGER SIGNS AND OTHER WARNINGS AGAINST HAZARDS INCLUDING PROMULGATING SAFETY REGULATIONS. PROVIDE SAFETY PRECAUTIONS AND BARRICADES FOR PEDESTRIANS AT CONSTRUCTION VEHICLE ACCESS AND EGRESS
- 8. COORDINATE AND SEQUENCE ALL CLEANING AND CONSTRUCTION WORK. SUBMIT A COMPLETELY DETAILED CONSTRUCTION SCHEDULE PRIOR TO PRE—CONSTRUCTION CONFERENCE.
- 9. THE CONTRACTOR SHALL STRICTLY BE HELD TO THE PROJECT SCHEDULE. HE SHALL PROVIDE SUFFICIENT MANPOWER AND EQUIPMENT TO FULLY MOBILIZE, PROCEED WITH AND COMPLETE THE WORK.
- 10. THE CONTRACTOR SHALL BE RESTRICTED TO AREAS SPECIFIED BY THE OWNER FOR ON-SITE STORAGE OF CONSTRUCTION MATERIALS. THE CONTRACTOR IS RESPONSIBLE FOR THE PROTECTION AND SECURITY OF ALL EQUIPMENT AND MATERIALS.
- 11. THE CONTRACTOR SHALL MAINTAIN A CLEAN WORK ENVIRONMENT AT ALL TIMES AND SHALL CLEAN CONSTRUCTION SITE OF ALL DEBRIS AT COMPLETION OF THE JOB AND BEFORE FINAL PAYMENT IS MADE.
- 12. THE CONTRACTOR SHALL FURNISH "AS-BUILT" DRAWINGS TO THE OWNER AT COMPLETION OF CONSTRUCTION.
- 13. CONTRACTOR'S USE OF AN APPROVAL STAMP ON DOCUMENTS SUBMITTED AS SHOP DRAWINGS, PRODUCT DATA, SAMPLES AND SIMILAR SUBMITTALS CERTIFIES THAT THE CONTRACTOR HAS COMPLIED WITH THE CONTRACT DOCUMENT REQUIREMENTS RELATED TO "SHOP DRAWINGS, PRODUCT DATA AND SAMPLES".
- 14. THE CONTRACTOR SHALL NOT BE RELIEVED OF RESPONSIBILITY FOR DEVIATIONS FROM REQUIREMENTS OF THE CONTRACT DOCUMENTS BY THE ARCHITECT/ENGINEER'S APPROVAL OF SHOP DRAWINGS, PRODUCT DATA, SAMPLES OR SIMILAR SUBMITTALS UNLESS THE CONTRACTOR HAS SPECIFICALLY INFORMED THE ARCHITECT/ENGINEER IN WRITING OF SUCH DEVIATION AT THE TIME OF SUBMITTAL AND THE ARCHITECT/ENGINEER HAS GIVEN WRITTEN APPROVAL TO THE SPECIFIC DEVIATION. THE CONTRACTOR SHALL NOT BE RELIEVED OF RESPONSIBILITY FOR ERRORS OR OMISSIONS IN SHOP DRAWINGS, PRODUCT DATA, SAMPLES OR SIMILAR SUBMITTALS BY THE ARCHITECT/ENGINEER'S APPROVAL THEREOF.
- 15. PRIOR TO INSTALLATION, COORDINATE AND ADJUST THE FINAL LOCATION OF ALL WALL MOUNTED DEVICES AND EQUIPMENT WITH ALL CASEWORK, SHELVING, BLACKBOARDS, BULLETIN BOARDS OR OTHER WALL MOUNTED FURNISHINGS.
- 16. NOTE ANY SPECIAL REQUIREMENTS INVOLVED IN INSTALLING THE EQUIPMENT IN THE BUILDING. DISMANTLING AND REASSEMBLING OF ANY EQUIPMENT SHALL BE DONE AS REQUIRED FOR ENTRY INTO THE BUILDING AND EQUIPMENT ROOMS.
- 17. PROTECT THE ROOF FROM DAMAGE WHENEVER ANY WORK ON THE ROOF IS REQUIRED.
- 18. SUPPORTS AND HANGERS SHALL PRESENT A NEAT, ORDERLY APPEARANCE. ALL EXTERIOR STRUCTURES SHALL BE INSTALLED TO RESIST AN ULTIMATE WIND SPEED = 130 MPH, RISK CATEGORY III, EXPOSURE B. REFER TO STRUCTURAL DRAWINGS FOR ADDITIONAL INFORMATION.
- 19. CONTRACTOR SHALL MAINTAIN THE INTEGRITY OF ALL FIRE AND SMOKE WALL ASSEMBLIES AND ACOUSTICAL
- 20. BEAM AND FLOOR PENETRATIONS SHALL BE APPROVED BY THE STRUCTURAL ENGINEER. BEAM SLEEVES AND BEAM REINFORCING APPROVED BY STRUCTURAL ENGINEER SHALL BE FURNISHED AND INSTALLED BY THIS CONTRACTOR.
- 21. CONTRACTOR SHALL FURNISH U.L. APPROVED DRAWINGS FOR EACH TYPE OF FIRE RATED ASSEMBLY PENETRATION BY DUCTS, PIPES OR CONDUITS. THESE DRAWINGS SHALL BE DISPLAYED ON THE JOB SITE AT ALL TIMES DURING CONSTRUCTION. SEE SPECIFICATIONS.
- 22. PROVIDE PROPER PROTECTIVE MEASURES TO PROTECT FURNITURE, CARPET AND FINISHES DURING THE COURSE OF CONSTRUCTION, TAKE CARE NOT TO DAMAGE SURFACES.
- 23. ALARM, SUPERVISORY AND TROUBLE SIGNALS SHALL BE AUTOMATICALLY TRANSMITTED TO AN APPROVED CENTRAL STATION, REMOTE SUPERVISING STATION OR PROPRIETARY SUPERVISING STATION AS DEFINED IN NFPA 72 OR, WHEN APPROVED BY THE BUILDING OFFICIAL, SHALL SOUND AN AUDIBLE SIGNAL AT A CONSTANTLY ATTENDED LOCATION.
- 24. ALL EXTERIOR DEVICES SHALL BE WEATHER PROOF ENCLOSURES AND GFI RATED IN ACCORDANCE WITH N.E.C. INSTALLER REQUIRED TO VERIFY PRIOR TO ORDERING MATERIALS.
- 25. ALL DEVICE MOUNTING HEIGHTS INDICATED SHALL BE TO OUTLET BOX CENTER LINE.
- 26. FIRE ALARM DRAWINGS INDICATE DESIGN INTENT. ACTUAL DEVICE TYPES. QUANTITIES AND LOCATIONS SHALL BE VERIFIED BY THE FIRE ALARM CONTRACTOR TO MEET ALL APPLICABLE CODES AND STANDARDS. ANY DEVIATIONS FROM THE DRAWINGS SHALL BE INDICATED ON FIRE ALARM SHOP DRAWINGS SUBMITTED BY THE FIRE ALARM CONTRACTOR.
- 27. CONTRACTOR SHALL COMPLY WITH "TRENCH SAFETY ACT" (FLORIDA STATUTE 553 PART III) AND OSHA STANDARD
 29 CFR 1926.650 SUBPART P FOR ALL UTILITY TRENCHES IN EXCESS OF 5 FEET DEEP.

- 1. INSTALL ALL WORK IN ACCORDANCE WITH THE FLORIDA BUILDING CODE 2010 EDITION WITH 2012 SUPPLEMENTS, THE NATIONAL CODE 2011 EDITION, AND ALL CODES, ORDINANCES, RULES AND REGULATIONS OF AUTHORITIES HAVING JURISDICTION AT THIS SITE. WHERE CONFLICTS OCCUR BETWEEN CODES AND THE CONSTRUCTION DOCUMENTS, THE MOST RESTRICTIVE REQUIREMENTS SHALL GOVERN. COMPLY WITH NFPA 70E, FFPC (2014), NFPA 101 (2012), NFPA 72 (2010), AND NFPA 110 (2010).
- 2. CONTRACTOR SHALL GUARANTEE THE WORK AND MATERIALS FOR A PERIOD OF ONE YEAR FROM DATE OF FINAL ACCEPTANCE. THIS GUARANTEE SHALL BE IN ADDITION TO THE WARRANTIES PROVIDED BY MATERIAL SUPPLIERS AND MANUFACTURERS.
- 3. ENTRY AND REMOVAL OF EQUIPMENT FROM THE BUILDING SHALL BE THE RESPONSIBILITY OF THE CONTRACTOR. CONTRACTOR SHALL REPAIR ANY DAMAGED MATERIALS TO THEIR ORIGINAL CONDITION. SURFACES SHALL BE REPAIRED TO MATCH THE EXISTING ADJACENT UNDAMAGED
- 4. ALL WIRING SYSTEMS SHALL BE COPPER CONDUCTORS IN METALLIC CONDUIT, UNLESS NOTED OTHERWISE. WIRE AND CONDUIT SIZES SHOWN ARE BASED ON THW COPPER, UNLESS NOTED OTHERWISE. FLEXIBLE METAL CONDUIT SHALL BE STEEL AND USED TO CONNECT EQUIPMENT WHERE INDICATED AND WHERE REQUIRED DUE TO VIBRATION AND CONNECTION ACCESSIBILITY.
- 5. ALL CONDUIT SHALL BE STRAPPED IN ACCORDANCE WITH REQUIREMENTS OF N.E.C.
- 6. CONTRACTOR SHALL BOND AND GROUND SYSTEMS AND EQUIPMENT PER ARTICLE 250 OF N.E.C. PROVIDE AN EGC SIZED IN ACCORDANCE WITH ARTICLE 250—122 N.E.C. ON ALL RECEPTACLES AND BRANCH CIRCUITS.
- 7. LIGHTING FIXTURES SHALL BE SECURELY FASTENED AND SUPPORTED PER N.E.C.
- 8. THE CONTRACTOR SHALL COORDINATE THE CIRCUIT REQUIREMENTS WITH THE MANUFACTURER OF THE ACTUAL EQUIPMENT FURNISHED UNDER OTHER DIVISIONS OF WORK. THE CIRCUIT BREAKER, WIRE AND CONDUIT SHALL BE SIZED AS RECOMMENDED BY THE EQUIPMENT MANUFACTURER.
- 9. ALL CIRCUIT BREAKERS SHALL BE BOLT-IN TYPE.
- 10. PROVIDE A LAMINATED PLASTIC NAMEPLATE IDENTIFYING EACH NEW PANELBOARD, MOTOR STARTER AND DISCONNECT. LETTERING SHALL BE 1/2" MINIMUM AND SHALL IDENTIFY EQUIPMENT SERVED, FEEDER, ORIGINATION AND CIRCUIT NUMBER. SECURE NAMEPLATE WITH SCREWS TO EQUIPMENT TO BE IDENTIFIED. PLASTIC TAPE IS NOT APPROVED.
- 11. ALL MISCELLANEOUS EQUIPMENT TO BE FURNISHED UNDER OTHER SECTIONS OF THE SPECIFICATIONS THAT REQUIRE ELECTRICAL CONNECTIONS SHALL BE RECEIVED AND SET WITH ROUGH—IN AND FINAL CONNECTIONS MADE UNDER THESE SECTIONS.

CONTRACTOR SHALL COORDINATE FIXTURE TYPE WITH ARCHITECTURAL FINISH SCHEDULE(S)

LIGHTING FIXTURE SCHEDULE

PHILIPS

PHILIPS

EQUAL

EQUAL

EQUAL EQUAL ECF-1-2-100LA-WW-120-BLP

101L-2-34-WW-UNIV-BRP

EQUAL


EQUAL

		VOLTAGE 12	OV UNLI	ESS NOTED OT	HERWISE
TYPE	MANUFACTURER	CATALOG NUMBER	L	AMPS (1)	REMARKS (2)
ITPE	MANUFACTURER	CATALOG NUMBER	NO.	TYPE	REMARKS (2)
A1	PHILIPS EQUAL EQUAL	2DLG34L840-2-D-UNV-DIM-EMLED16 EQUAL EQUAL	INC	LED	2' x 2' RECESSED, LED ARCHITECTURAL FIXTURE. LISTED FOR DAMP LOCATIONS. MINIMUM DELIVERED OUTPUT IS 3300 LUMENS AT 4000K. MAXIMUM WATTAGE IS 40 W. PROVIDE EM BALLAST WHERE INDICATED.
A2	PHILIPS EQUAL EQUAL	2DLG44L840-2-D-UNV-DIM-EMLED16 EQUAL EQUAL	INC	LED	2' x 2' RECESSED, LED ARCHITECTURAL FIXTURE. LISTED FOR DAMP LOCATIONS. MINIMUM DELIVERED OUTPUT IS 4300 LUMENS AT 4000K MAXIMUM WATTAGE IS 60 W. PROVIDE EM BALLAST WHERE INDICATED.
А3	PHILIPS EQUAL EQUAL	2DLF34L840-2-D-UNV-DIM-EMLED16 EQUAL EQUAL	INC	LED	2' x 2' RECESSED, LED ARCHITECTURAL FIXTURE. LISTED FOR DAMP LOCATIONS. MINIMUM DELIVERED OUTPUT IS 3300 LUMENS AT 4000K. MAXIMUM WATTAGE IS 40 W. PROVIDE EM BALLAST WHERE INDICATED.
В	WILLIAMS EQUAL EQUAL	75-4-LED*PH85/840-WG-7514-LED-UNV EQUAL EQUAL	INC	LED	4' LED STRIP WITH WIREGUARD. LISTED FOR DAMP LOCATIONS. MINIMUM DELIVERED OUTPUT IS 8500 LUMENS AT 4000 K. MAXIMUM WATTAGE IS 80 W.
С	BEGHELLI LITHONIA METALUX	BS100LED4HT50WWT41120-277VTM EQUAL EQUAL	INC	LED	4' LINEAR LED FIXTURE, UL LISTED FOR WET LOCATIONS. POLYCARBONATI HOUSING, LIQUID SILICONE PERIMETER GASKET. CORROSION, FLAME AND VANDAL RESISTANT.
Е	CHLORIDE EQUAL EQUAL	CXXL-3-R-W-DR EQUAL EQUAL	INC	LED	LED EXIT SIGN. LISTED FOR DAMP LOCATIONS. WHITE THERMOPLASTIC WITH RED LETTERS AND BATTERY BACKUP.
G	LIGHTOLIER EQUAL EQUAL	OM6LED-27120EM-R6LED30KWDCS EQUAL EQUAL	INC	LED	RECESSED, LED DOWNLIGHT 6" ROUND SUITABLE FOR WET LOCATION. MINIMUM DELIVERED OUTPUT IS 1400 LUMENS AT 3000 K. MAXIMUM WATTAGE IS 27 W.
Н	WILLIAMS EQUAL EQUAL	WMAUD-4-LEDPH32/840U/PH32/840D-AF-UNV EQUAL EQUAL	INC	LED	4' WALL MOUNT, LOW PROFILE INDIRECT/DIRECT FIXTURE MOUNT 7'-0" AFF. MINIMUM DELIVERED OUTPUT IS 3000 LUMENS AT 4000 K. MAXIMUM WATTAGE IS 80 W.
L	B-K LIGHTING EQUAL EQUAL	DELEDx23-FL-9-C-PM2 EQUAL EQUAL	INC	LED	ACCENT LIGHT LED, ADJUSTABLE FLOOD. MINIMUM DELIVERED OUTPUT IS 600 LUMENS AT 4000 K. MAXIMUM WATTAGE IS 20 W.

LIGHT FIXTURES DEEMED EQUAL TO THOSE SPECIFIED SHALL BE SUBMITTED FOR APPROVAL IN ACCORDANCE WITH THE SPECIFICATIONS.

LED

LED

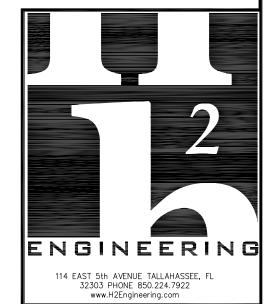

LED POLE MOUNTED FIXTURE MOUNTED ON 20' POLE ON CONCRETE

PROVIDE FIVE YEAR WARRANTY.

BASE. MINIMUM 11,000 LUMENS AT 3000K COLOR TEMP. TYPE II DIST.

TRAPEZOIDAL LED WALL SCONCE. LISTED FOR USE IN WET LOCATION.

DIE CAST ALUMINUM HOUSING AND TEMP. GLASS LENS. 5 YR WARRANTY

MINIMUM 3400 LUMENS DELIVERED AT 3000K COLOR TEMPERATURE.

32303 PHONE 850.224.7922

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100% CONSTRUCTION DOCUMENTS

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Drawn By: SYC Checked By: PCL


Date: 10 JUNE 2015

Project No.: 14033

Drawing Title:


GENERAL NOTES AND SCHEDULES -ELECTRICAL

Drawing No.: **E0.2**

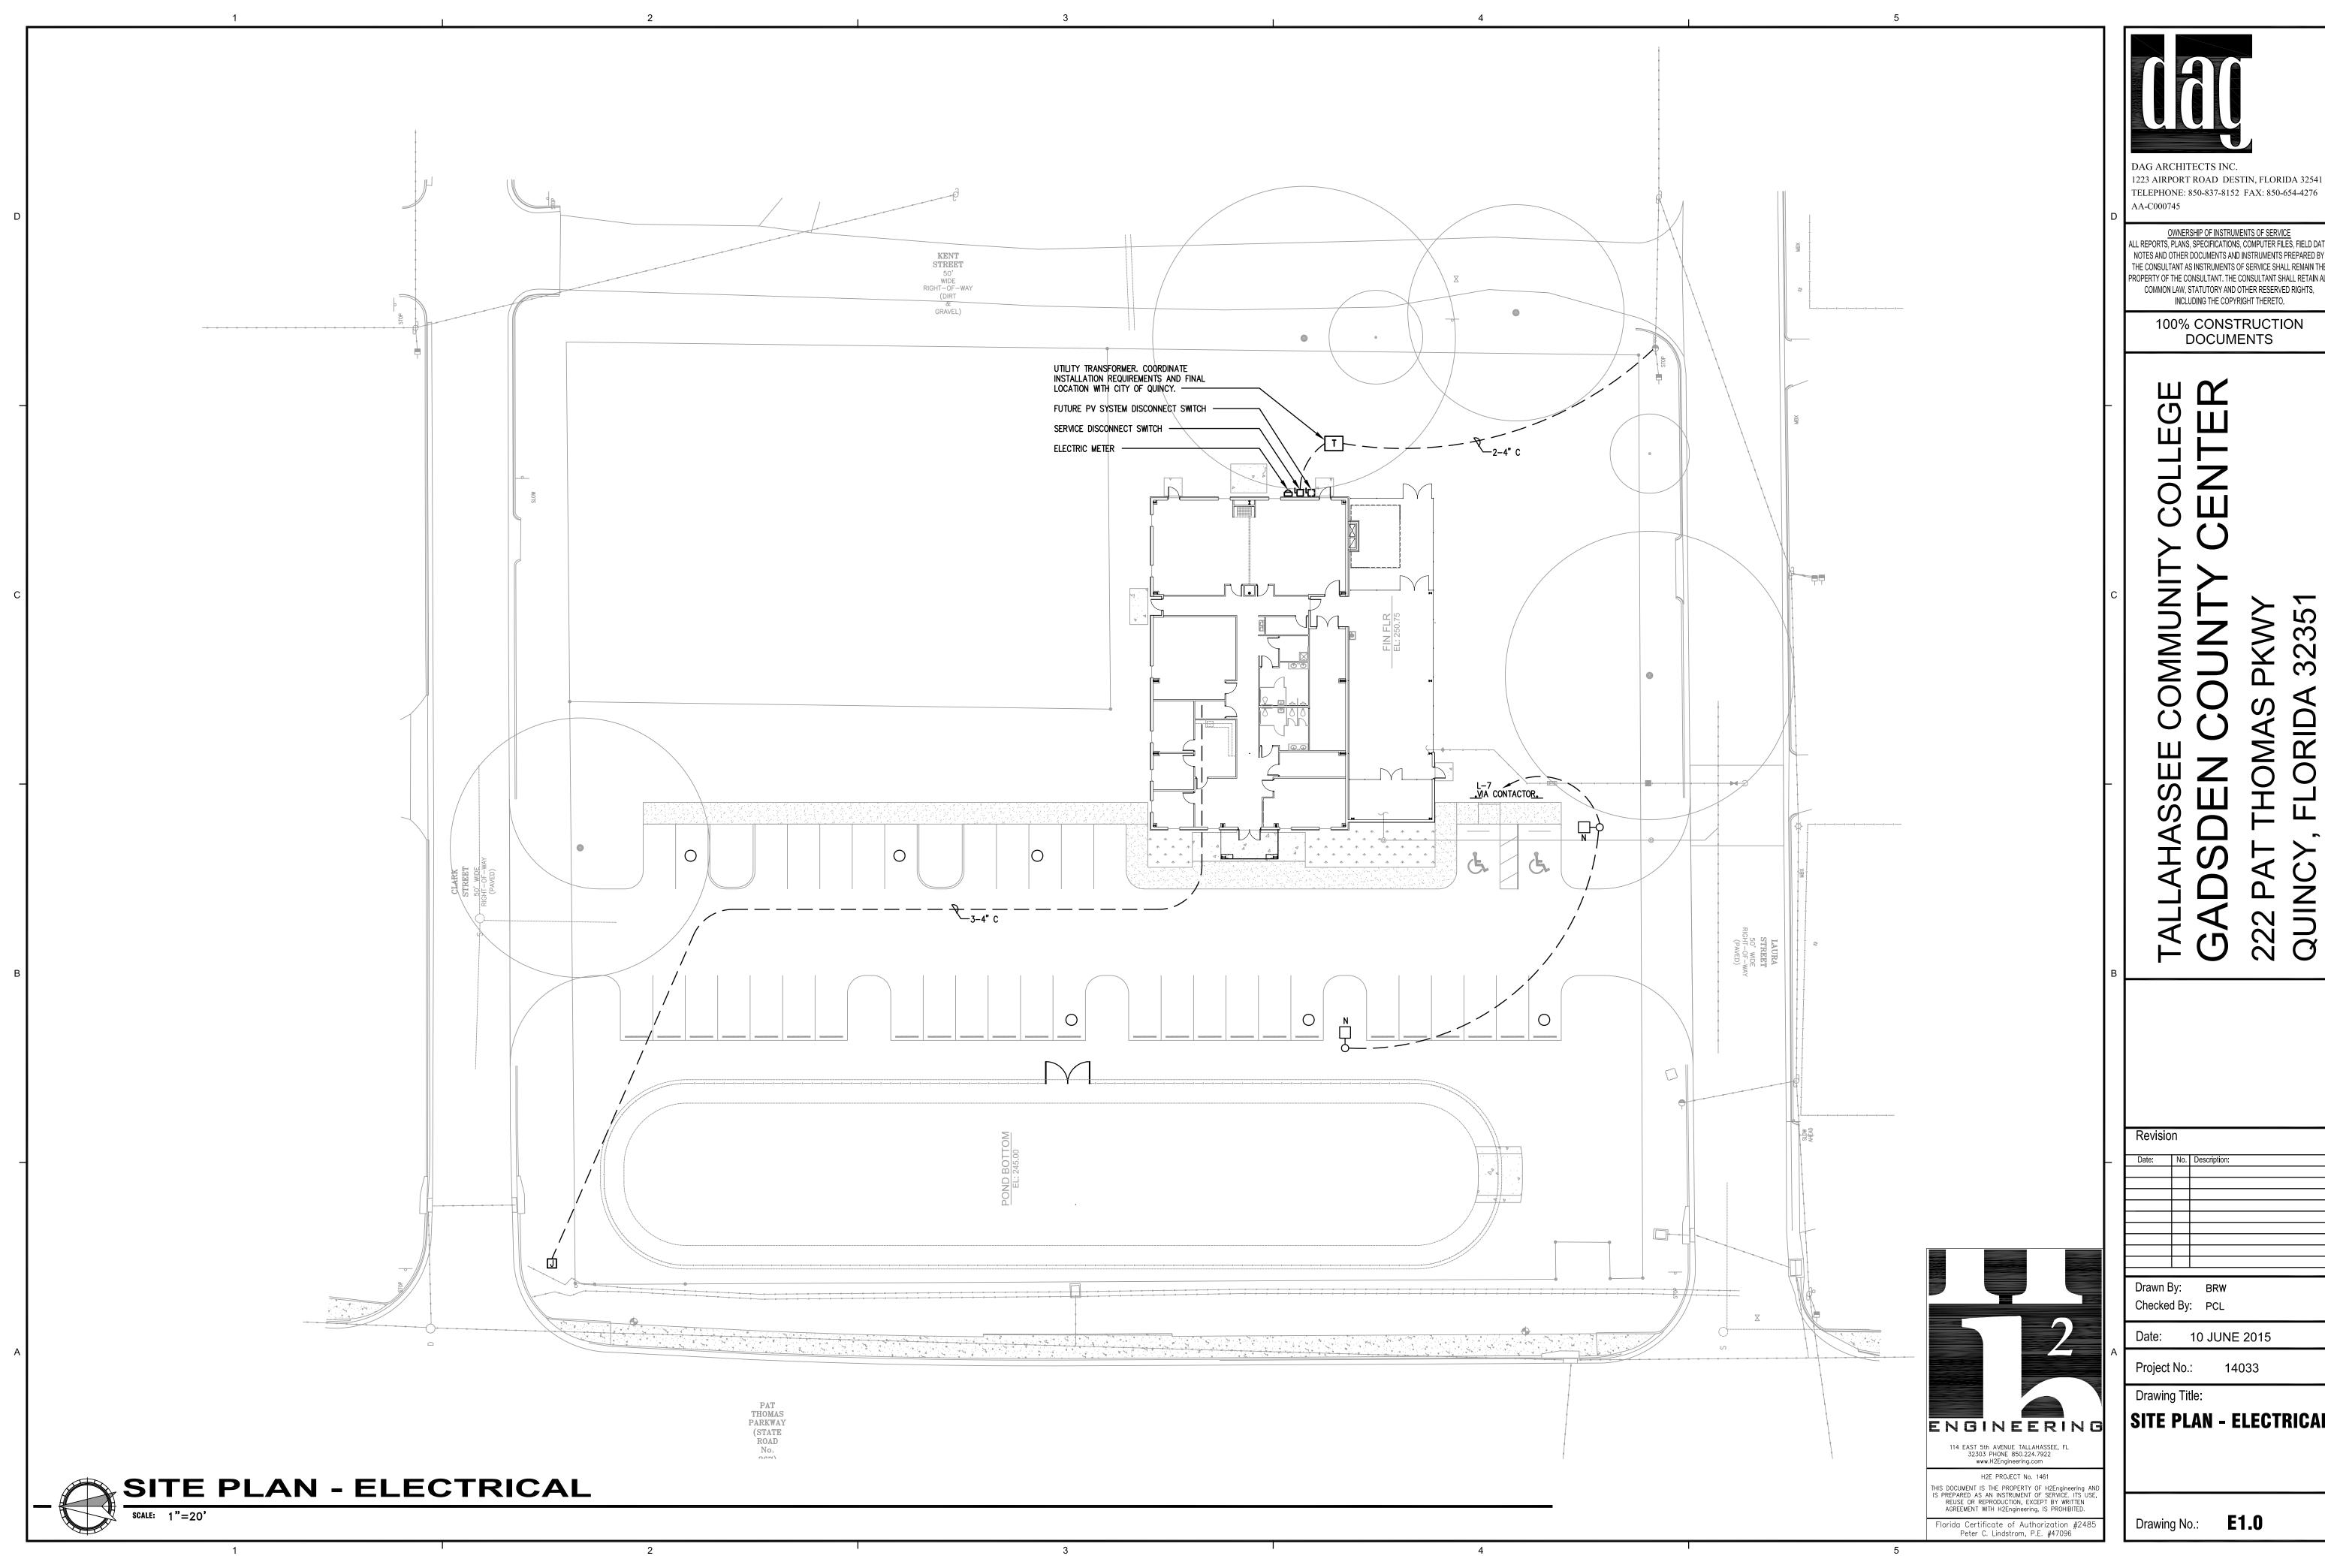

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SITE PLAN - ELECTRICAL



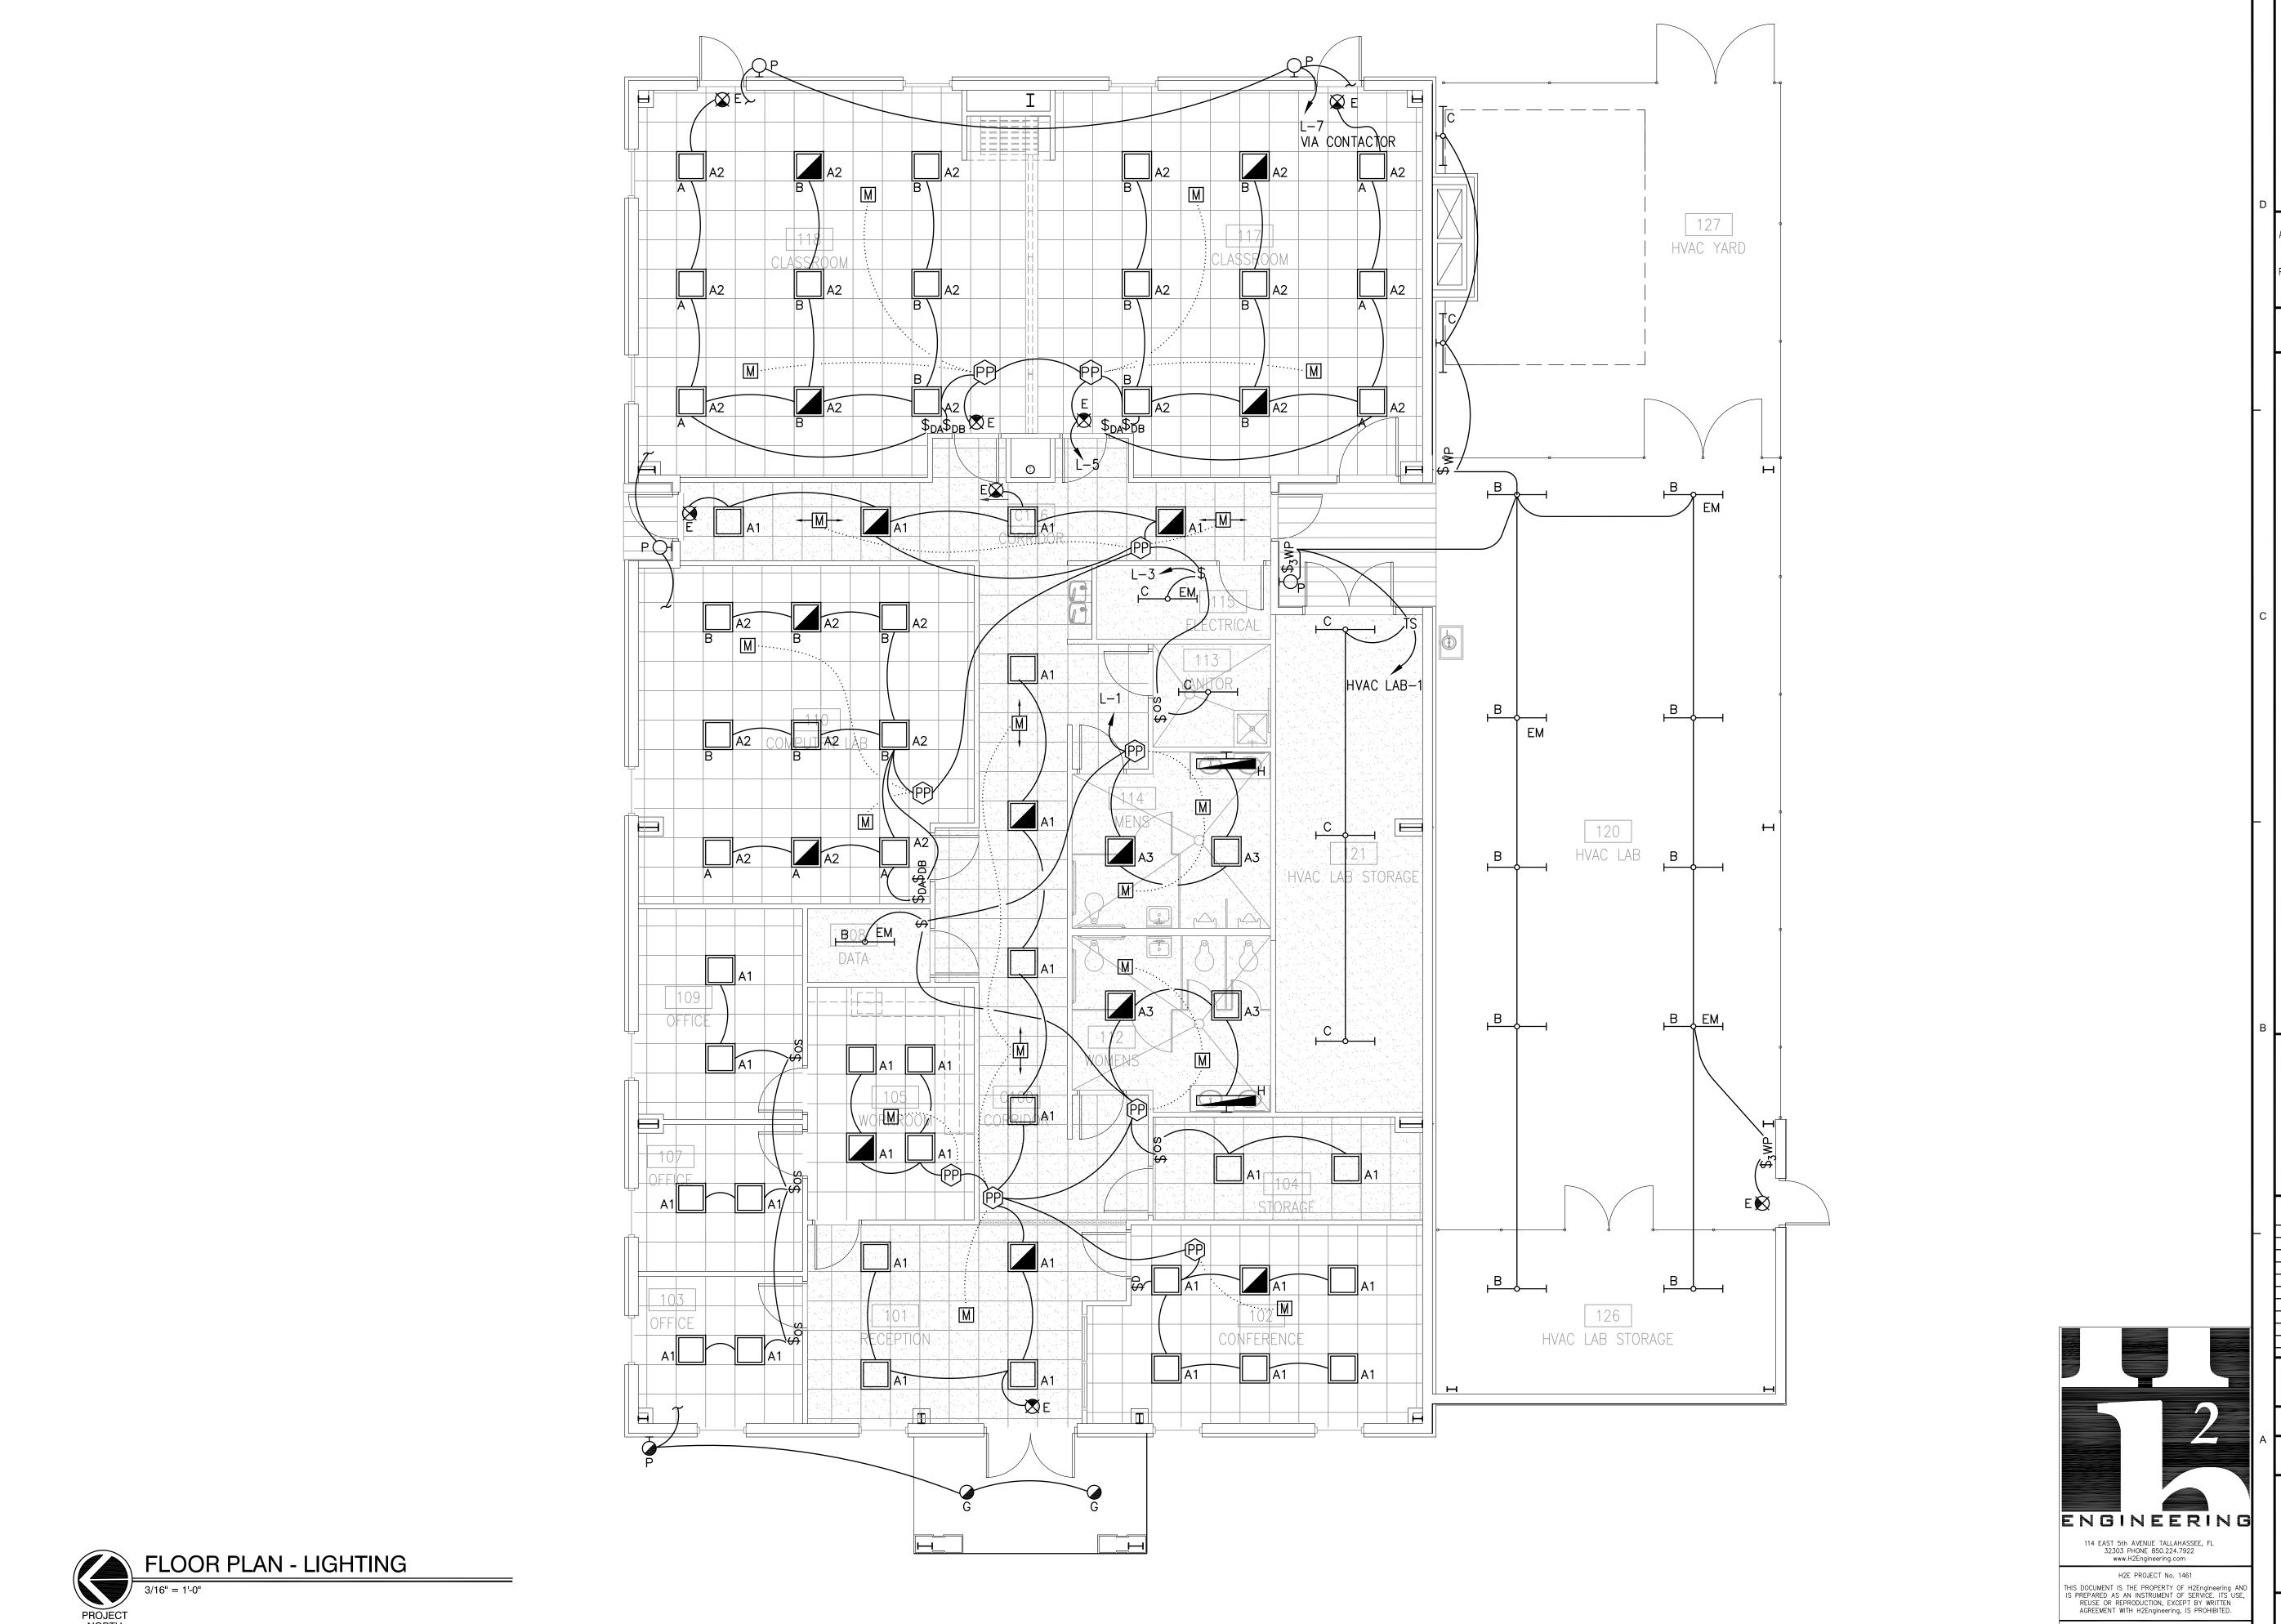

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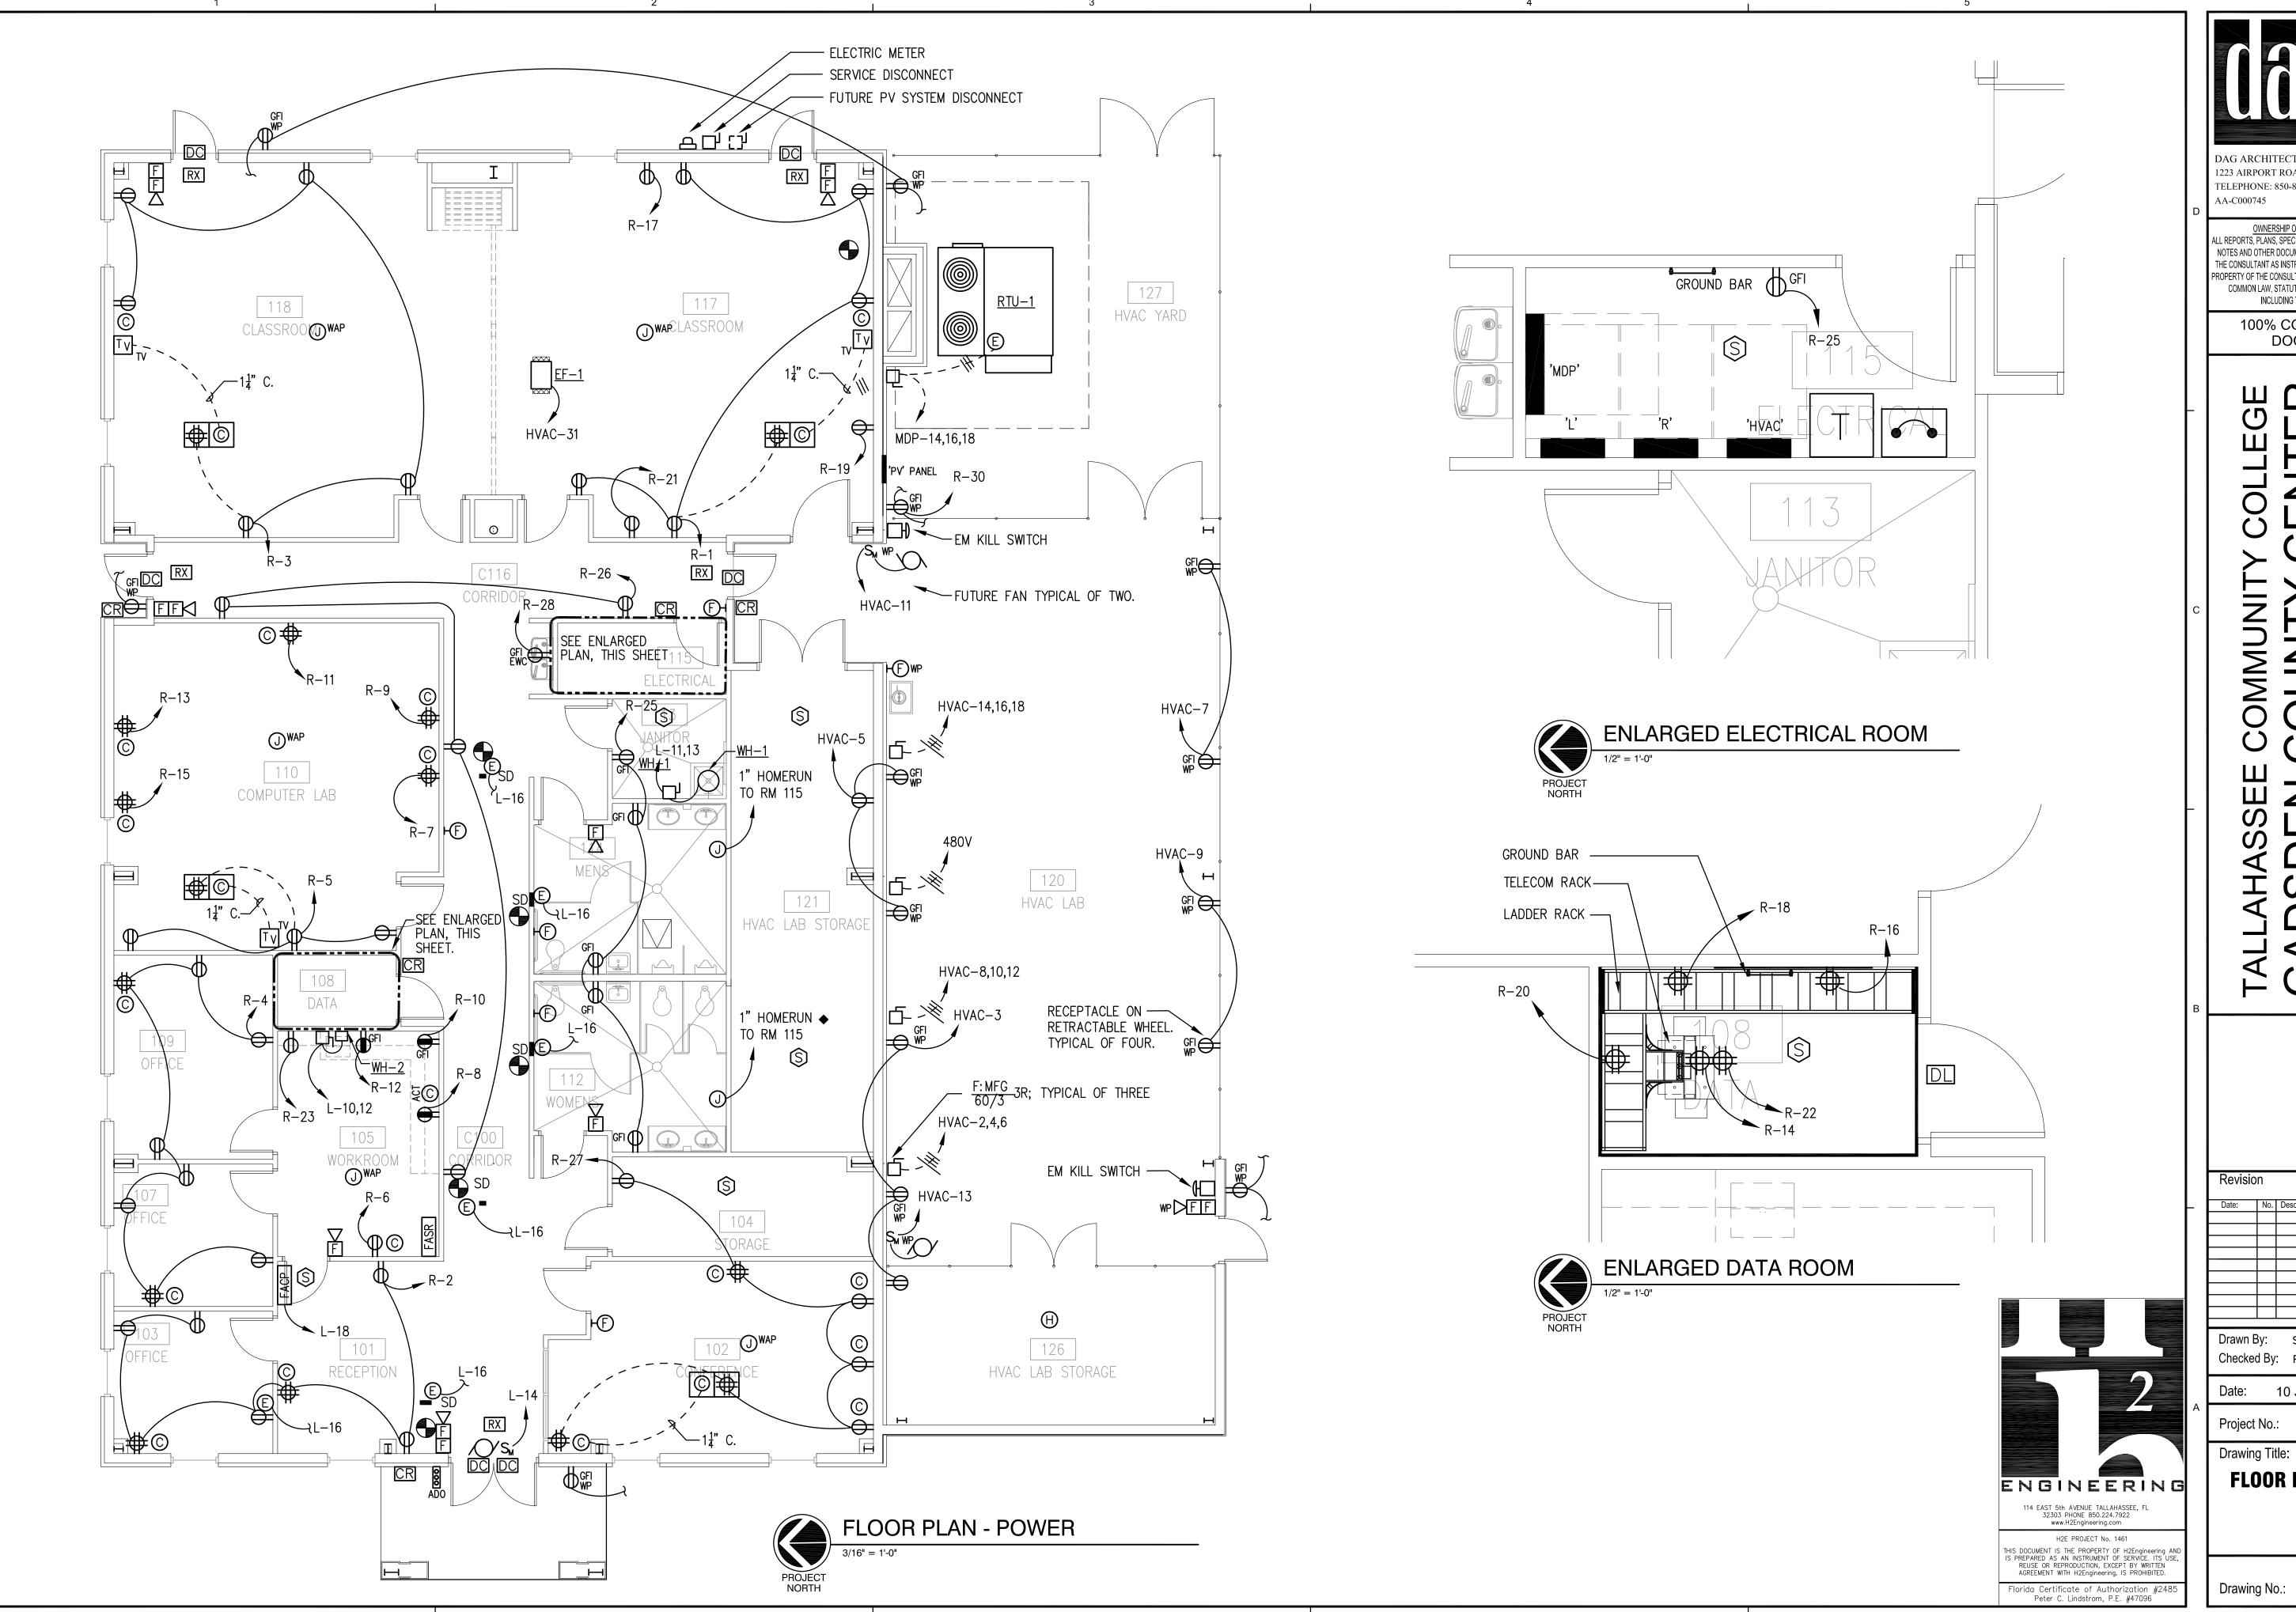
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Drawing Title:

FLOOR PLAN - LIGHTING

Drawing No.: **E1.1**

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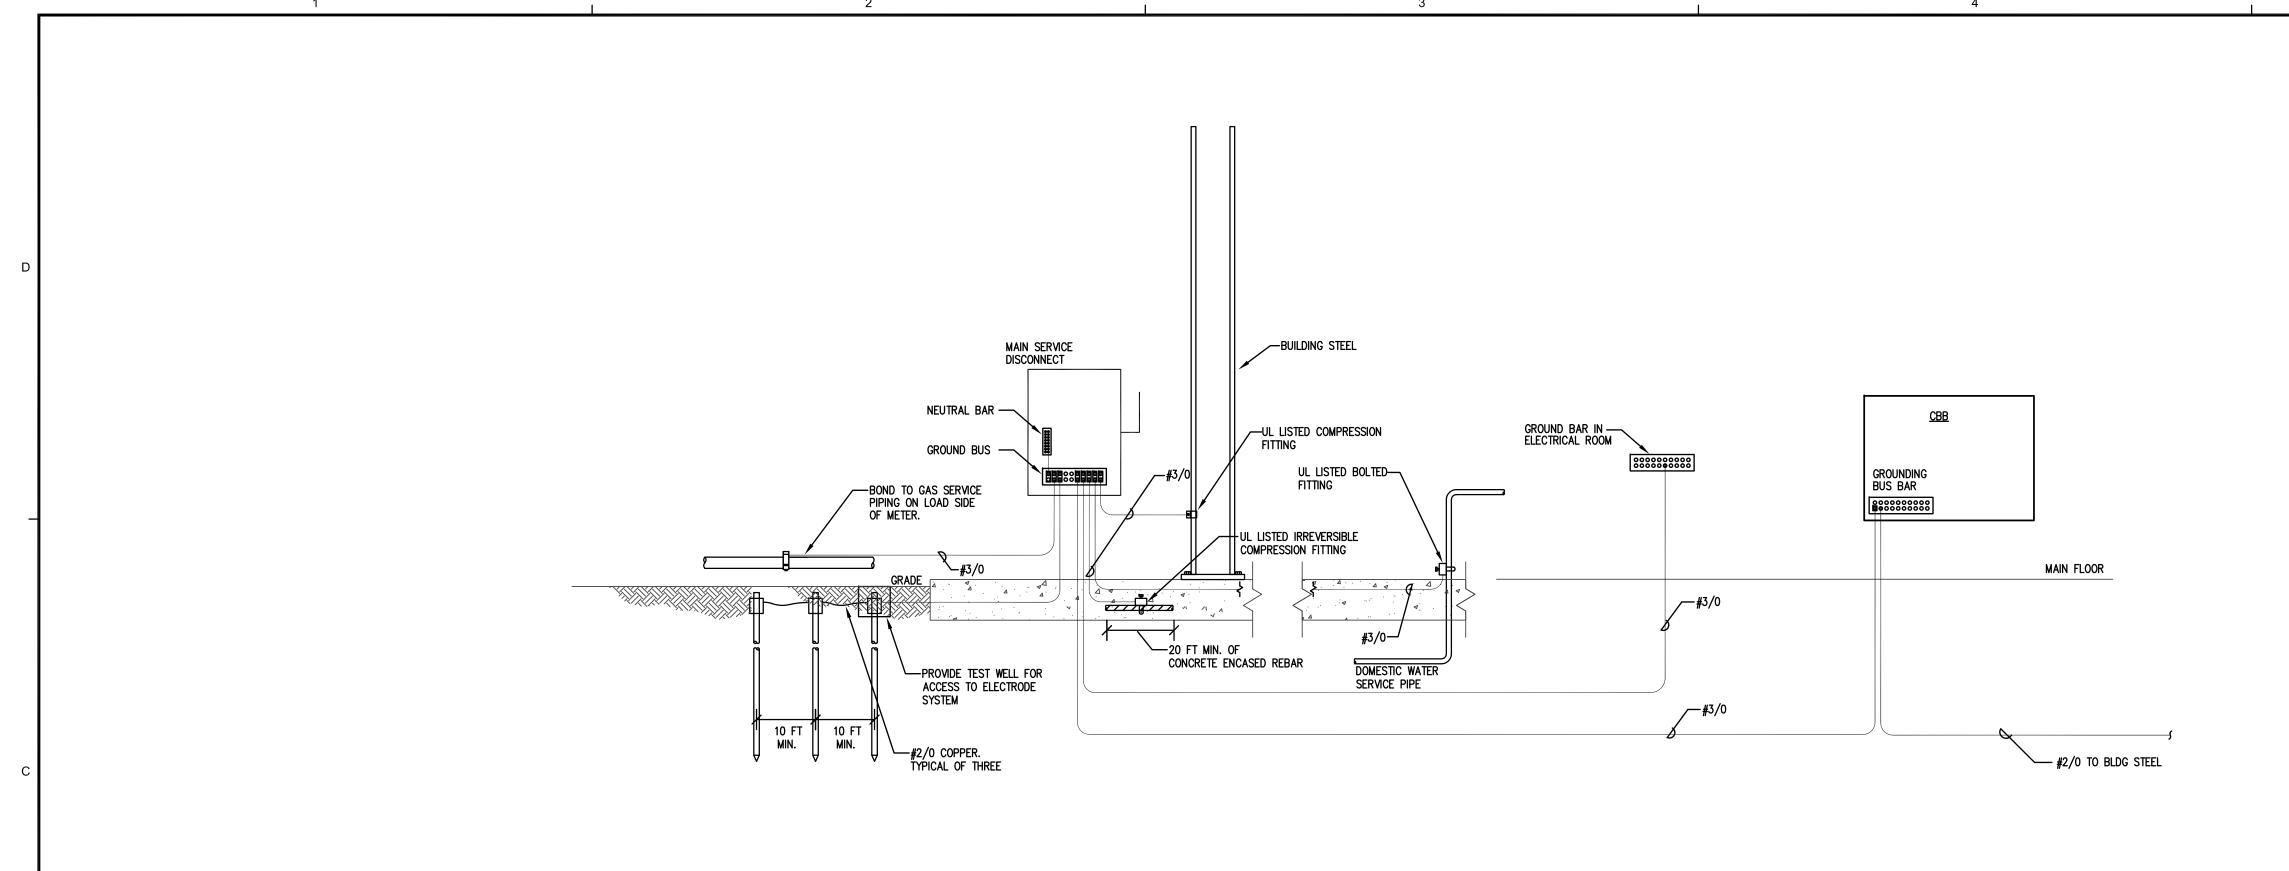
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Date: 10 JUNE 2015

Project No.: 14033


FLOOR PLAN - POWER

Drawing No.: **E2.1**



RISER DIAGRAM - GROUNDING

NO SCALE

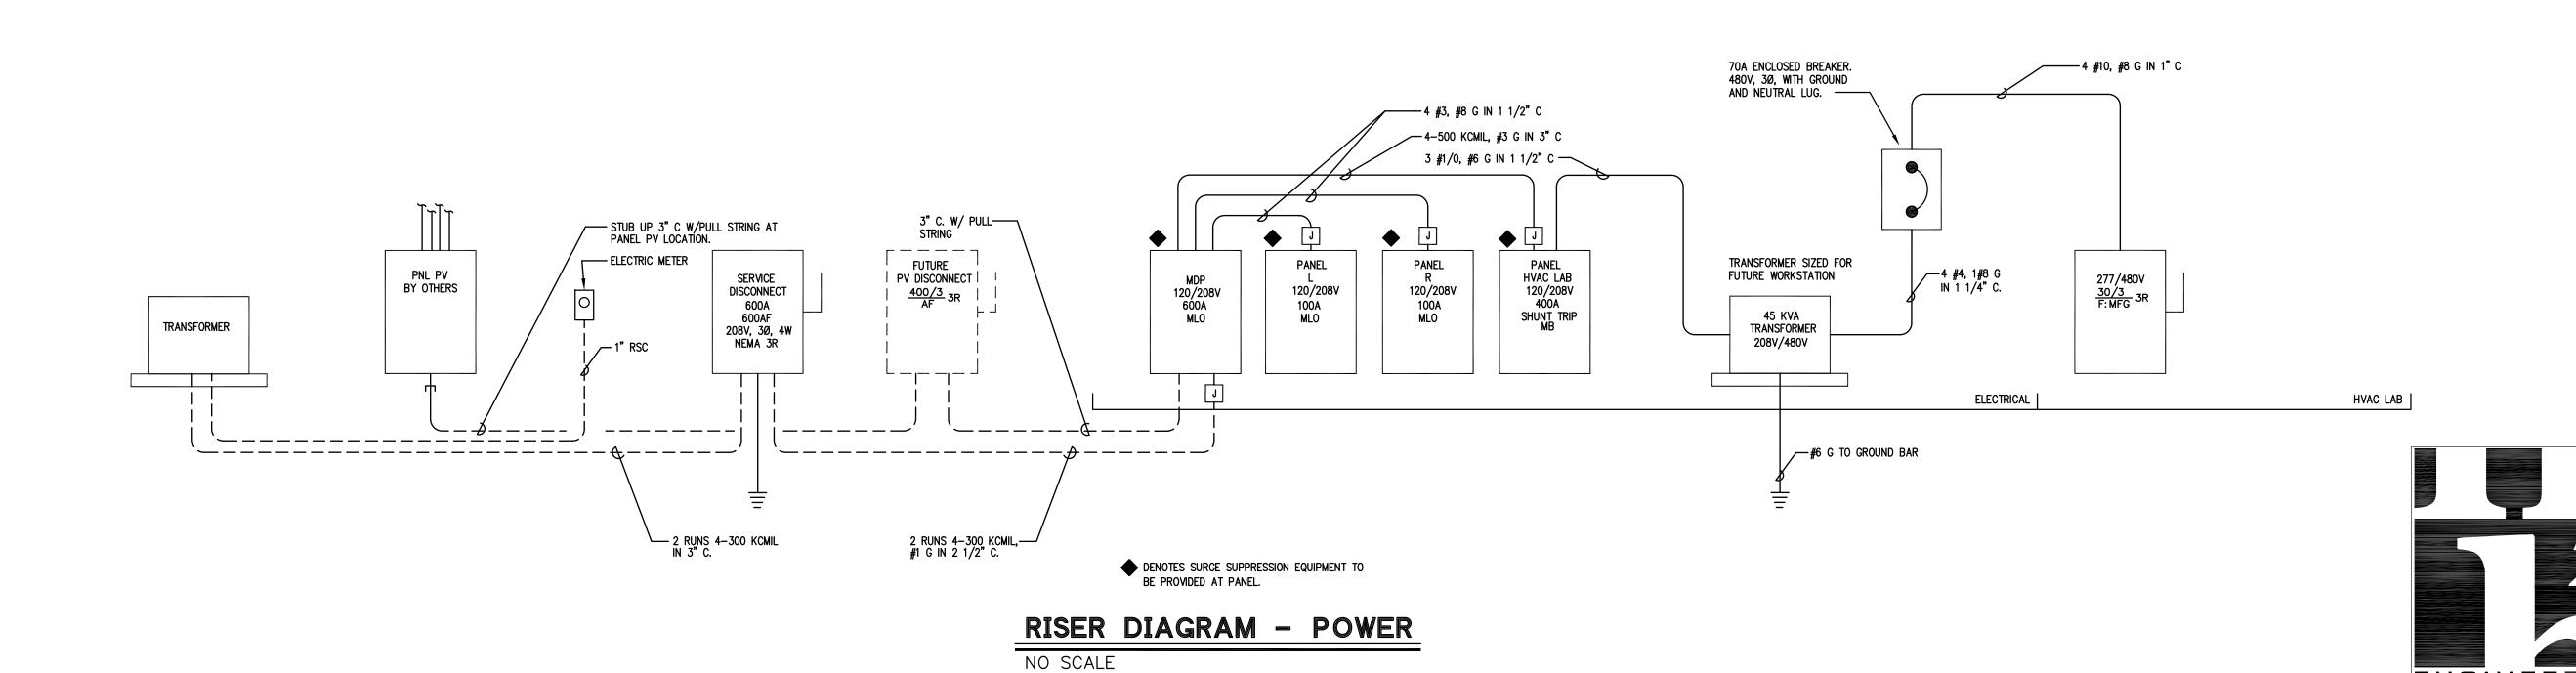



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Drawn By: SYC Checked By: PCL

Date: 10 JUNE 2015

Project No. 14033

Drawing Title:

RISER DIAGRAM -ELECTRICAL

Drawing No.: **E3.1**

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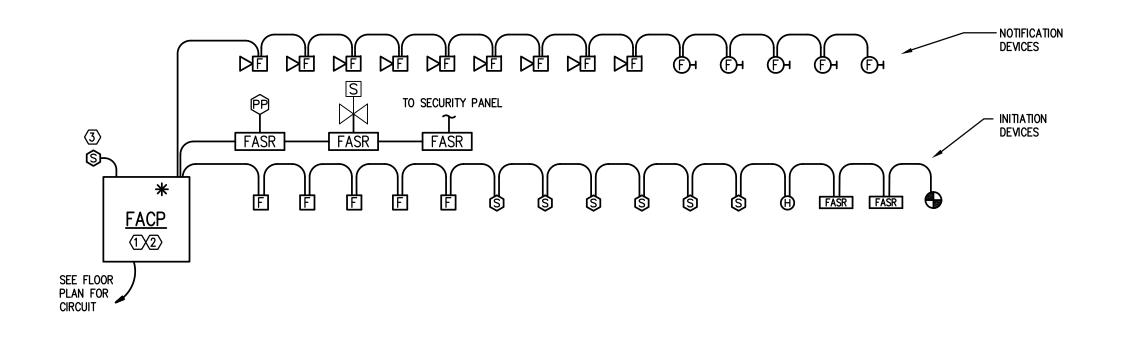
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ENGINEERING

CEILING — 1" CONDUITS TO COMM ROOM 1" CONDUITS TO COMM ROOM— #6 COPPER BONDING CONDUCTOR CONNECTED - CABLE TRAY — 1" CONDUITS TO COMM ROOM 1" CONDUITS TO COMM ROOM (TYPICAL) TO LADDER RACK WITH ightharpoonup to building steel \parallel BOLTED CONNECTION. #2 BARE CU TO MAIN SVC}— DISCONNECT 3 - 3°C RM. 118 TYPICAL DEVICES TYPICAL DEVICES MAIN COMM. ROOM MAIN FLOOR

RISER DIAGRAM - COMMUNICATIONS

NO SCALE




RISER DIAGRAM - FIRE ALARM

NO SCALE

3 - 4"C. SEE SITE PLAN

IRE ALARM SEQ	UEN	CE	EC	F	0	PE	:R/	ΑT		1				FIRE ALARM NOTES
EVENT SMOKE DETECTOR HEAT DETECTOR DUCT DETECTOR MANUAL PULL STATION	•	\rightarrow	● NITIATE !	TROUBLE AT FACP	TROUBLE NOTIFICATION OFF SITE				\$070 •	● ● RELEAS)	ACTIVATE EMERGENCY LIGHTING	<u>COMMENTS</u>	 ALL FIRE ALARM JUNCTION BOX COVERS SHALL BE PAINTED RED. ALL SPLICES SHALL BE MADE WITH CRIMP CONNECTORS. NO WIRE NUTS SHALL BE USED. ALL MAIN JUNCTION BOXES AND TERMINAL CABINETS SHALL BE PROVIDED WITH TERMINAL BLOCKS FOR ALL TERMINATION. ALL INITIATING DEVICES WITH SCREW TERMINALS SHALL BE CONNECTED TO THE WIRING SYSTEM WITH SPADE TERMINALS. THE NUMBER AND TYPE OF CONDUCTORS TO BE PROVIDED IN THE FIRE ALARM SYSTEM RACEWAYS SHALL BE SHOWN ON THE FIRE ALARM DELEGATED DESIGN SUBMITTAL. CONDUIT SHALL BE 3/4" UNLESS NOTED OTHERWISE. * INCLUDES BATTERY BACK—UP. RISER DIAGRAM IS DIAGRAMMATICAL IN NATURE AND DOES NOT SHOW EVERY DEVICE ASSOCIATED WITH THE SYSTEM. THE FIRE ALARM CONTRACTOR SHALL SUBMIT A COMPLETE ONE LINE INDICATING EVERY DEVICE INTEGRATED WITH THE FIRE ALARM SYSTEM.
WIRING FAULT				0	0	+	+	+	+					
AC POWER FAILURE		\neg				0	0	十						7) PROVIDE 120V POWER AS REQUIRED FOR FIRE PANEL. COORDINATE WITH THE INSTALLED EQUIPMENT.
ALARM SILENCE											0			
														(2) PROVIDE TYPE 3A SURGE PROTECTION DEVICES FOR EACH INITIATION AND NOTIFICATION CIRCUITS THAT SERV DEVICES ON THE BUILDING EXTERIOR AND IN THE HVAC LAB. SURGE PROTECTIVE DEVICE LOCATIONS SHALL BE INDICATED ON FIRE ALARM SHOP DRAWINGS.
	- 1	Т			1		1		- 1					

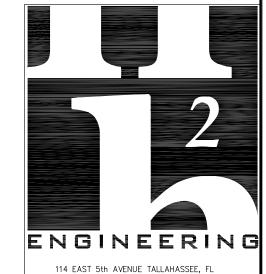

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NOTES

- TERMINATE ALL TELECOM BONDING CONDUCTORS ON TWO-HOLE, LONG BARREL, COMPRESSION LUGS.
- 2. PROVIDE #2 BARE COPPER CONDUCTOR TERMINATED WITH EXOTHERMIC WELD ON BUILDING STEEL IN EACH COMMUNICATIONS ROOM. TERMINATE OTHER END OF CONDUCTOR WITH TWO-HOLE, LONG BARREL, COMPRESSION LUG.



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DOCUMENTS

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_	Date:	No.	Description:
	Drawn E	Ву:	SYC

Checked By: PCL

Date: 10 JUNE 2015

Project No.: 14033

Drawing Title:

RISER DIAGRAM -**SYSTEMS**


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3			61					þ		$ \cdot $	þ					208			4
5			36					Y			9					211			6
7	PANEL L		23			100		3 γ] þ		γ 3		400				FUTURE	PV SYSTEM	8
9			29					þ		$ \cdot $	þ						DISCONN	ECT	10
11			26					١			4								12
13	SURGE SU	PPRESSION	_	1"	8	30		3 p] þ		γ 3		40	8	1"	25	AHU- DI	SCONNECT	14
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	REC. RM 117	11	3/4	" 10	20		1	P		1		20	10	3/4"	14	REC. RM 101, 10)3	2
5	RM 118	11]							16	RM 107, 10	09	4
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5	RM 112-115	9] 							6	RM C100,	C116 :	26
7	RM 102, 104	15					,] {	$\left \cdot \right $						2	WATER FOL		28
9	SURGE SUPPRESSION	_	1"	8	30		3 p		 	ļ					8	EXTERIOR		30
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1																	T	42

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1	LTS - 101-105, ECT.	7	1/2"	12	20		1	7	\prod	γ3		30	8	1'	_	SURG	E SUPP	RESSION	2
3	LTS - 110, 113, ECT.	4							$ \cdot $	À									T 4
5	LTS - 117, 118	6								۹ ا									
7	LTS - EXTERIOR	3	1"					╛	·	1		20				SPARE			
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	=18,000 AIC RMS SYM	I	I	<u> </u>	I											Γ		
CIRCUIT	SERVING	CONN.	COND. SIZE	WRE SIZE	CKT. BKR.	BREA CLASS	AKER POLE	PH/ AE	ASE BC	CKT. POLE	BRE A	KER BKR.	WIRE SIZE	COND. SIZE	CONN. LOAD	SE	RVING	CIRCUIT
1	LIGHTS HVAC LAB	6	3/4"	12	20		1	þ	П	γ 3		60	6	1"	30	HVAC LAB	DISCONNECT	2
3	REC. HVAC LAB, RM 126	5						<	}	À					30			4
5	HVAC LAB, RM 121	5								•					30			6
7	HVAC LAB	3						þ		ρ3		60	6	1"	30	HVAC LAB	DISCONNECT	8
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DOCUMENTS

Revision Date: No. Description:

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Date: 10 JUNE 2015

Project No.: 14033

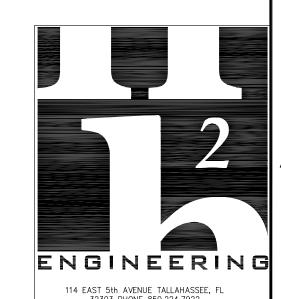Drawing Title:

PANEL SCHEDULES -ELECTRICAL

Drawing No.: **E4.1**

